


© Crown copyright and database rights 2023 Ordnance Survey 0100031673

This document is issued for the party which commissioned it and for specific purposes connected with the captioned project only. It should not be relied upon by any other party or used for any other purpose.
We accept no responsibility for the consequences of this document being relied upon by any other party, or being used for any other purpose, or containing any error or omission which is due to an error or omission in data supplied to us by other parties.

Dwg Title: Planning Drawings
Minffordd CSE Compound
Proposed Site Plan

Site: Glaslyn Cable Uprating	A1 100%	CAD
Originator Dwg No: GLAS-ARUP-71-XX-DR-X-9240	Proj Ref: 295280-00	
NG Investment No:		
NG Dwg No:	Sheet No:	Total No. of Sheets
	1	2
Scale: 1:250		Issue: C

Draft WIP

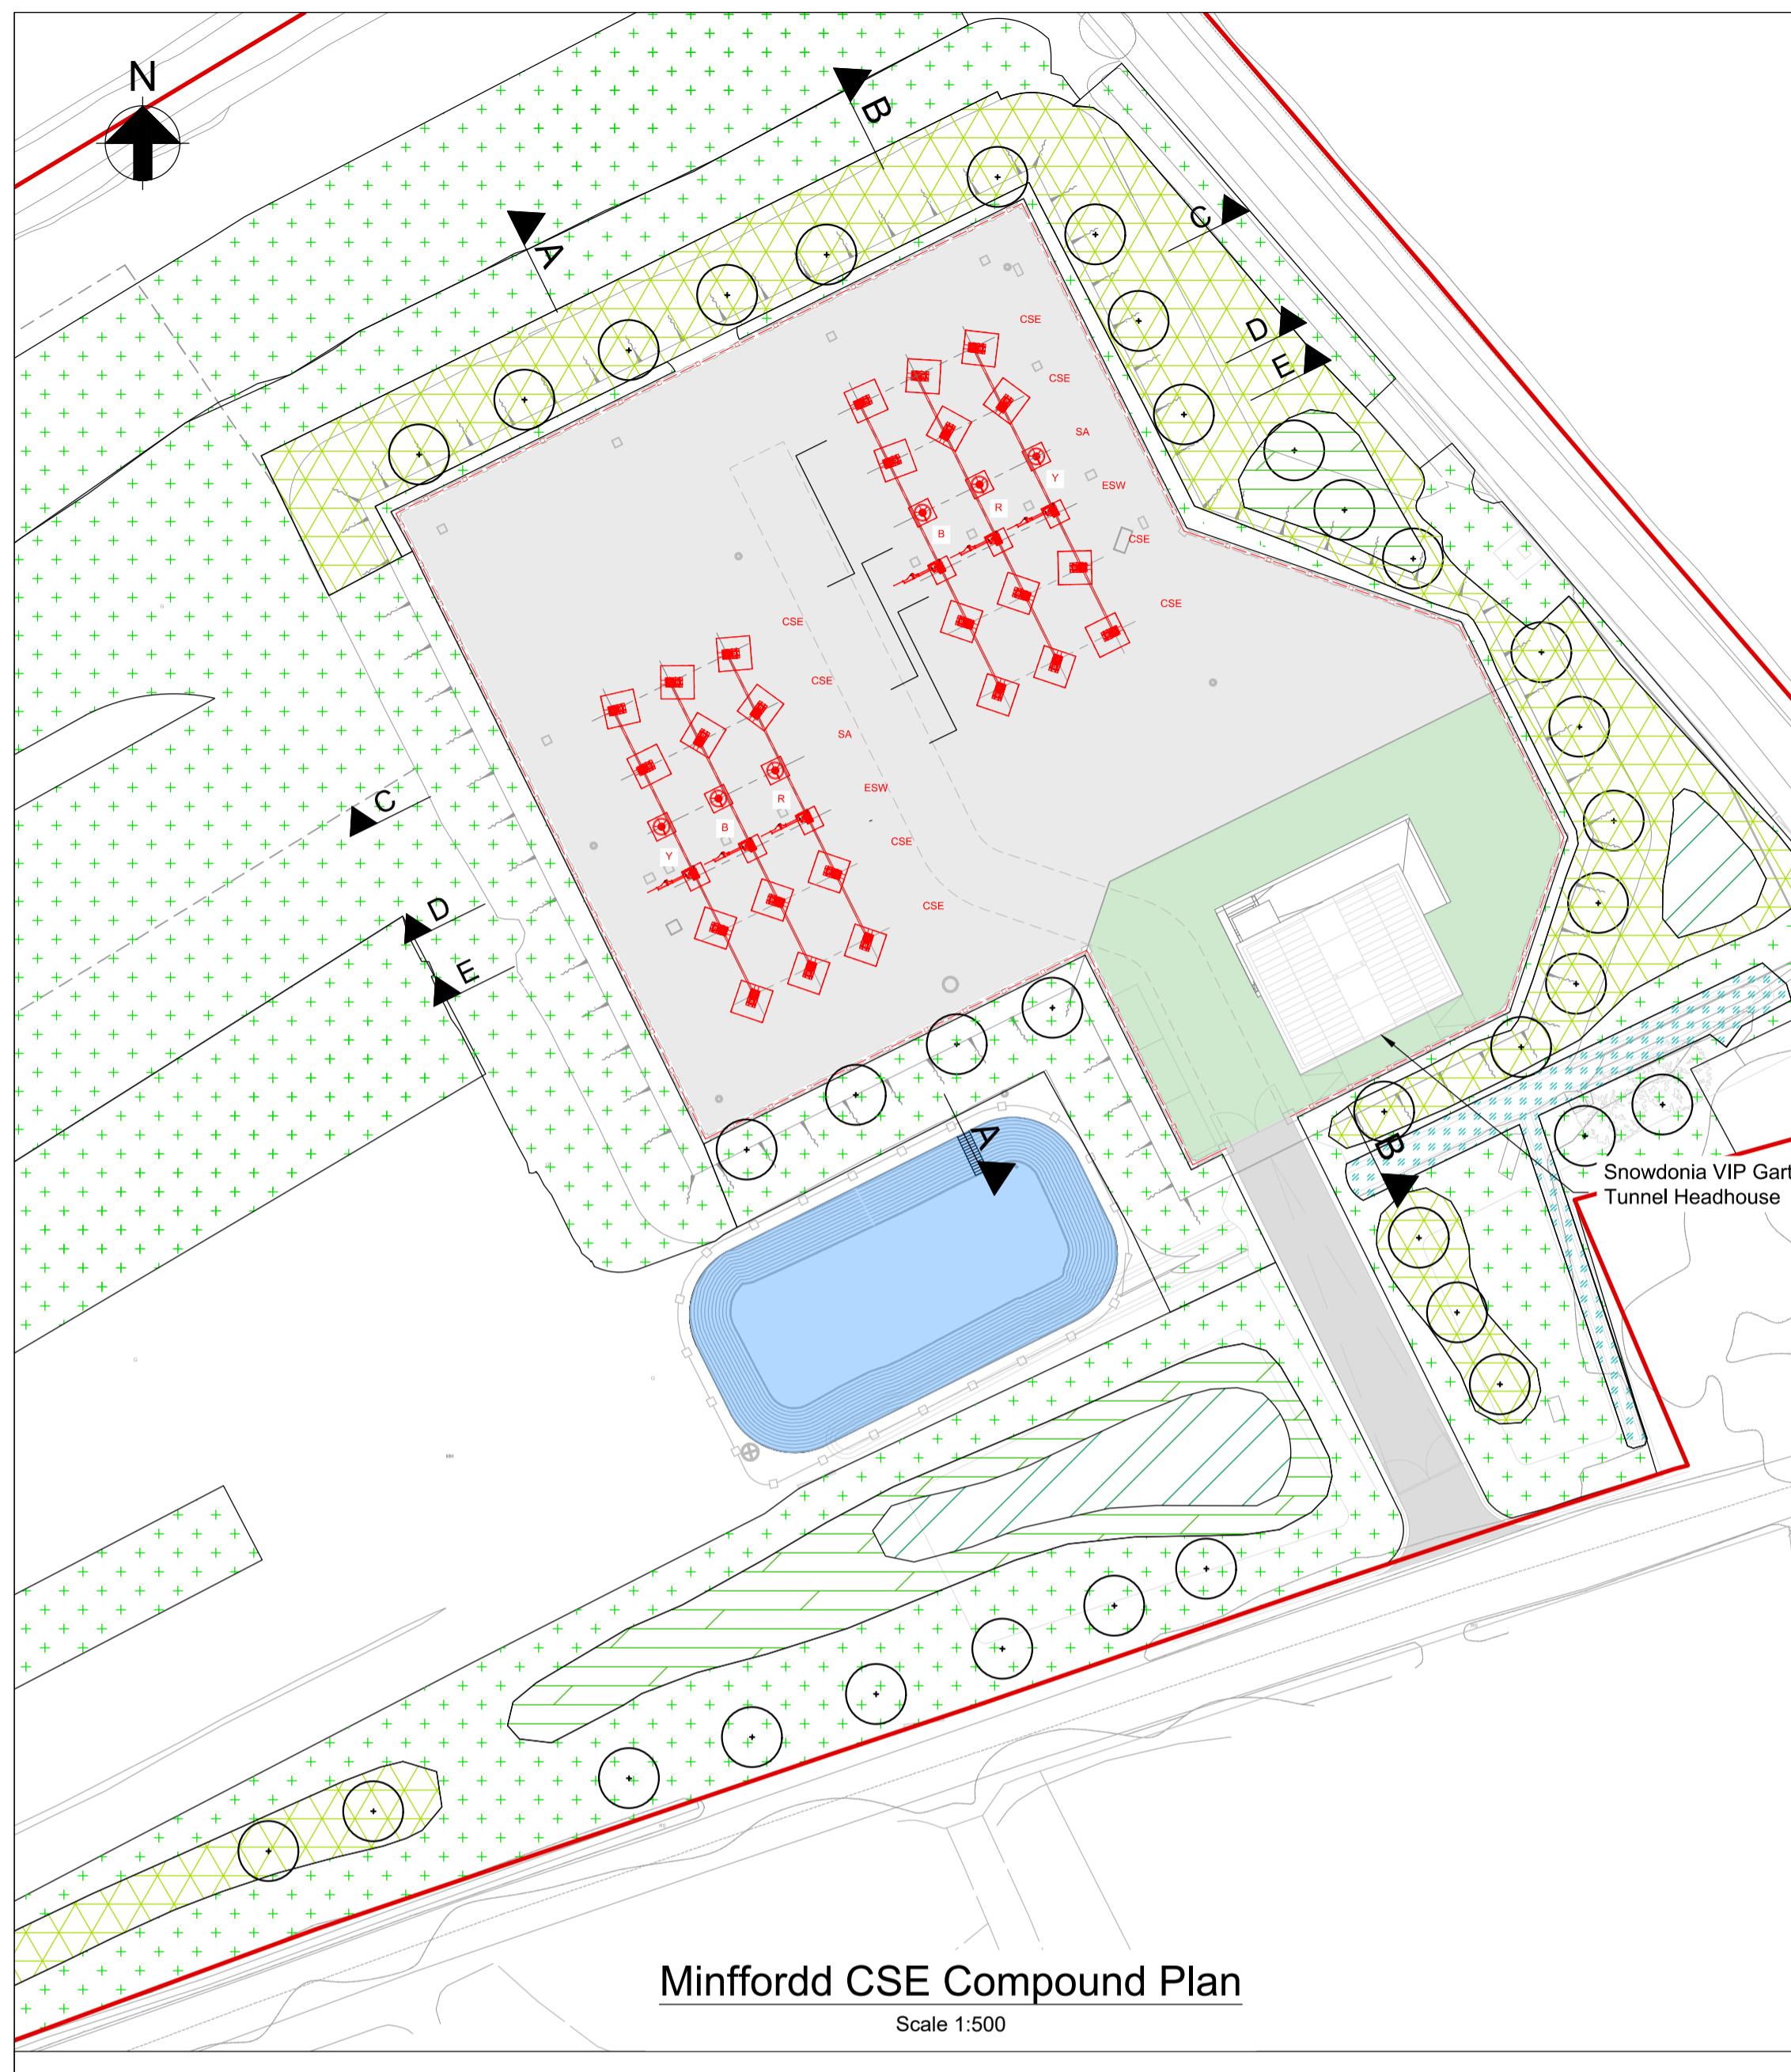

© Crown copyright and database rights 2023 Ordnance Survey 0100031673
MURPHY
WORLD-CLASS INFRASTRUCTURE

nationalgrid

ARUP



J. MURPHY & SONS LTD
Hiview House, Highgate Road, London NW5 1TN

National Grid
National Grid plc, Warwick Technology Park, Gallows Hill, Warwick, CV34 6DA

8 Fitzroy Street, London
W1T 4BJ, United Kingdom
Tel +44(0)20 7636 1531 Fax +44(0)20 7580 3924
www.arup.com

ISSUE DATE DRAWN CHECKED APPROVED REMARKS

This document is issued for the party which commissioned it and for specific purposes connected with the captioned project only. It should not be relied upon by any other party or used for any other purpose.
We accept no responsibility for the consequences of this document being relied upon by any other party, or being used for any other purpose, or containing any error or omission which is due to an error or omission in data supplied to us by other parties.

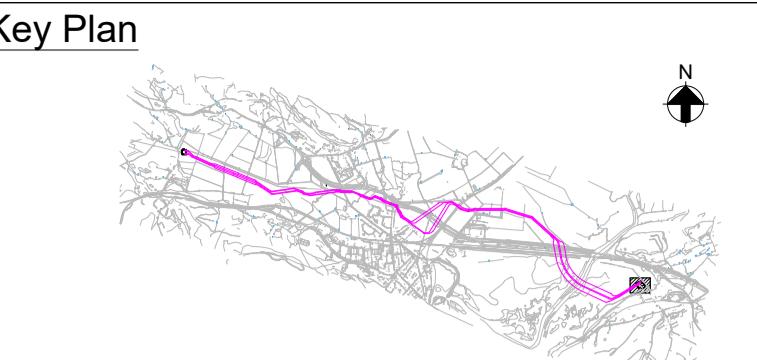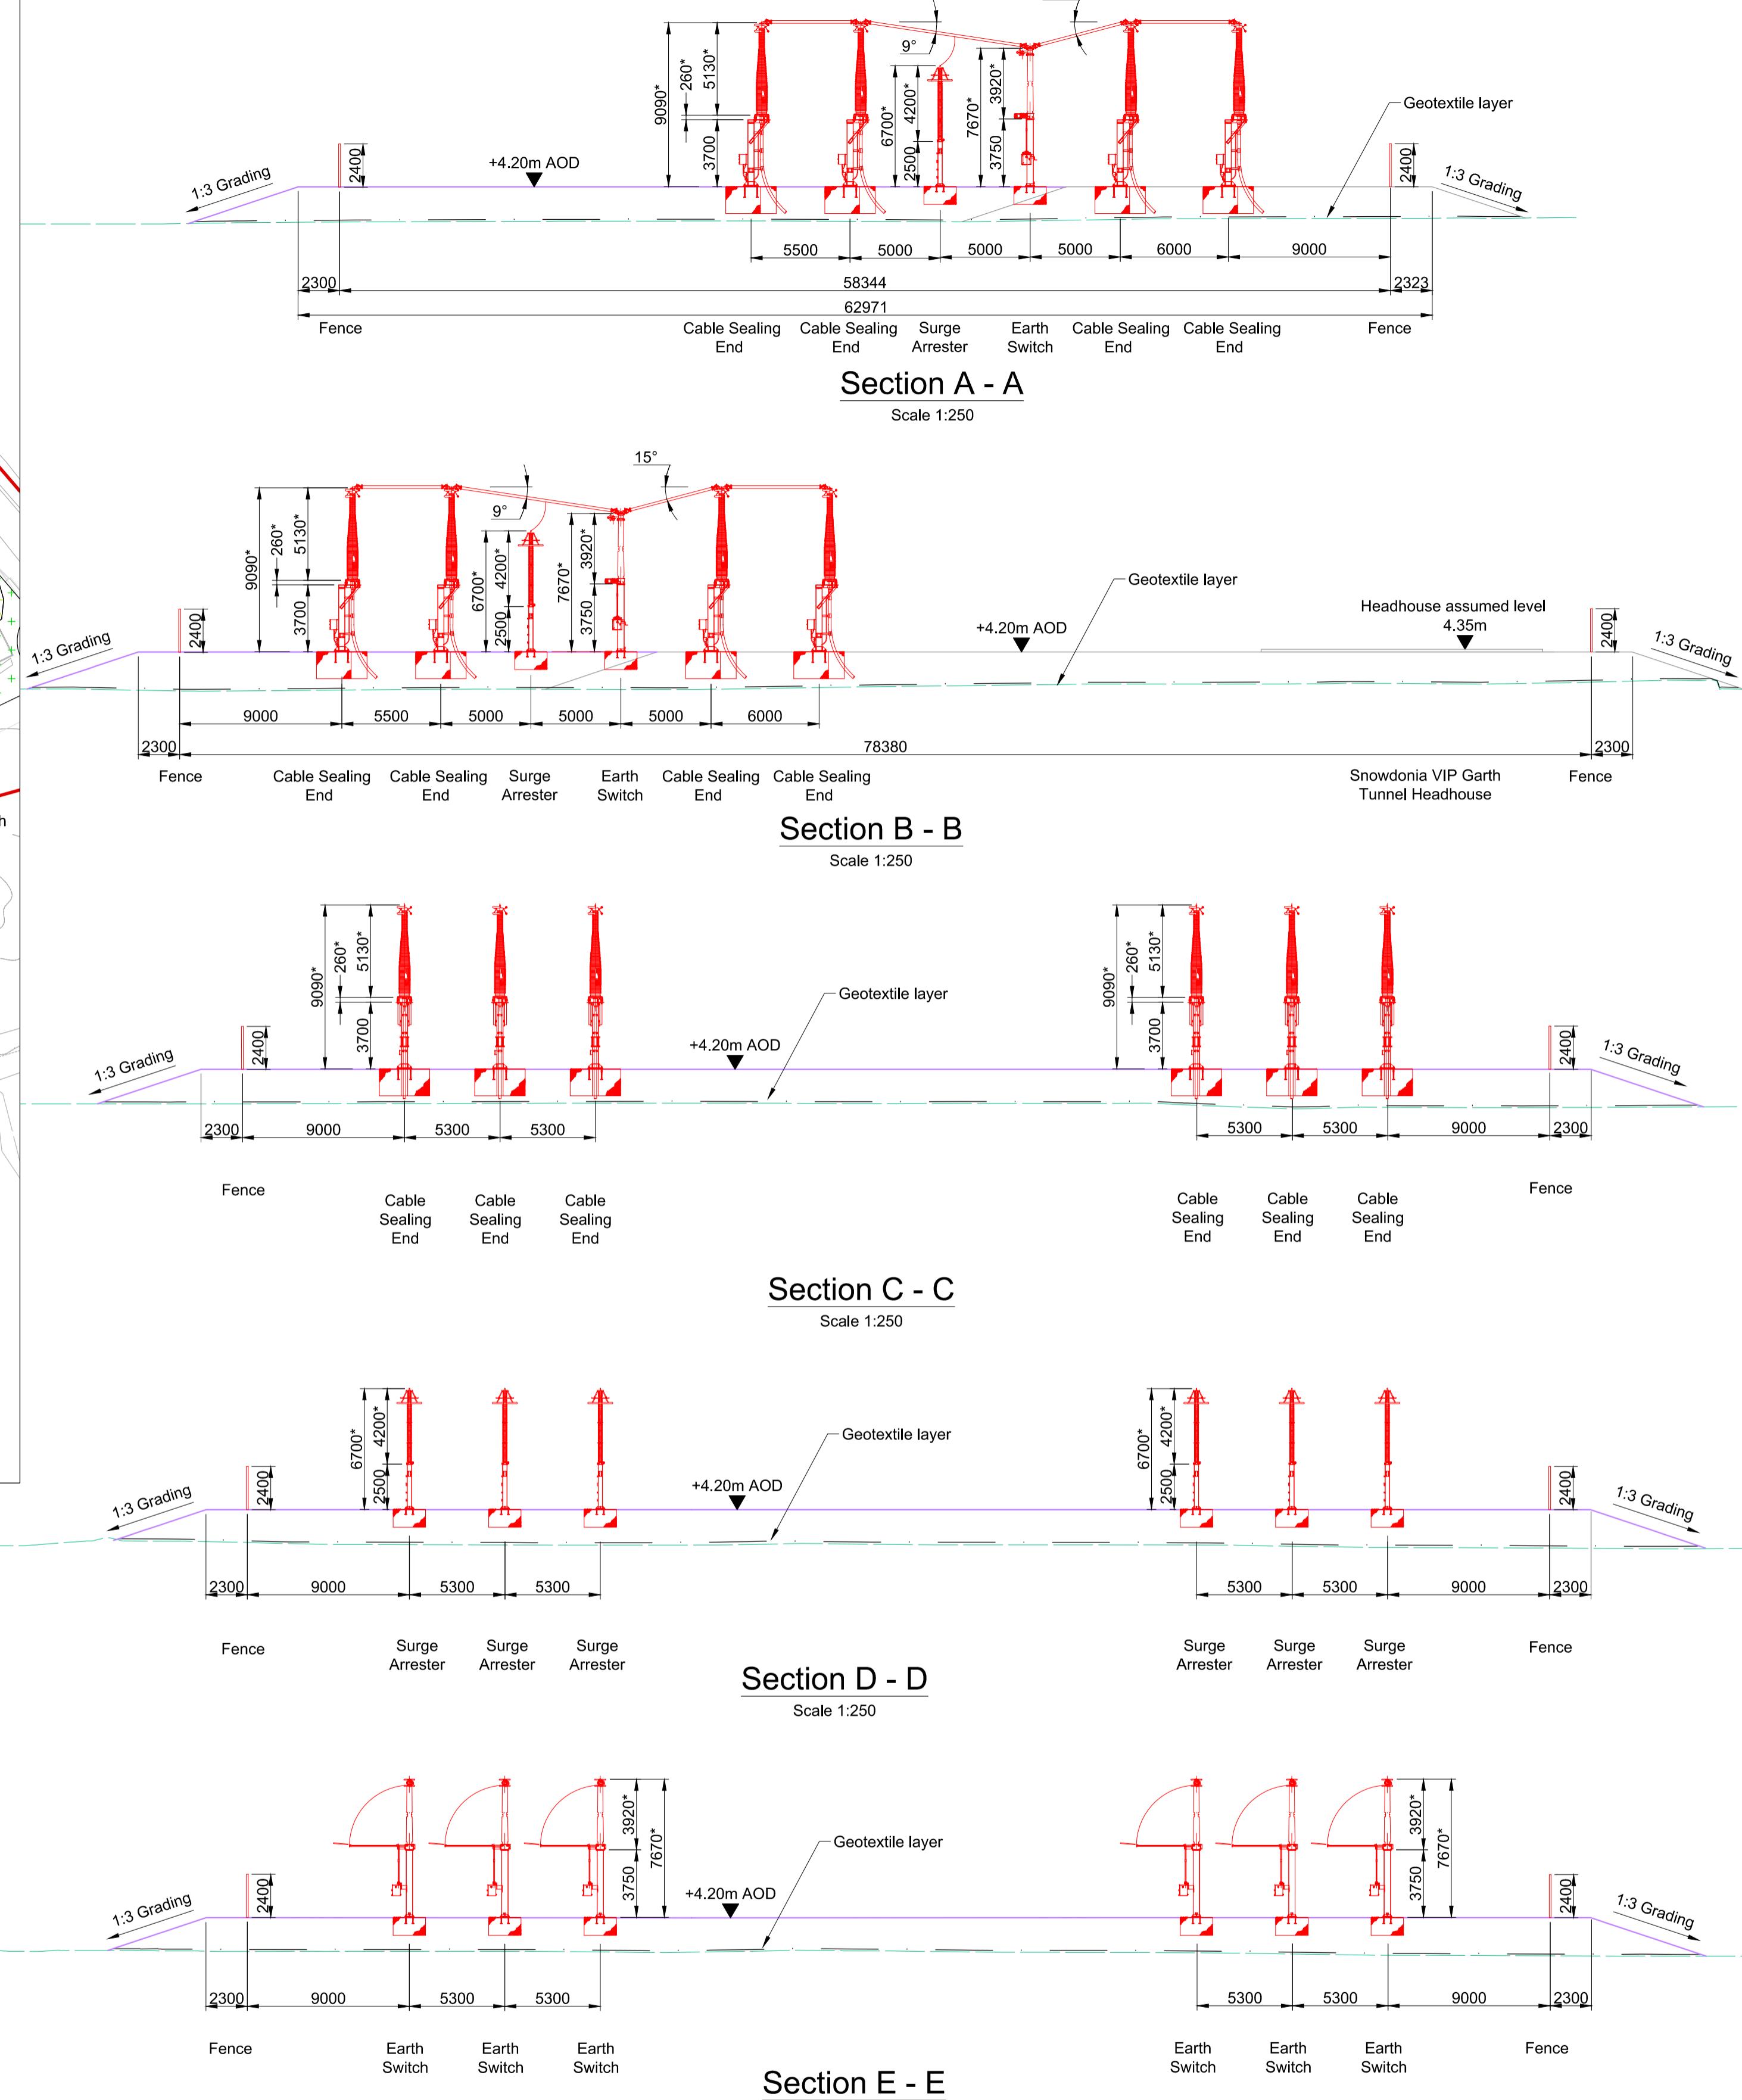

Notes

- Do not scale from this drawing.
- Drawing to be printed in colour.
- All dimensions in millimetres unless otherwise stated.
- CSE Compound main earthing (MES) and fence earthing will maintain a 2m separation distance in line with NGS 3.01.02 Section 1.11.3.
- For detailed landscaping refer to AECOM Landscaping Plan.
- All palisade fencing shall be in accordance with BS 1722-12:2016, type reference GP24. The overall height of the fence shall be 2.4m above base level (Category 2 fencing system in accordance with NG TS2.10.02).
- An electric pulse fence is to be installed to the back of the Category 2 palisade fence and gates as part of the standard fence construction. The electric fence shall extend from ground level to 1.0m above the top of the fence pales.

Cable Sealing End Compound Equipment Key

- Work site boundary
- New Equipment to be added


Legend

- Existing Ground Profile
- Proposed Ground Profile
- Geotextile Layer
- Marshy Grassland
- Scrub Planting
- Neutral Grassland
- Woodland Edge
- Ditch Grassland Fieldlayer
- Planted Tree
- Access Road
- Minffordd CSE Compound (crushed rock surfacing)
- Pond
- EVIP Headhouse Garth Compound (reinforced grass surfacing)
- Proposed Low Voltage Pit
- Proposed Comms Pit
- Proposed CSEC Perimeter Fence
- Proposed Post & Rail Fencing
- Proposed Pond Perimeter Gate
- Proposed Ø450mm inspection chamber
- Proposed Drain Headwall Outfall
- Proposed Ø1200mm Manhole
- Proposed Ø1350mm Flow Control Manhole

Dwg Title: Planning Drawings Minffordd CSE Compound Sections and Elevations		
Site: Glaslyn Cable Uprating	A1 100%	CAD
Originator Dwg No: GLAS-ARUP-71-XX-DR-X-9241	Originators Proj Ref:	295280-00
NG Investment No:		
NG Dwg No:	Sheet No:	Total No. of Sheets
Scale: As shown	2	2



Draft WIP

A B C D E F G H I J K L

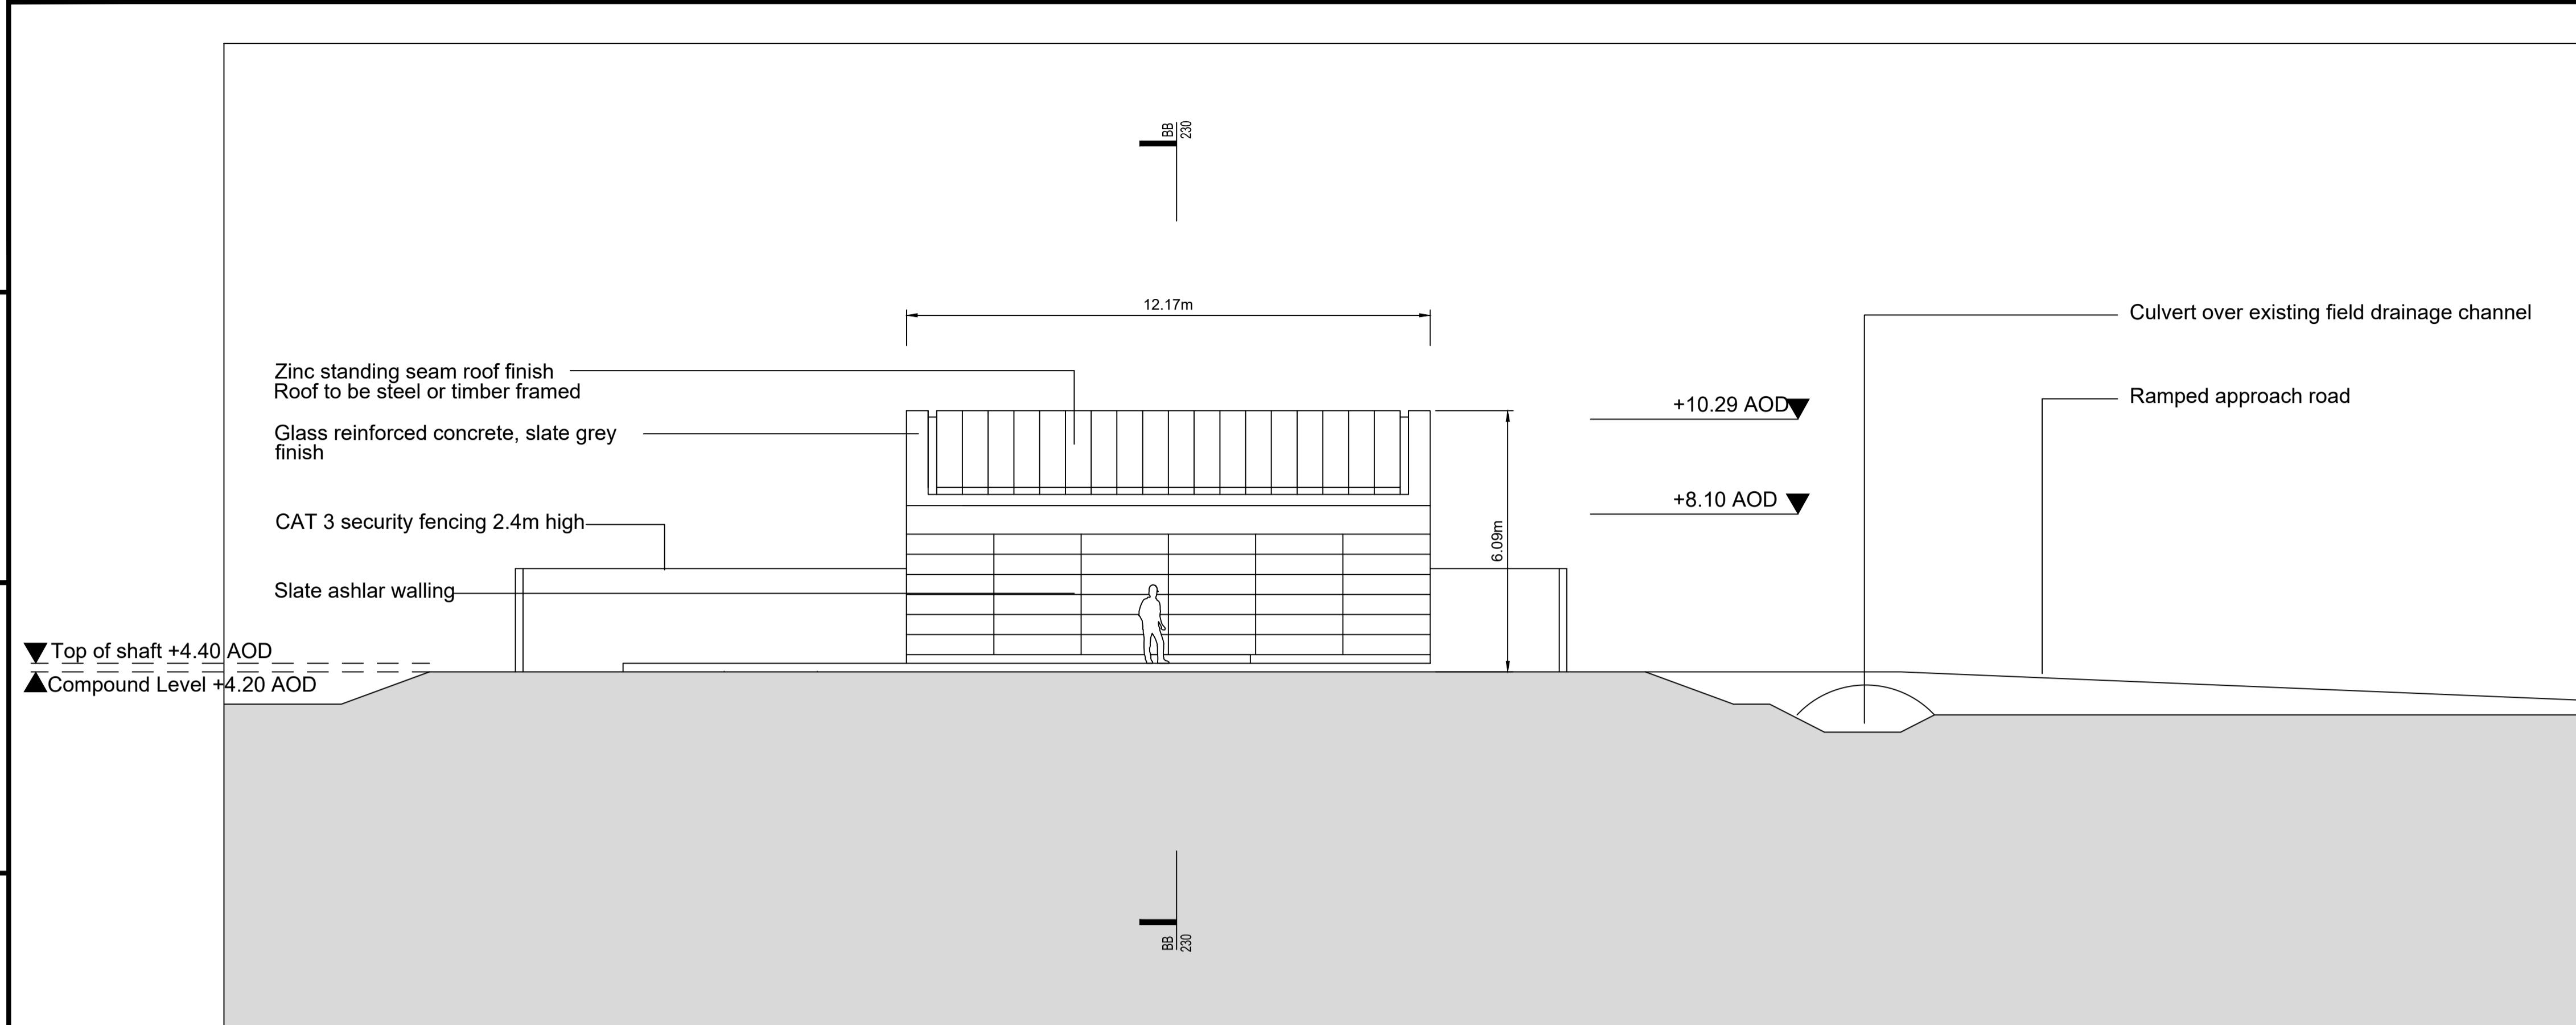

©CROWN COPYRIGHT. UNAUTHORISED REPRODUCTION INFRINGES CROWN COPYRIGHT AND MAY LEAD TO PROSECUTION OR CIVIL PROCEEDINGS
LICENCE NUMBER: 100024241

NOTE:
1. THIS DRAWING IS TO BE READ IN CONJUNCTION WITH ALL OTHER RELEVANT DRAWINGS, DOCUMENTS AND SPECIFICATIONS.
2. DO NOT SCALE FROM THIS DRAWING. USE ONLY DIMENSIONS PROVIDED.
3. ALL DIMENSIONS ARE IN MILLIMETRES UNLESS OTHERWISE STATED.
4. EXTERNAL RWP'S TO BE INSTALLED (DETAILED TO BE VISUALLY UNINTRUSIVE AND NOT EASILY CLIMBED)

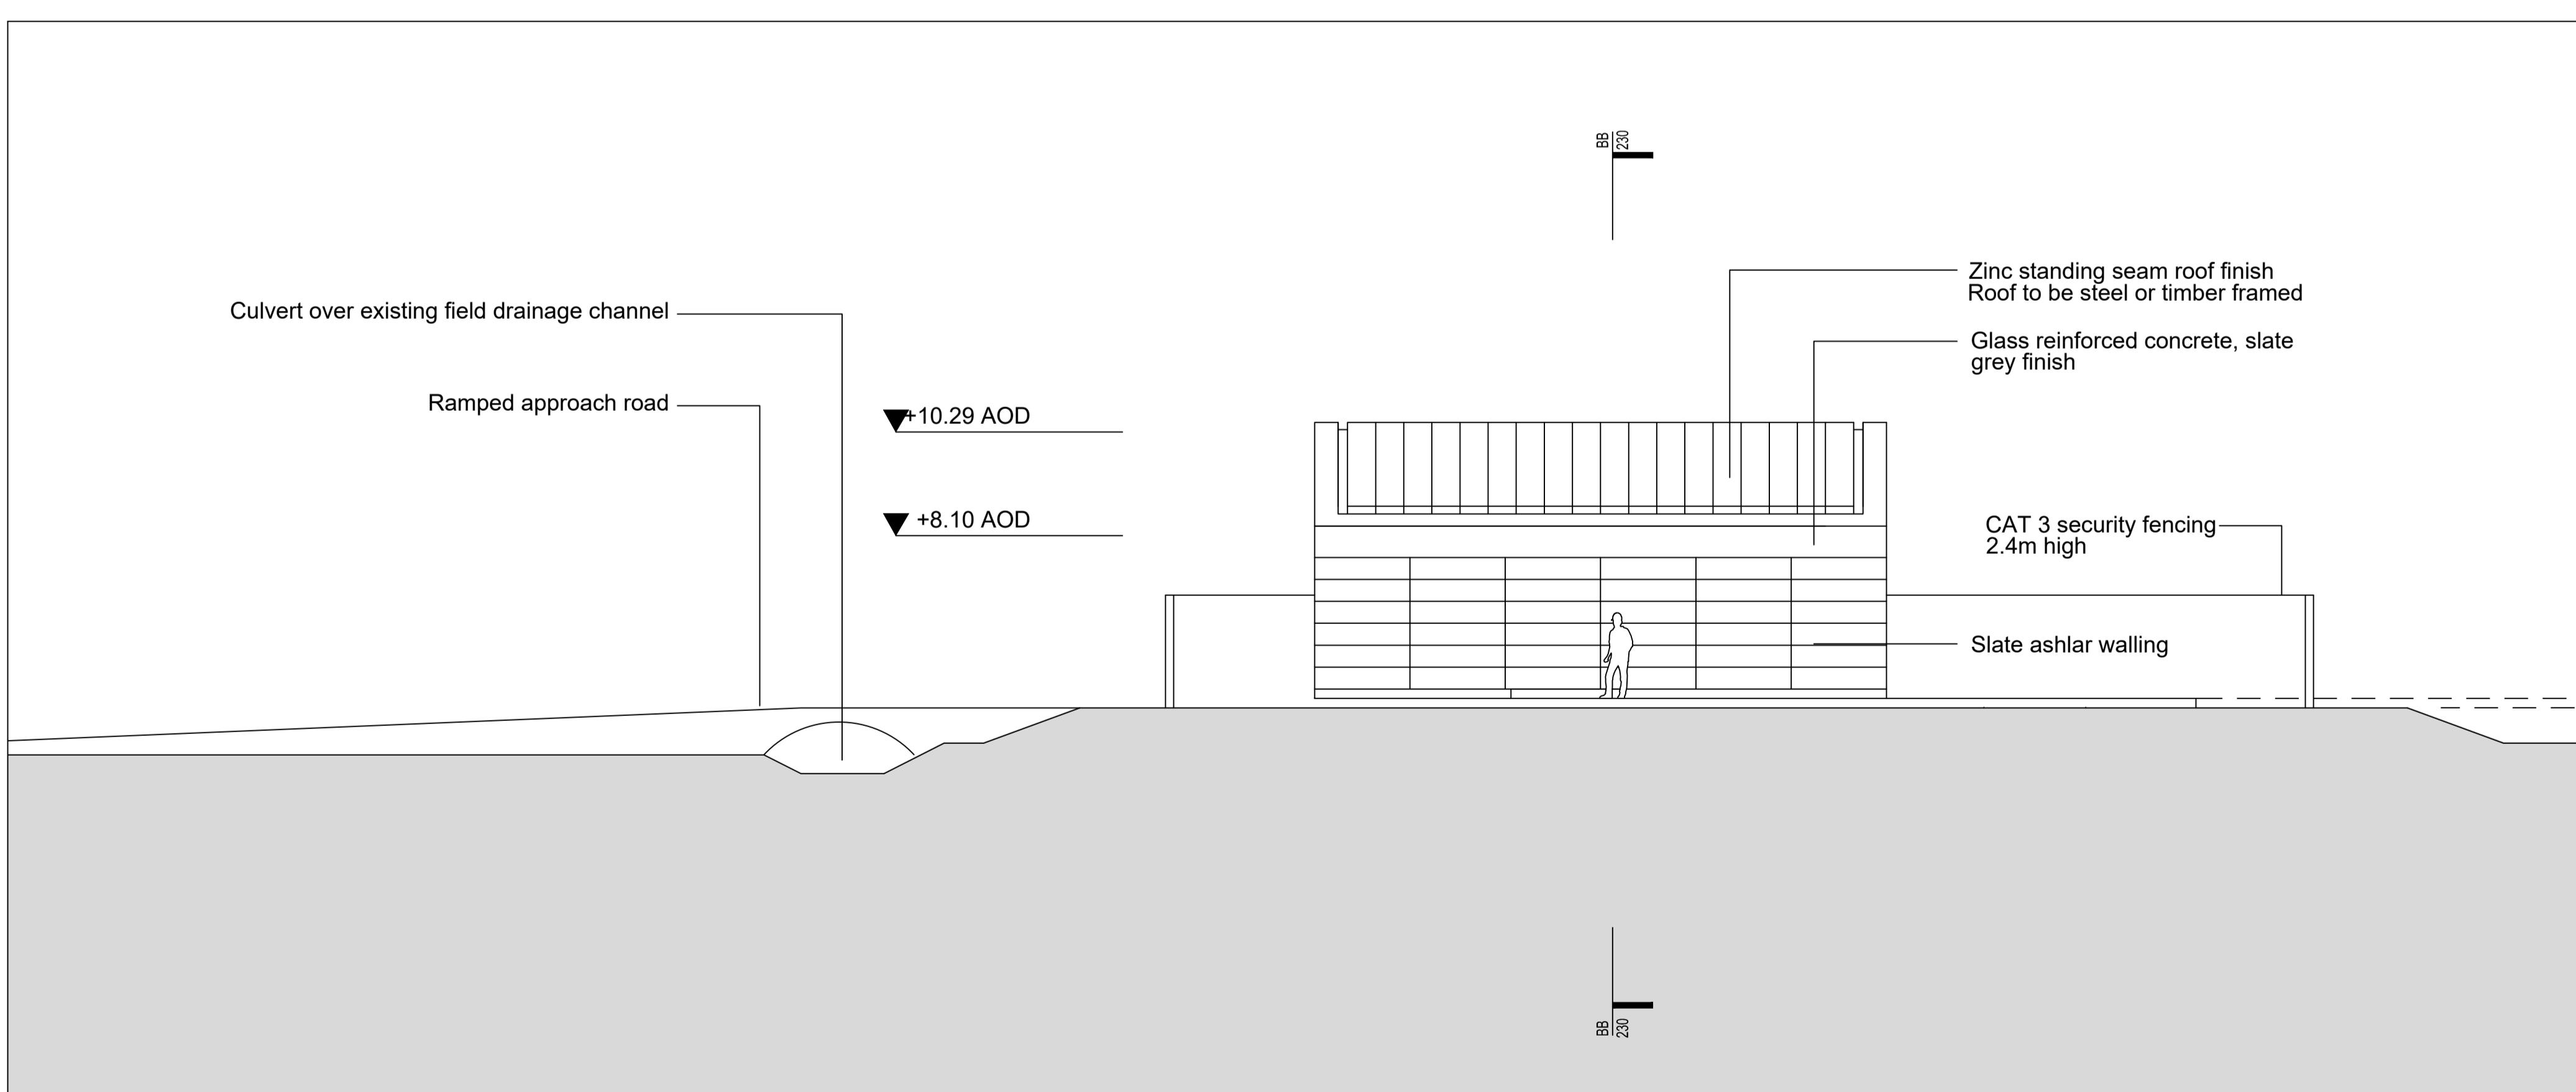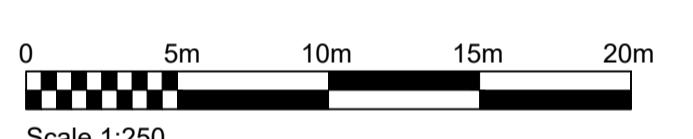


P03	AMENDED FOR CHANGES	XX	XX	XX	08.09.25
P02	ISSUED FOR PLANNING	MAC	CN	CN	31.10.19
P01	ISSUED FOR TENDER	JR	GG	CM	12.07.19
Rev Description	Cre'd	Chk'd	App'd	Date	

nationalgrid

Master Scheme No:	Sub-Scheme No:	Site:			
33494	VIP	SNOWDONIA WEST SITE			
Scheme Name:					
WEST HEAD HOUSE					
Document Title:					
EAST AND WEST ELEVATIONS GARTH					
Created by:	Date:	Checked by:	Date:	Approved by:	Date:
JR	07.06.19	GG	07.06.19	CM	07.06.19
Development Eng:	Document Type:	Scale:	Format:	Sheet(s):	Rev:
	ARC	1:100	A1	1 OF 1	P03
National Grid Document Number:					
PDD-33494-ARC-220					
FEED Document Number:					


A B C D E F G H I J K L

A B C D E F G H I J K L

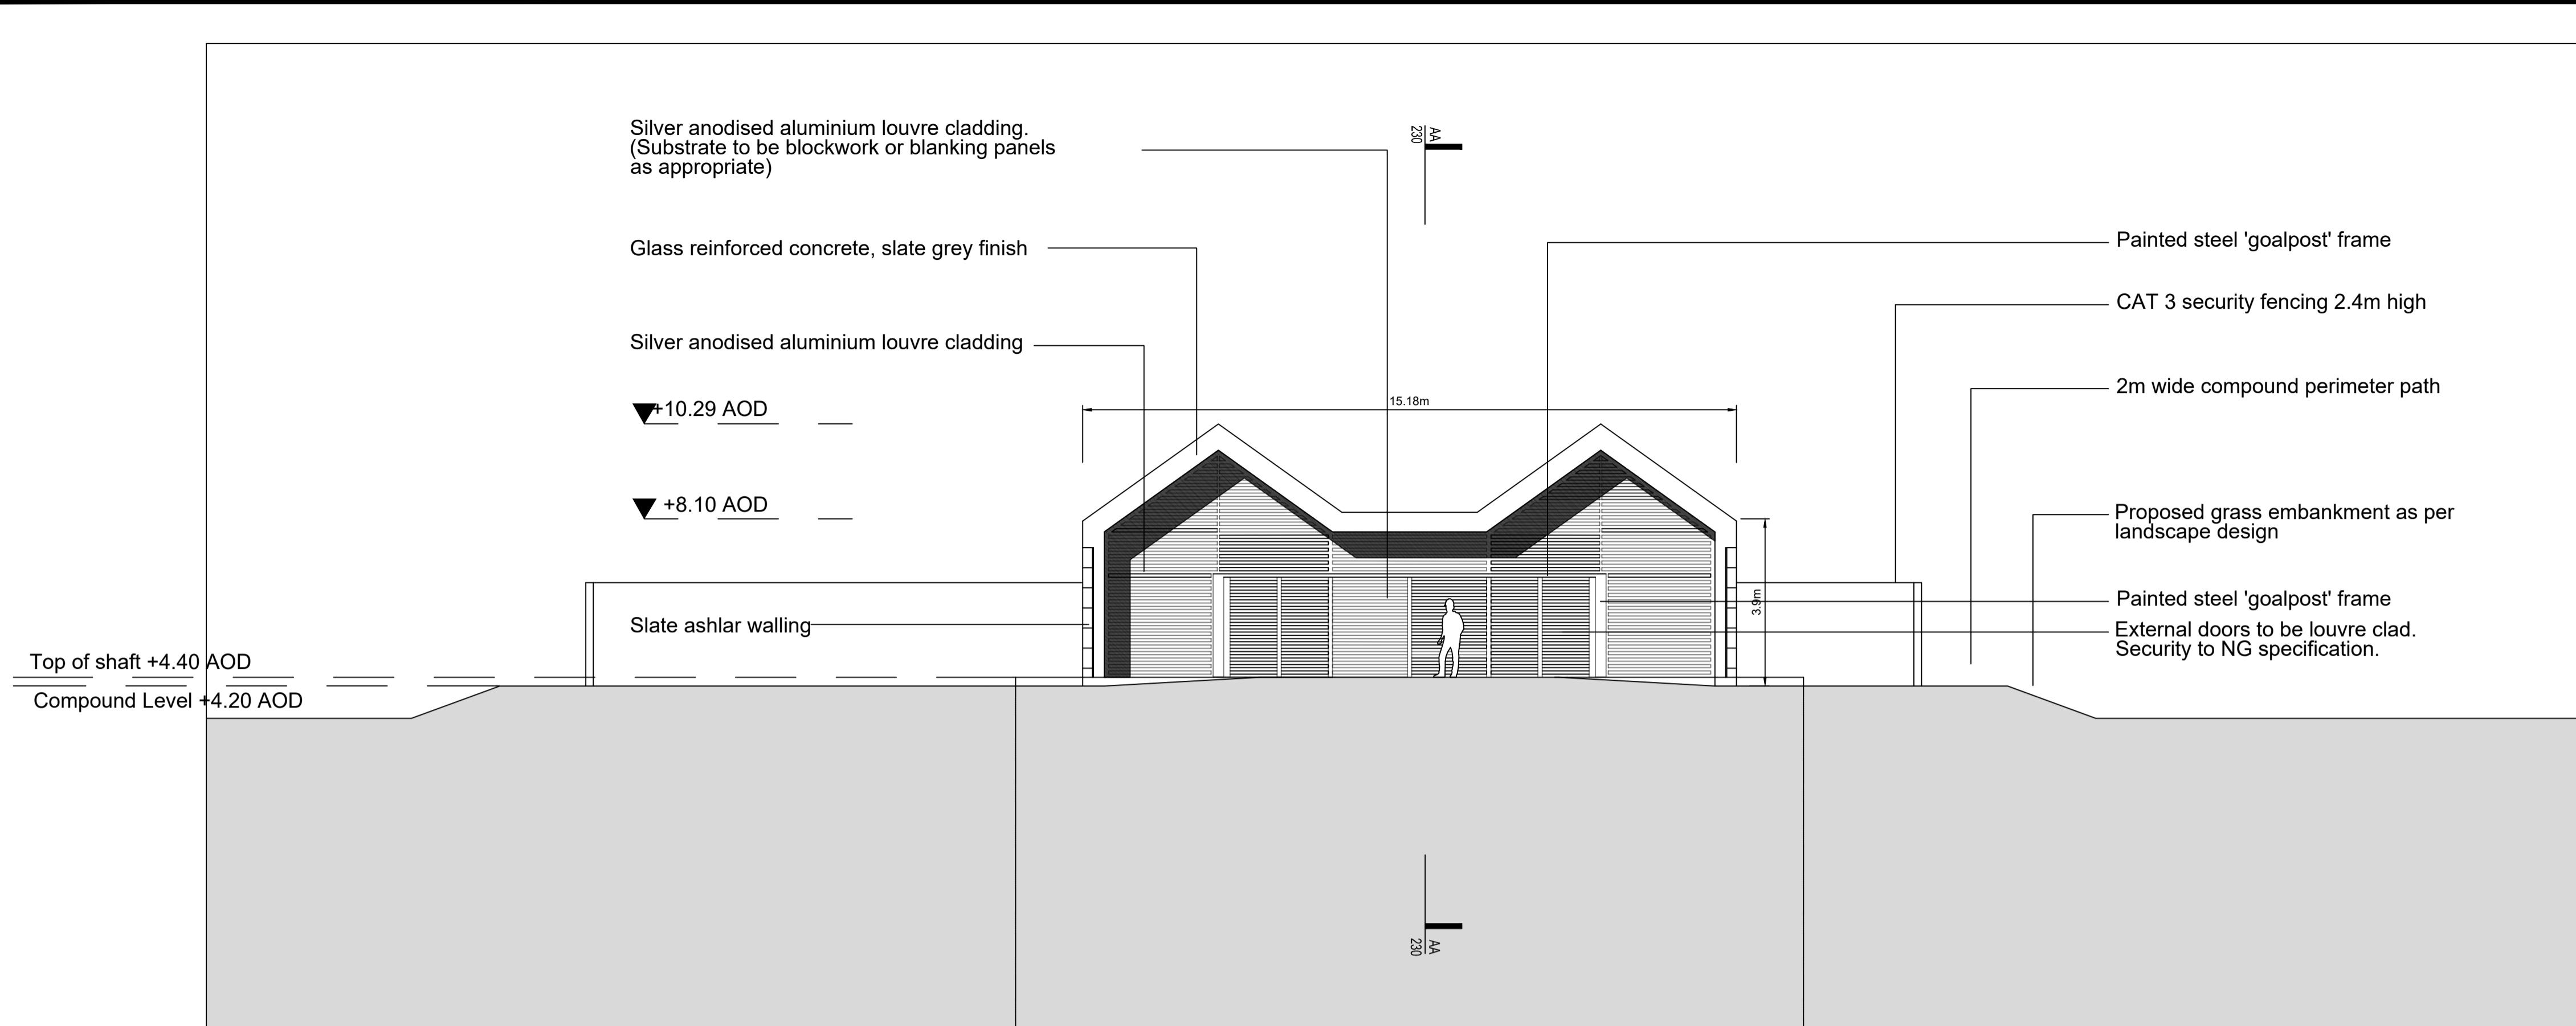

©CROWN COPYRIGHT. UNAUTHORISED REPRODUCTION INFRINGES CROWN COPYRIGHT AND MAY LEAD TO PROSECUTION OR CIVIL PROCEEDINGS
LICENCE NUMBER: 100024241

NOTE:
1. THIS DRAWING IS TO BE READ IN CONJUNCTION WITH ALL OTHER RELEVANT DRAWINGS, DOCUMENTS AND SPECIFICATIONS.
2. DO NOT SCALE FROM THIS DRAWING. USE ONLY DIMENSIONS PROVIDED.
3. ALL DIMENSIONS ARE IN MILLIMETRES UNLESS OTHERWISE STATED.
4. EXTERNAL RWP'S TO BE INSTALLED (DETAILED TO BE VISUALLY UNINTRUSIVE AND NOT EASILY CLIMBED)

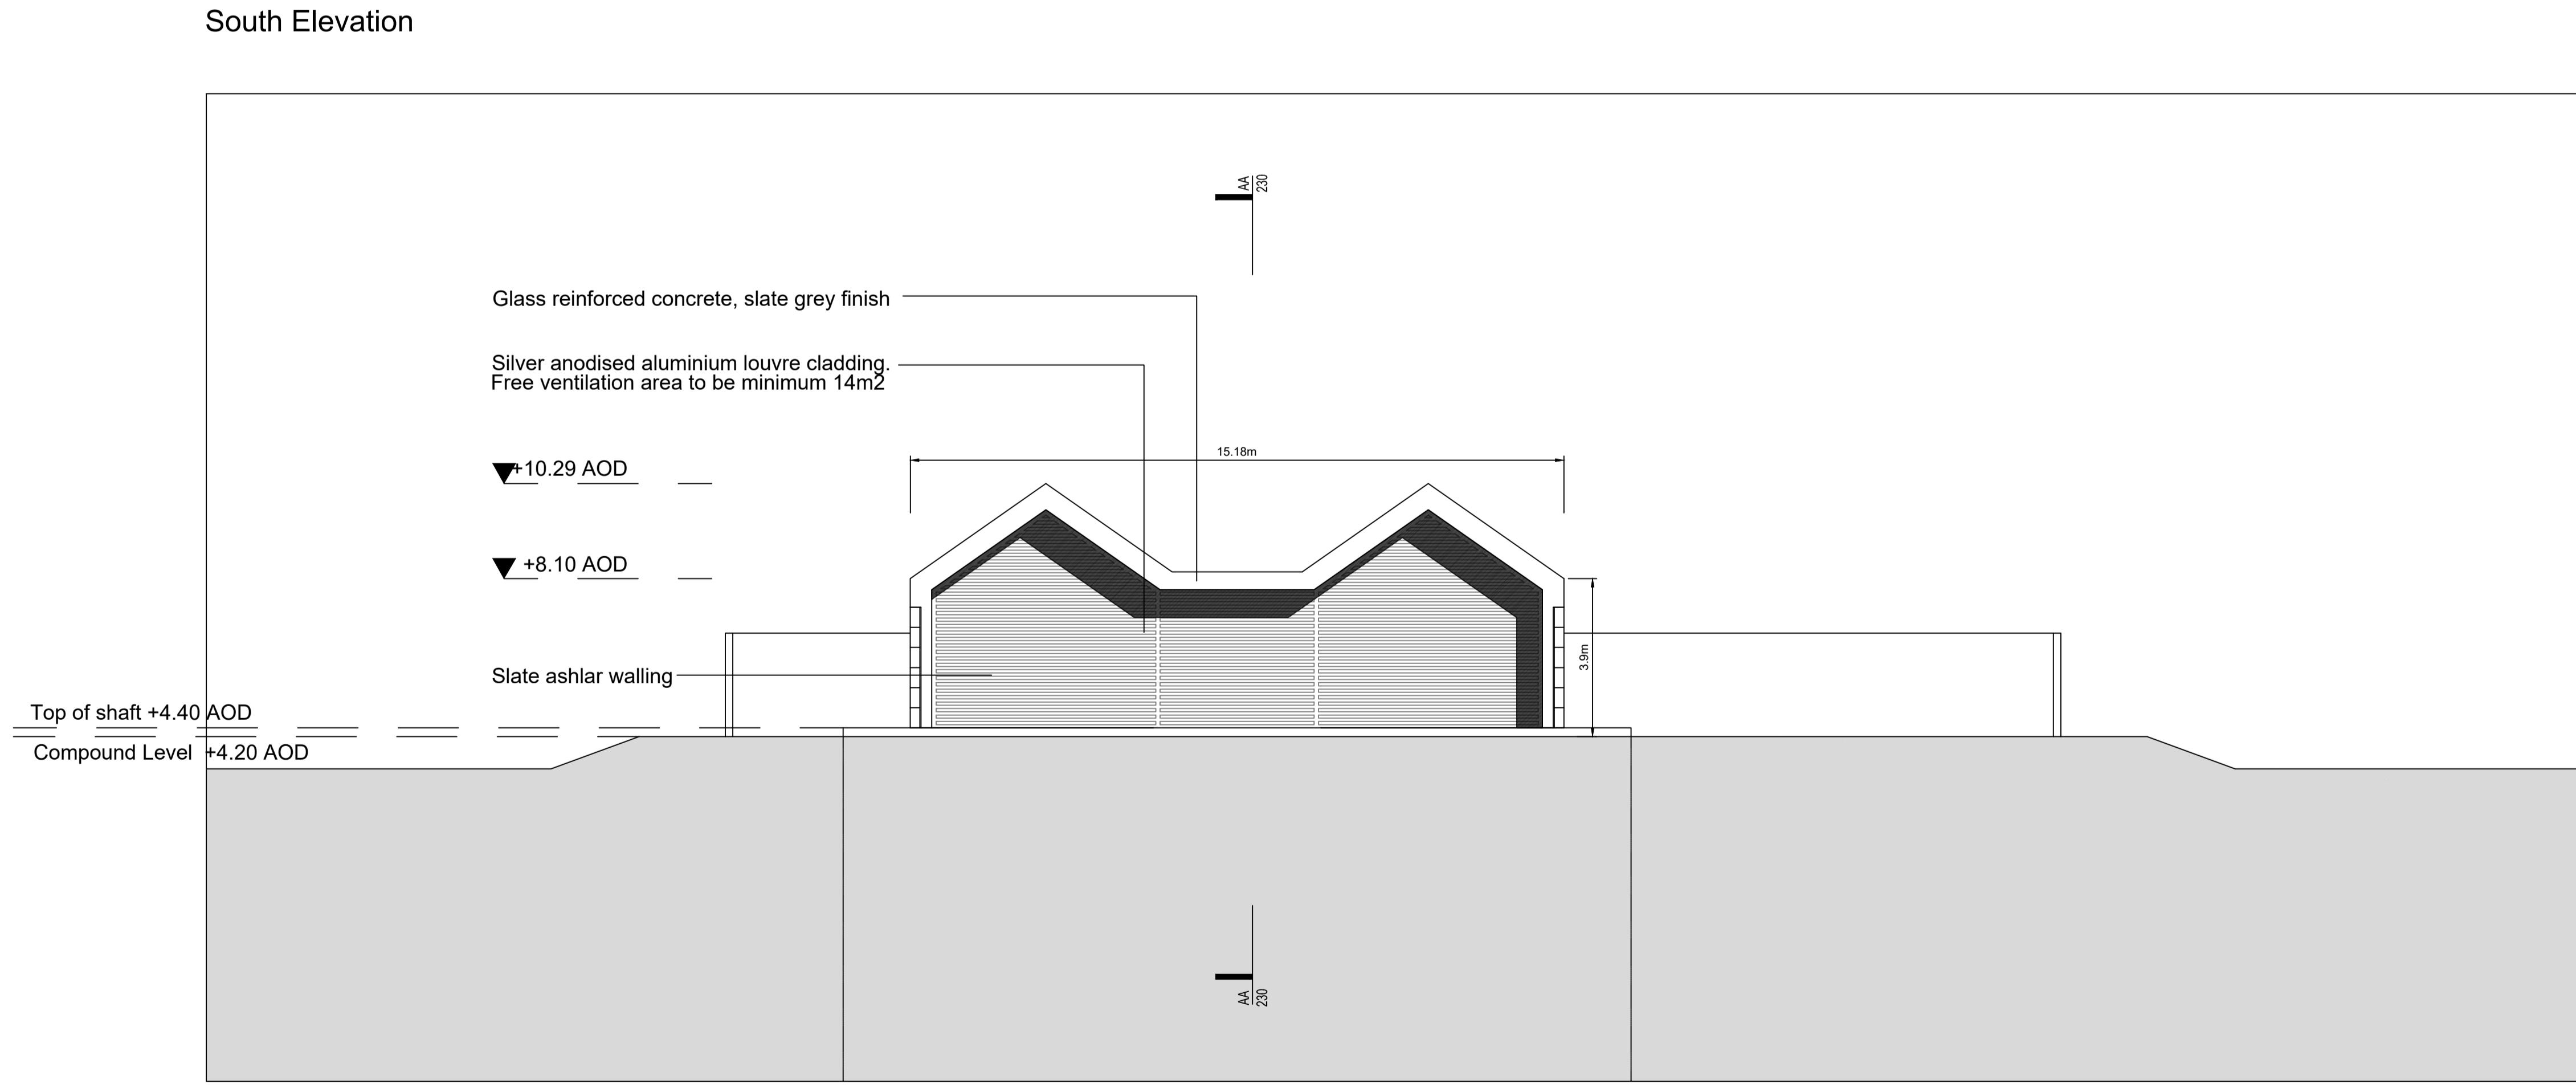

P03	AMENDED FOR CHANGES	XX	XX	XX	08.09.25
P02	ISSUED FOR PLANNING	MAC	CN	CN	31.10.19
P01	ISSUED FOR TENDER				12.07.19
Rev Description		Cre'd	Chk'd	App'd	Date

nationalgrid

Master Scheme No:	Sub-Scheme No:	Site:
33494	VIP	SNOWDONIA WEST SITE

Scheme Name: WEST HEAD HOUSE

Document Title:

NORTH AND SOUTH ELEVATIONS
GARTH

Created by:	Date:	Checked by:	Date:	Approved by:	Date:
-------------	-------	-------------	-------	--------------	-------

Development Eng:	Document Type:	Scale:	Format:	Sheet(s):	Rev:
	ARC	1:100	A1	1 OF 1	P03

National Grid Document Number:

PDD-33494-ARC-221

FEED Document Number:

A B C D E F G H I J K L