


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 4. All levels are in metres Above Ordnance Datum (mAOD)
 5. Existing ground model and utilities information based on survey MGS54157 dated 08/09/23 and undertaken by Murphy Geospatial, with additional data from subsequent GPR.

Legend:

Drawing Sheet Number 01

Work site boundary

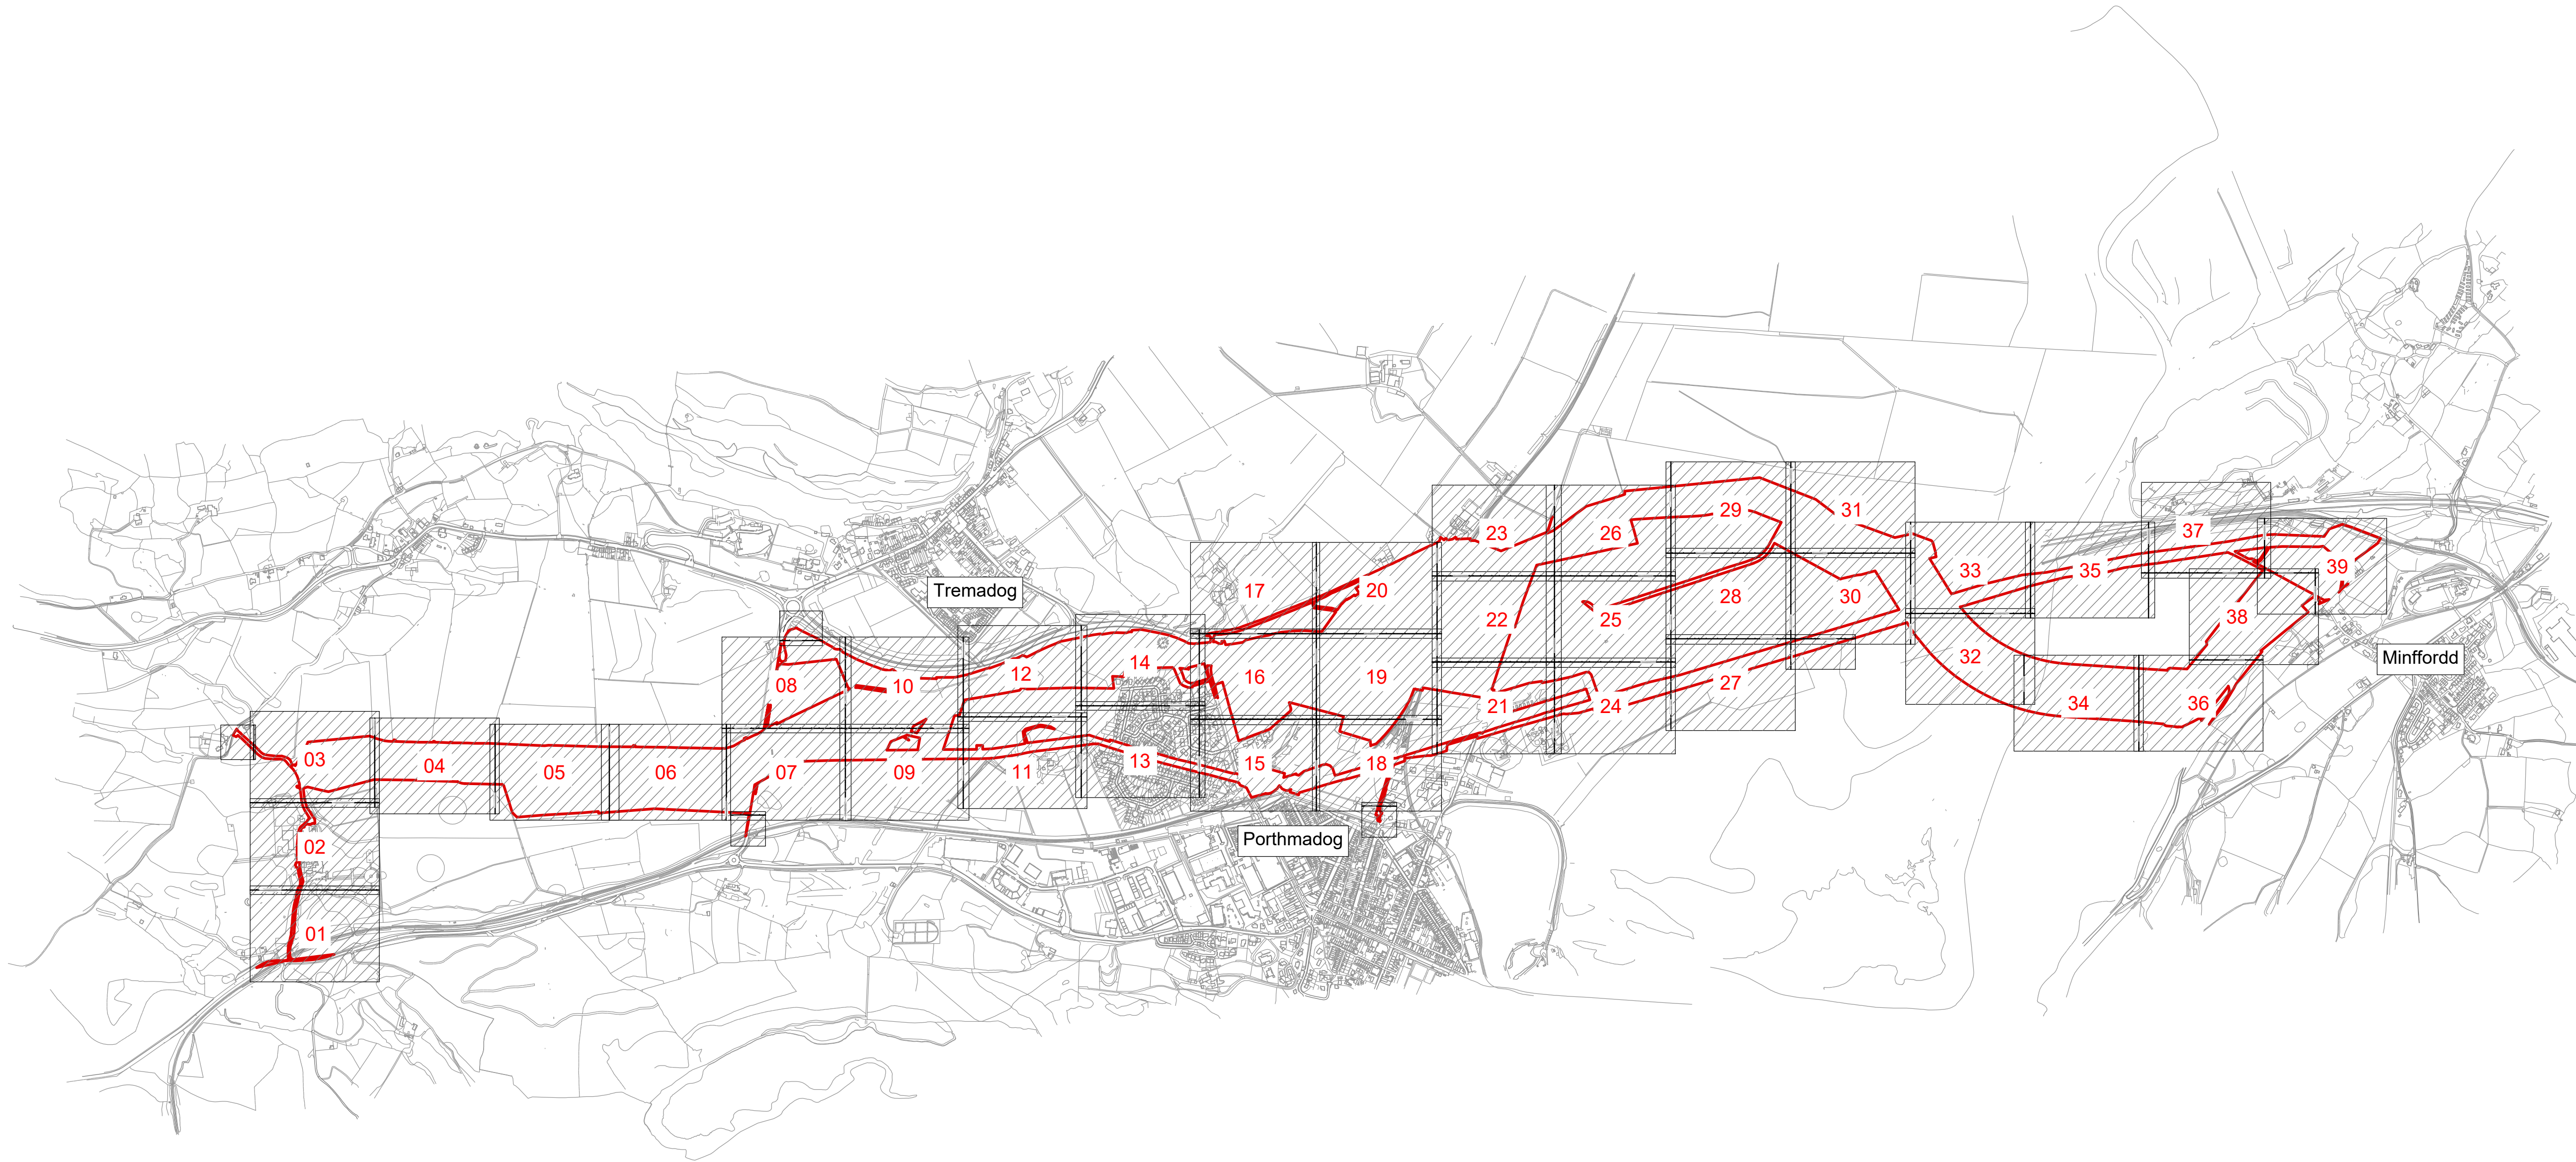

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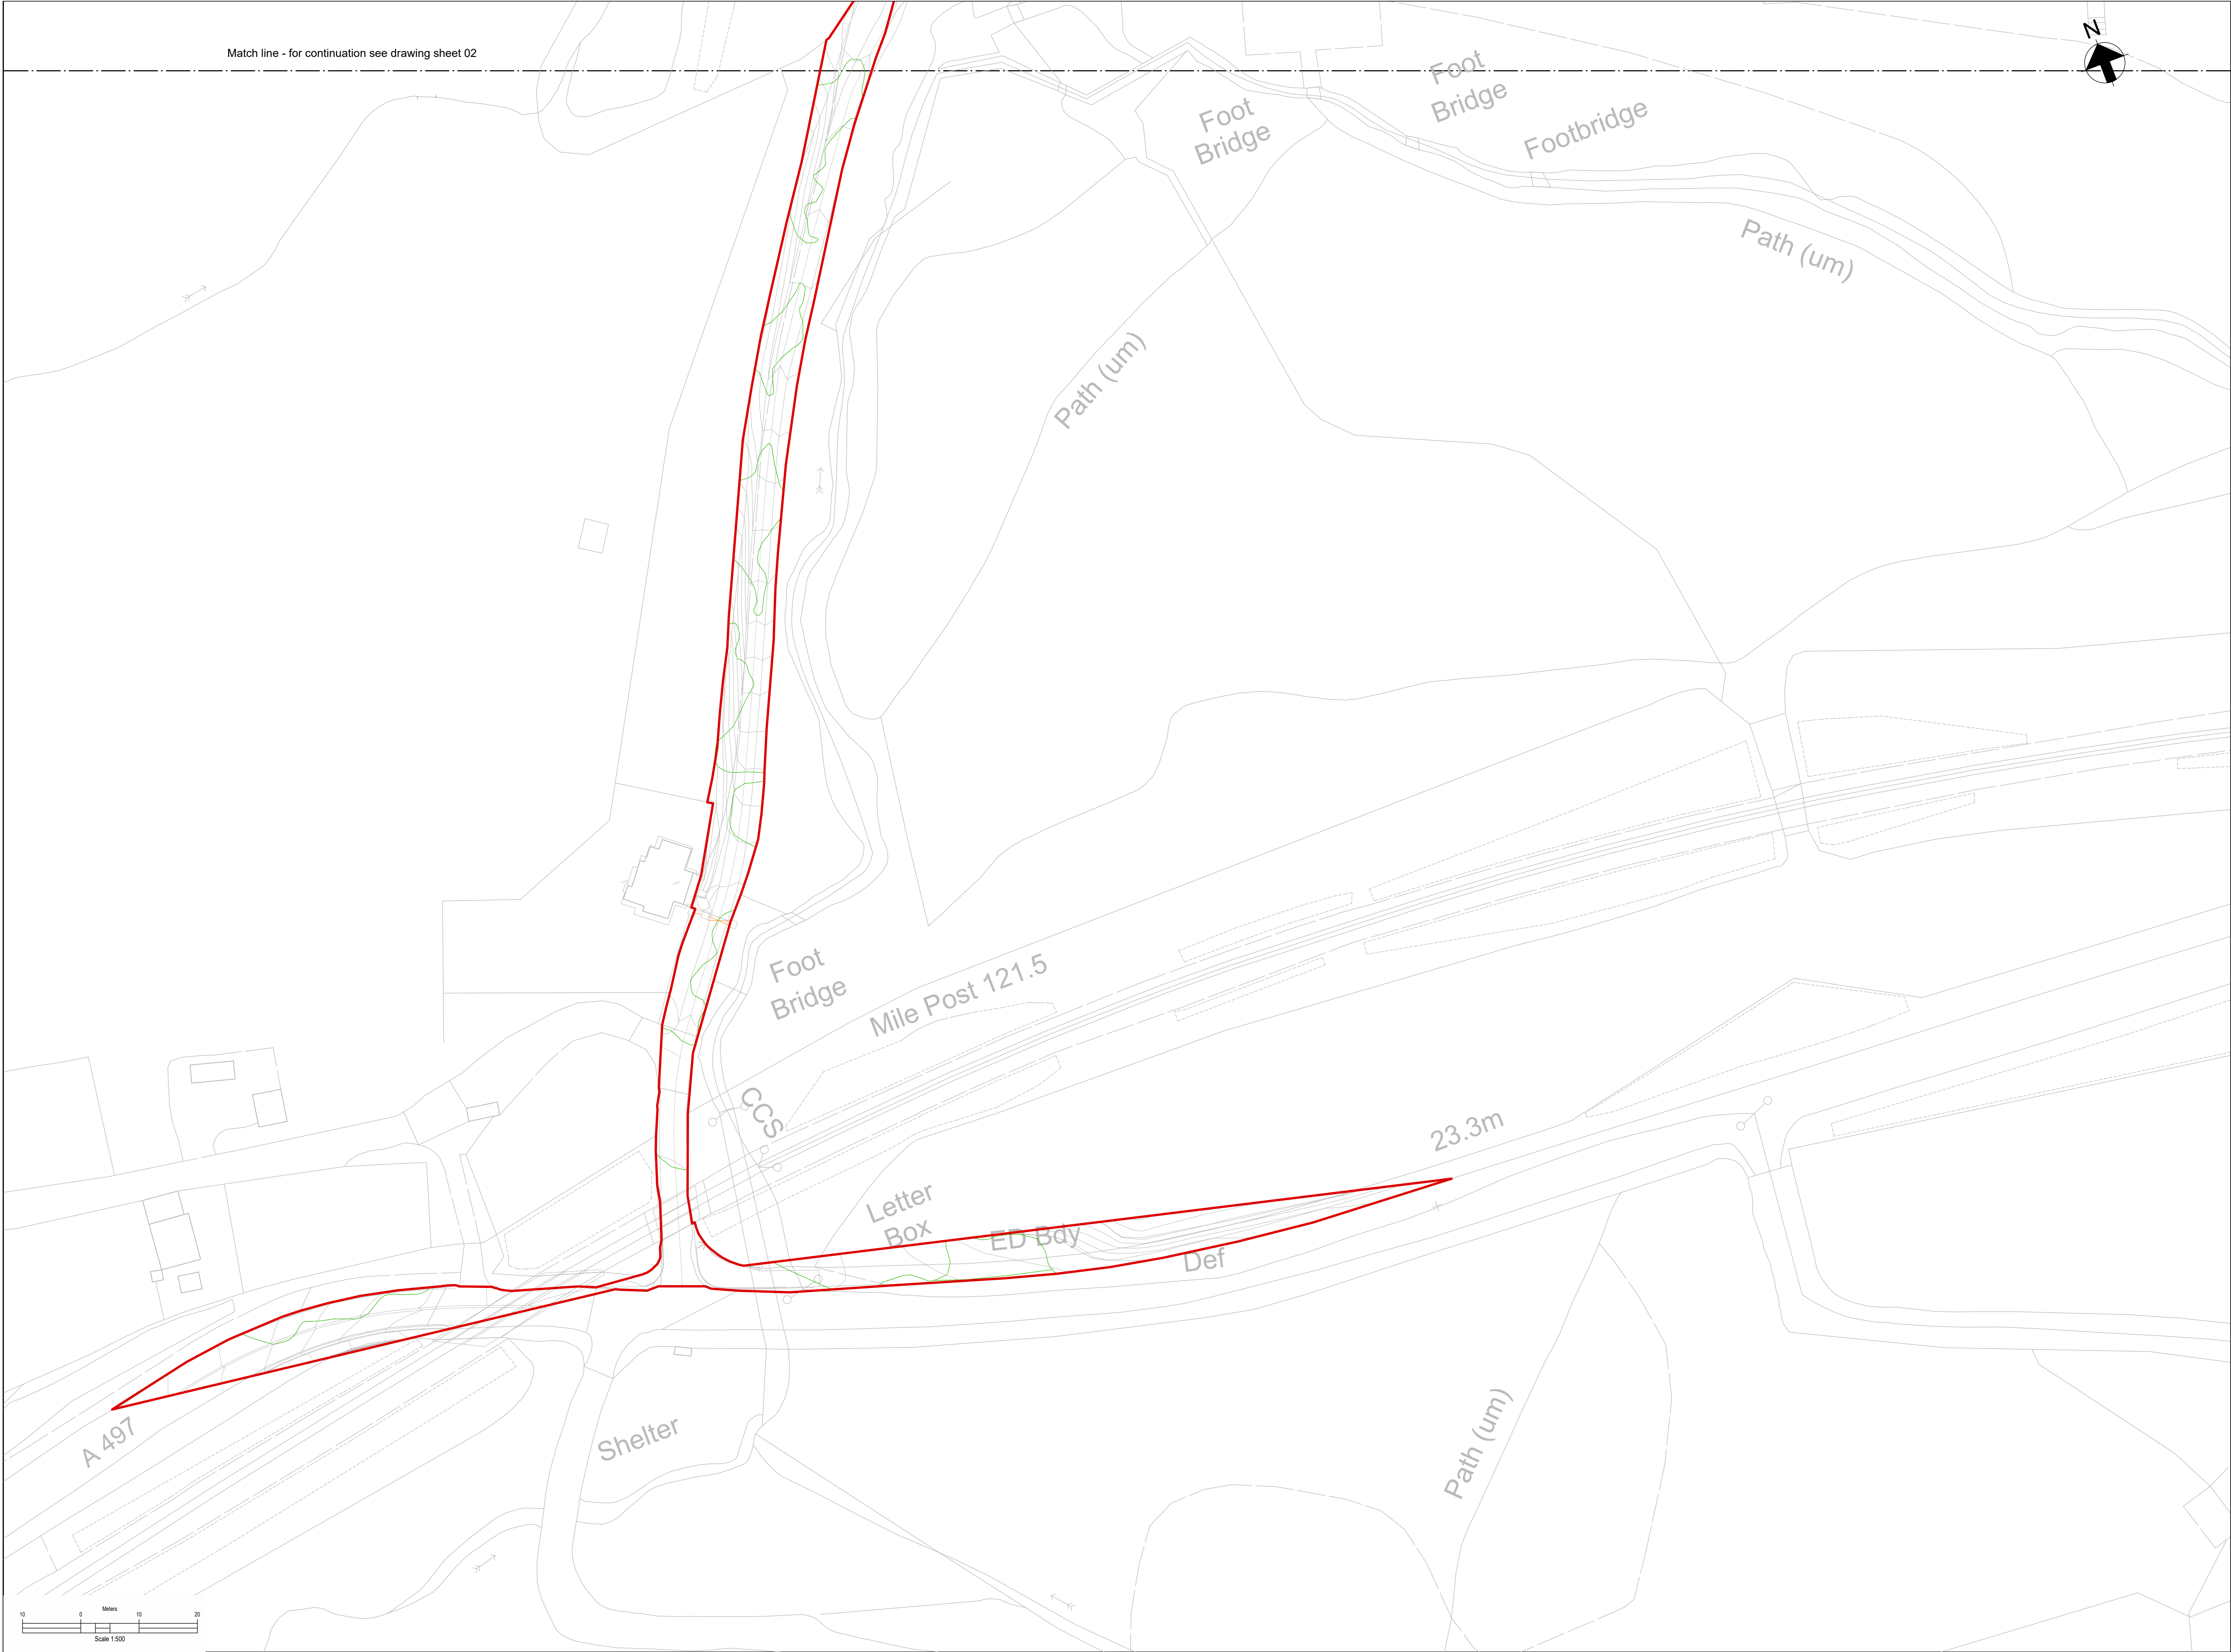
Dwg Title:
Planning Drawings
Existing Site Plan Location and Key Plan



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Site: Glaslyn Cable Uprating		A1 100%	CAD	
Originator Dwg No: GLAS-ARUP-70-XX-DR-X-9000		Originators Proj. Ref:	295280-00	
NG Investment No:		Sheet No:	Total No. of Sheets	Issue:
NG Dwg No:				
Scale: 1:10000				
		1	1	C



Key Plan

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- Existing ground model and utilities information based on survey MGS54157 dated 08/09/23 and undertaken by Murphy Geospatial, with additional data from subsequent GPR.

Legend:

Work site boundary

Existing Watercourse

Existing Fenceline

Existing Gate

Existing trees and vegetation

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Dwg Title:
Planning Drawings
Existing Site Plans
Sheet 1

Site: Glaslyn Cable Uprating		A1 100%	CAD
Originator: Dwg No: GLAS-ARUP-70-XX-DR-X-9001		Originators Proj.Ref: 295280-00	
NG Investment No:		Sheet No: 1	Total No. of Sheets 39
NG Dwg No:			
Scale: 1:500			




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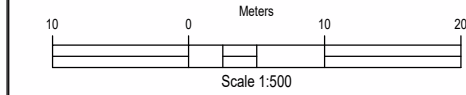
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Legend:

- Work site boundary
- Existing Watercourse
- Existing Fenceline
- Existing Gate
- Existing trees and vegetation



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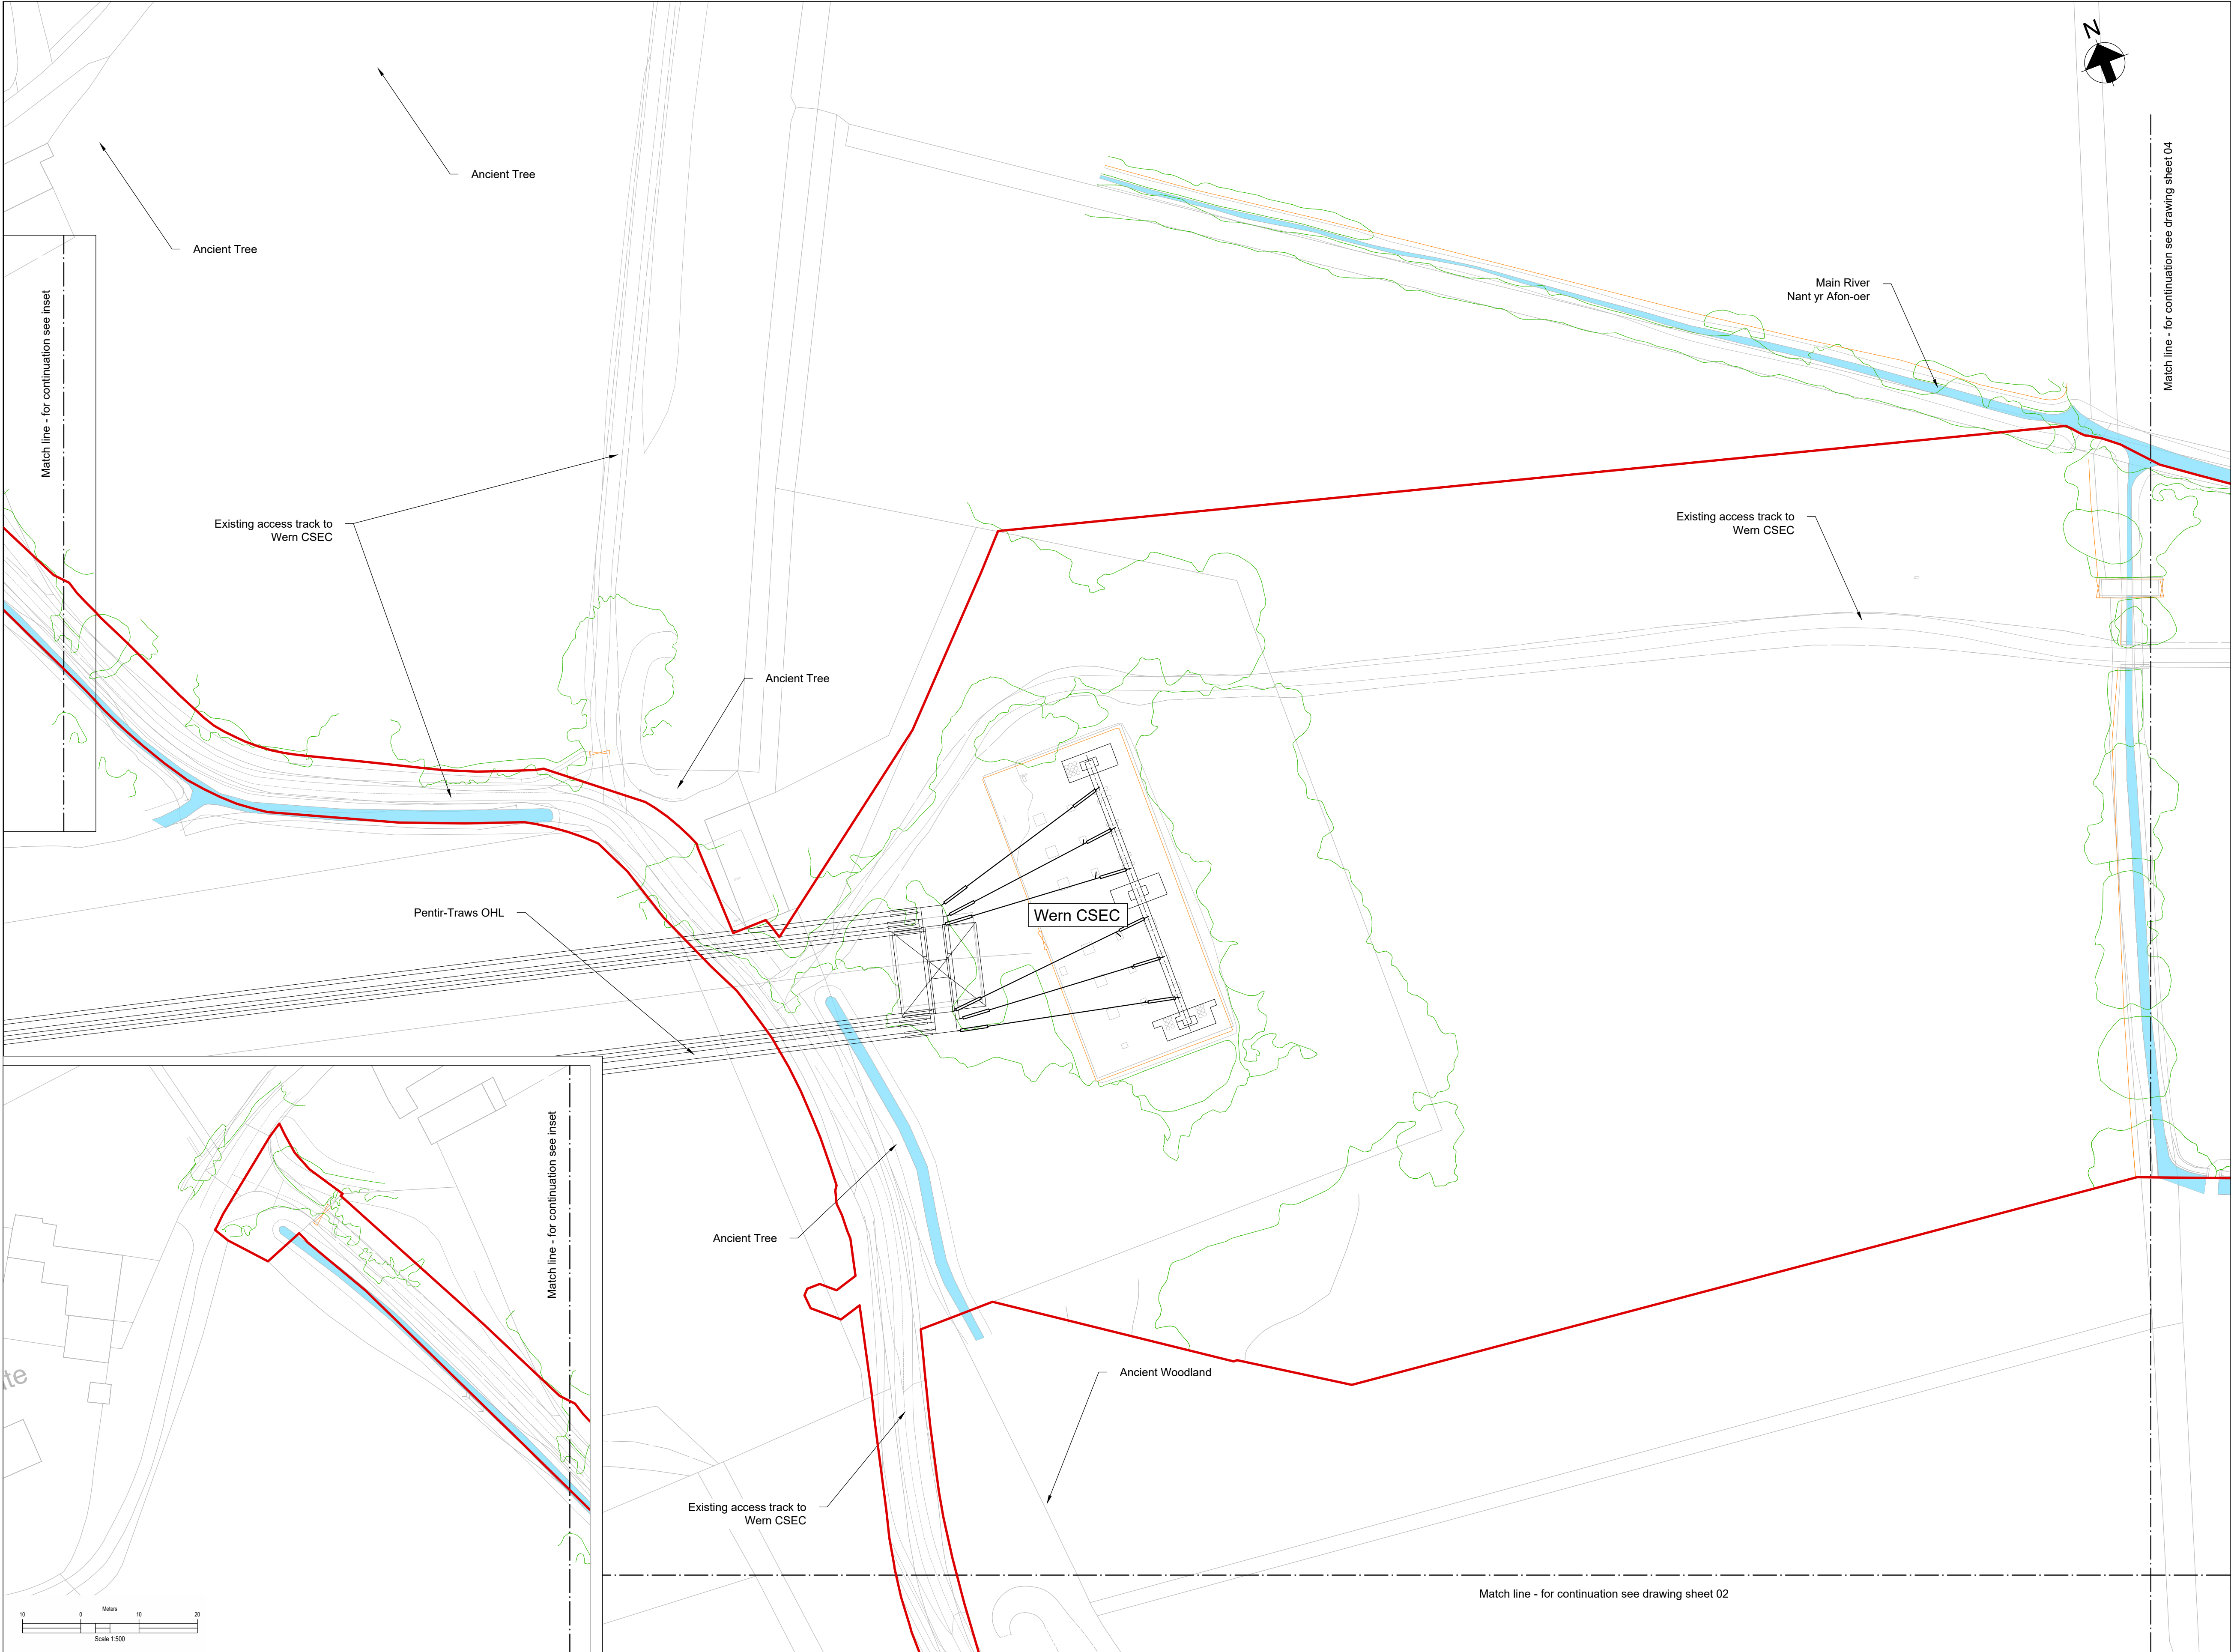
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Dwg Title:
Planning Drawings
Existing Site Plans
Sheet 2

Site: Glaslyn Cable Uprating	A1 100%	CAD
Originator Dwg No: GLAS-ARUP-70-XX-DR-X-9002	Originators Proj.Ref: 295280-00	
NG Investment No:	Sheet No:	Total No. of Sheets
NG Dwg No:	2	39
Scale: 1:500		Issue: C

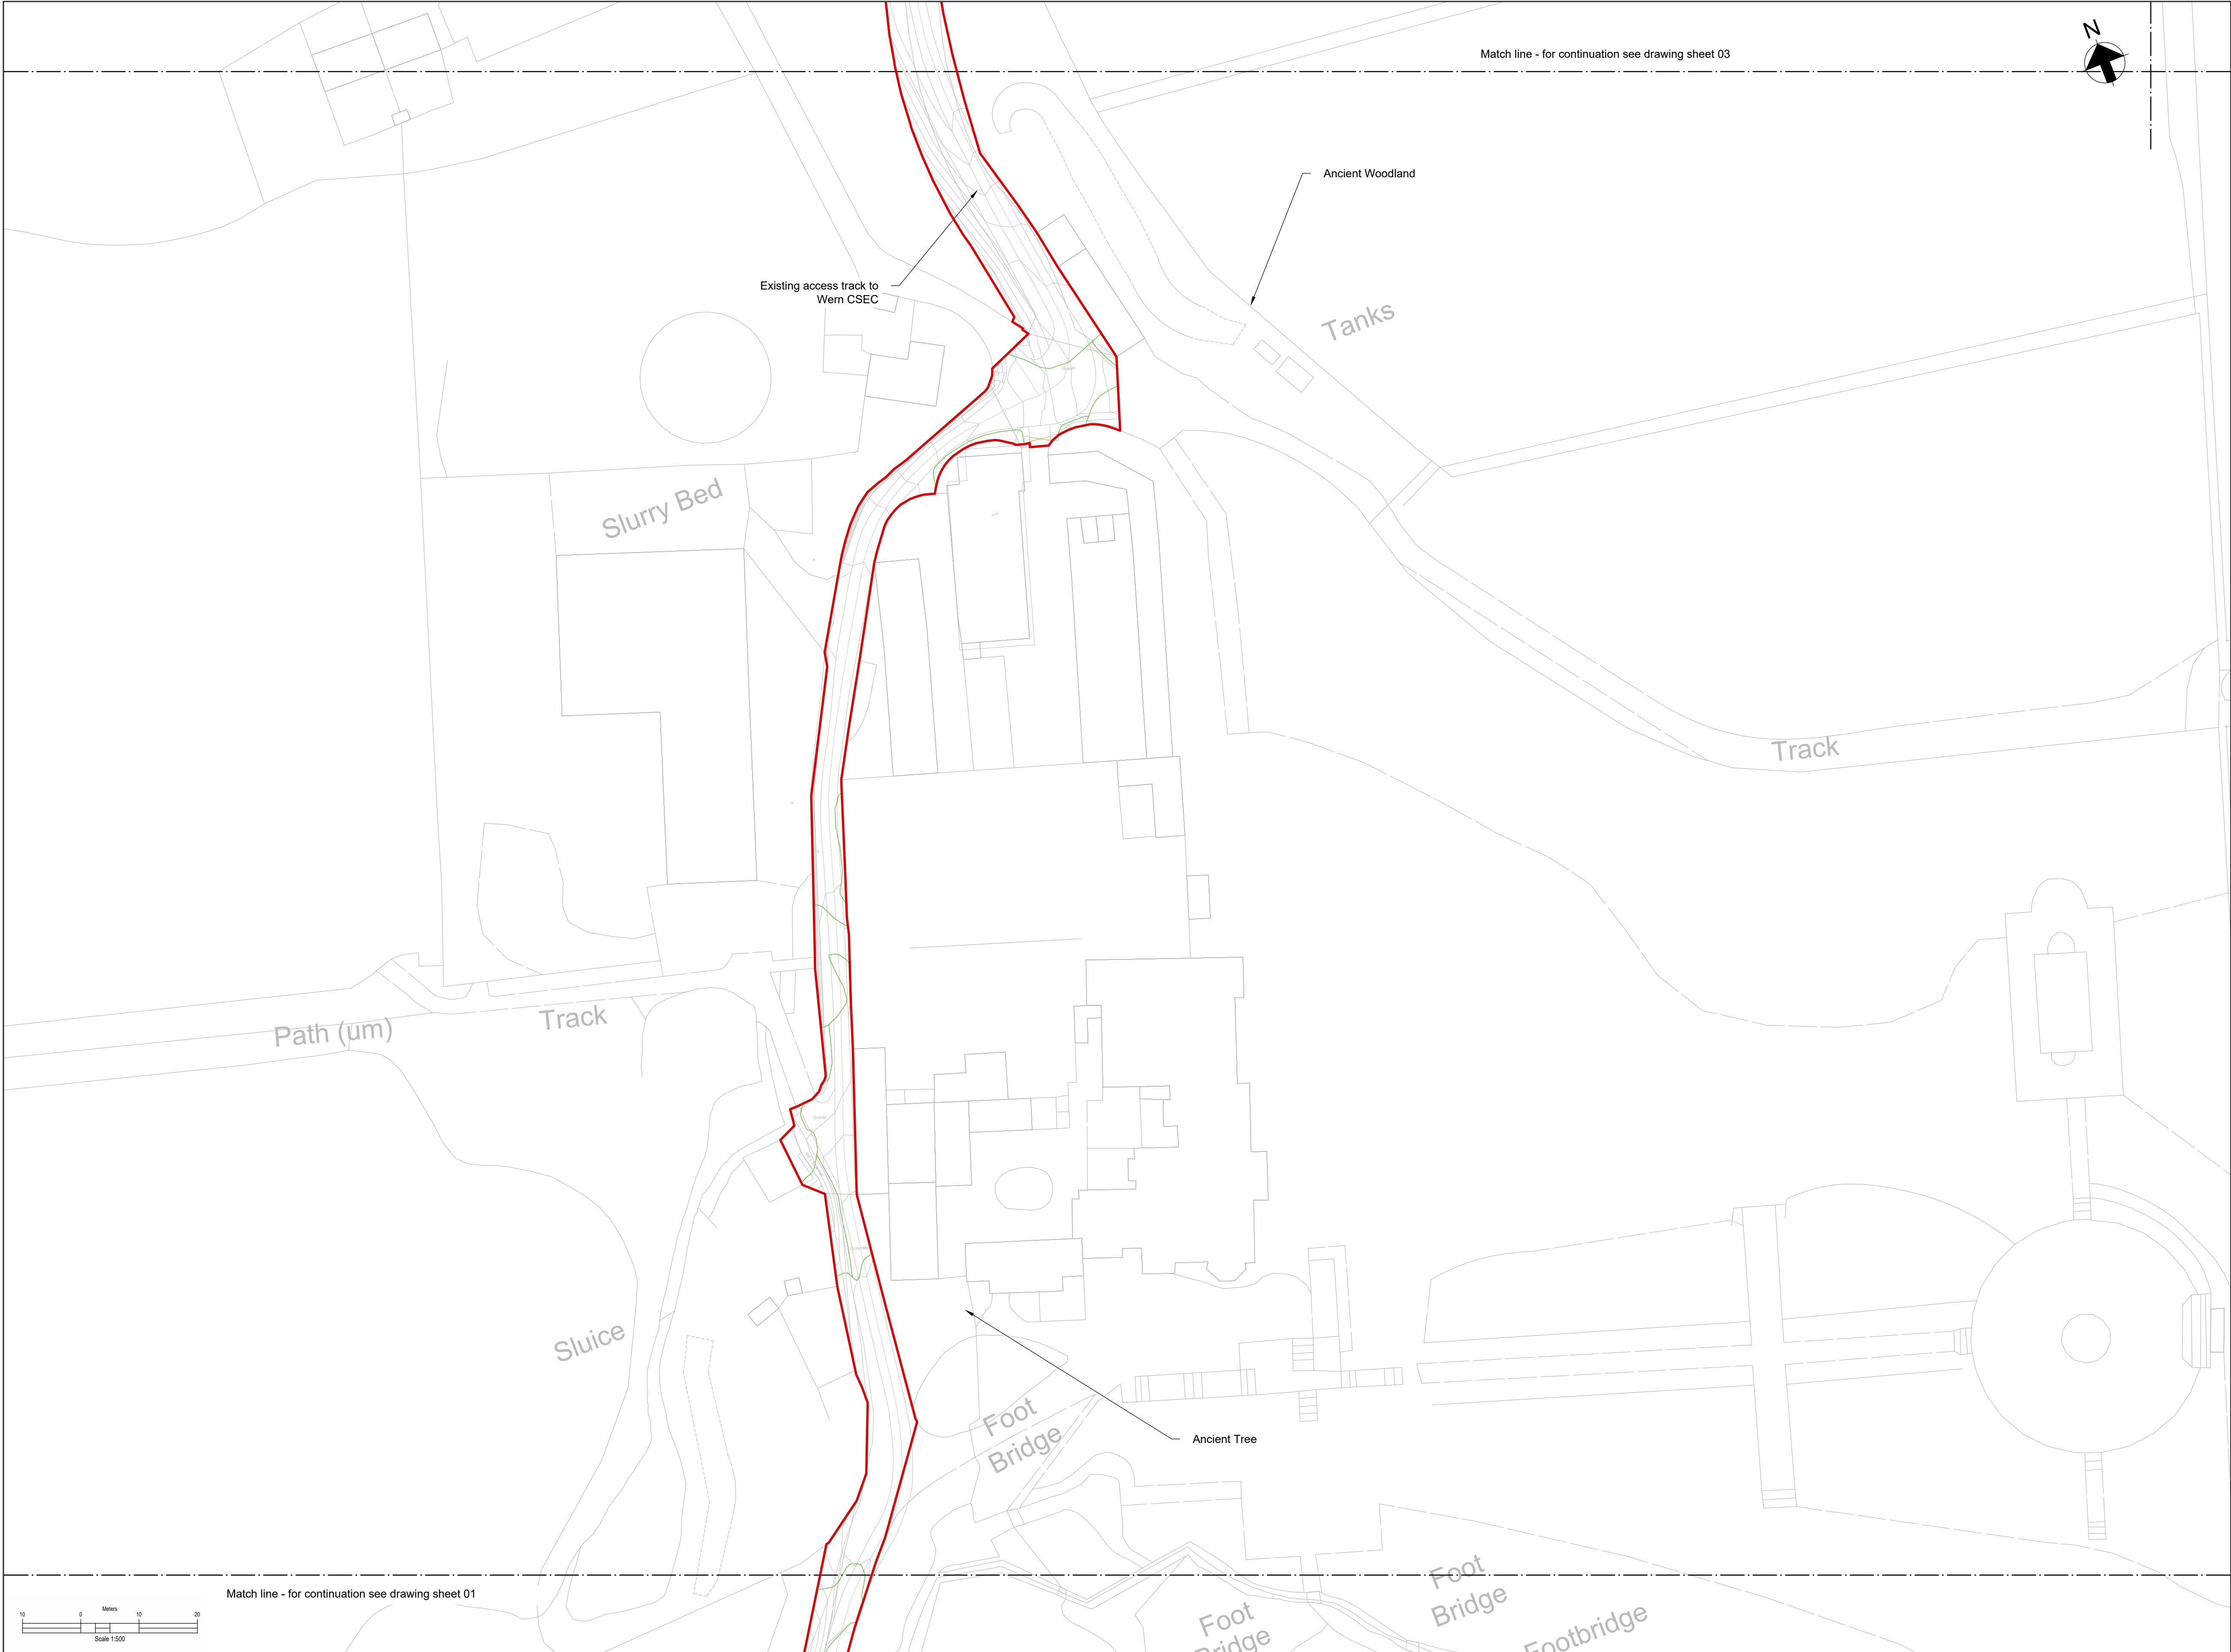


Key Plan

Notes:

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- All levels are in meters Above Ordnance Datum (mAOD)
- Existing ground model and utilities information based on survey MGS54157 dated 08/09/23 and undertaken by Murphy Geospatial, with additional data from subsequent GPR.

Legend:

- Work site boundary
- Existing Watercourse
- Existing Fenceline
- Existing Gate
- Existing trees and vegetation

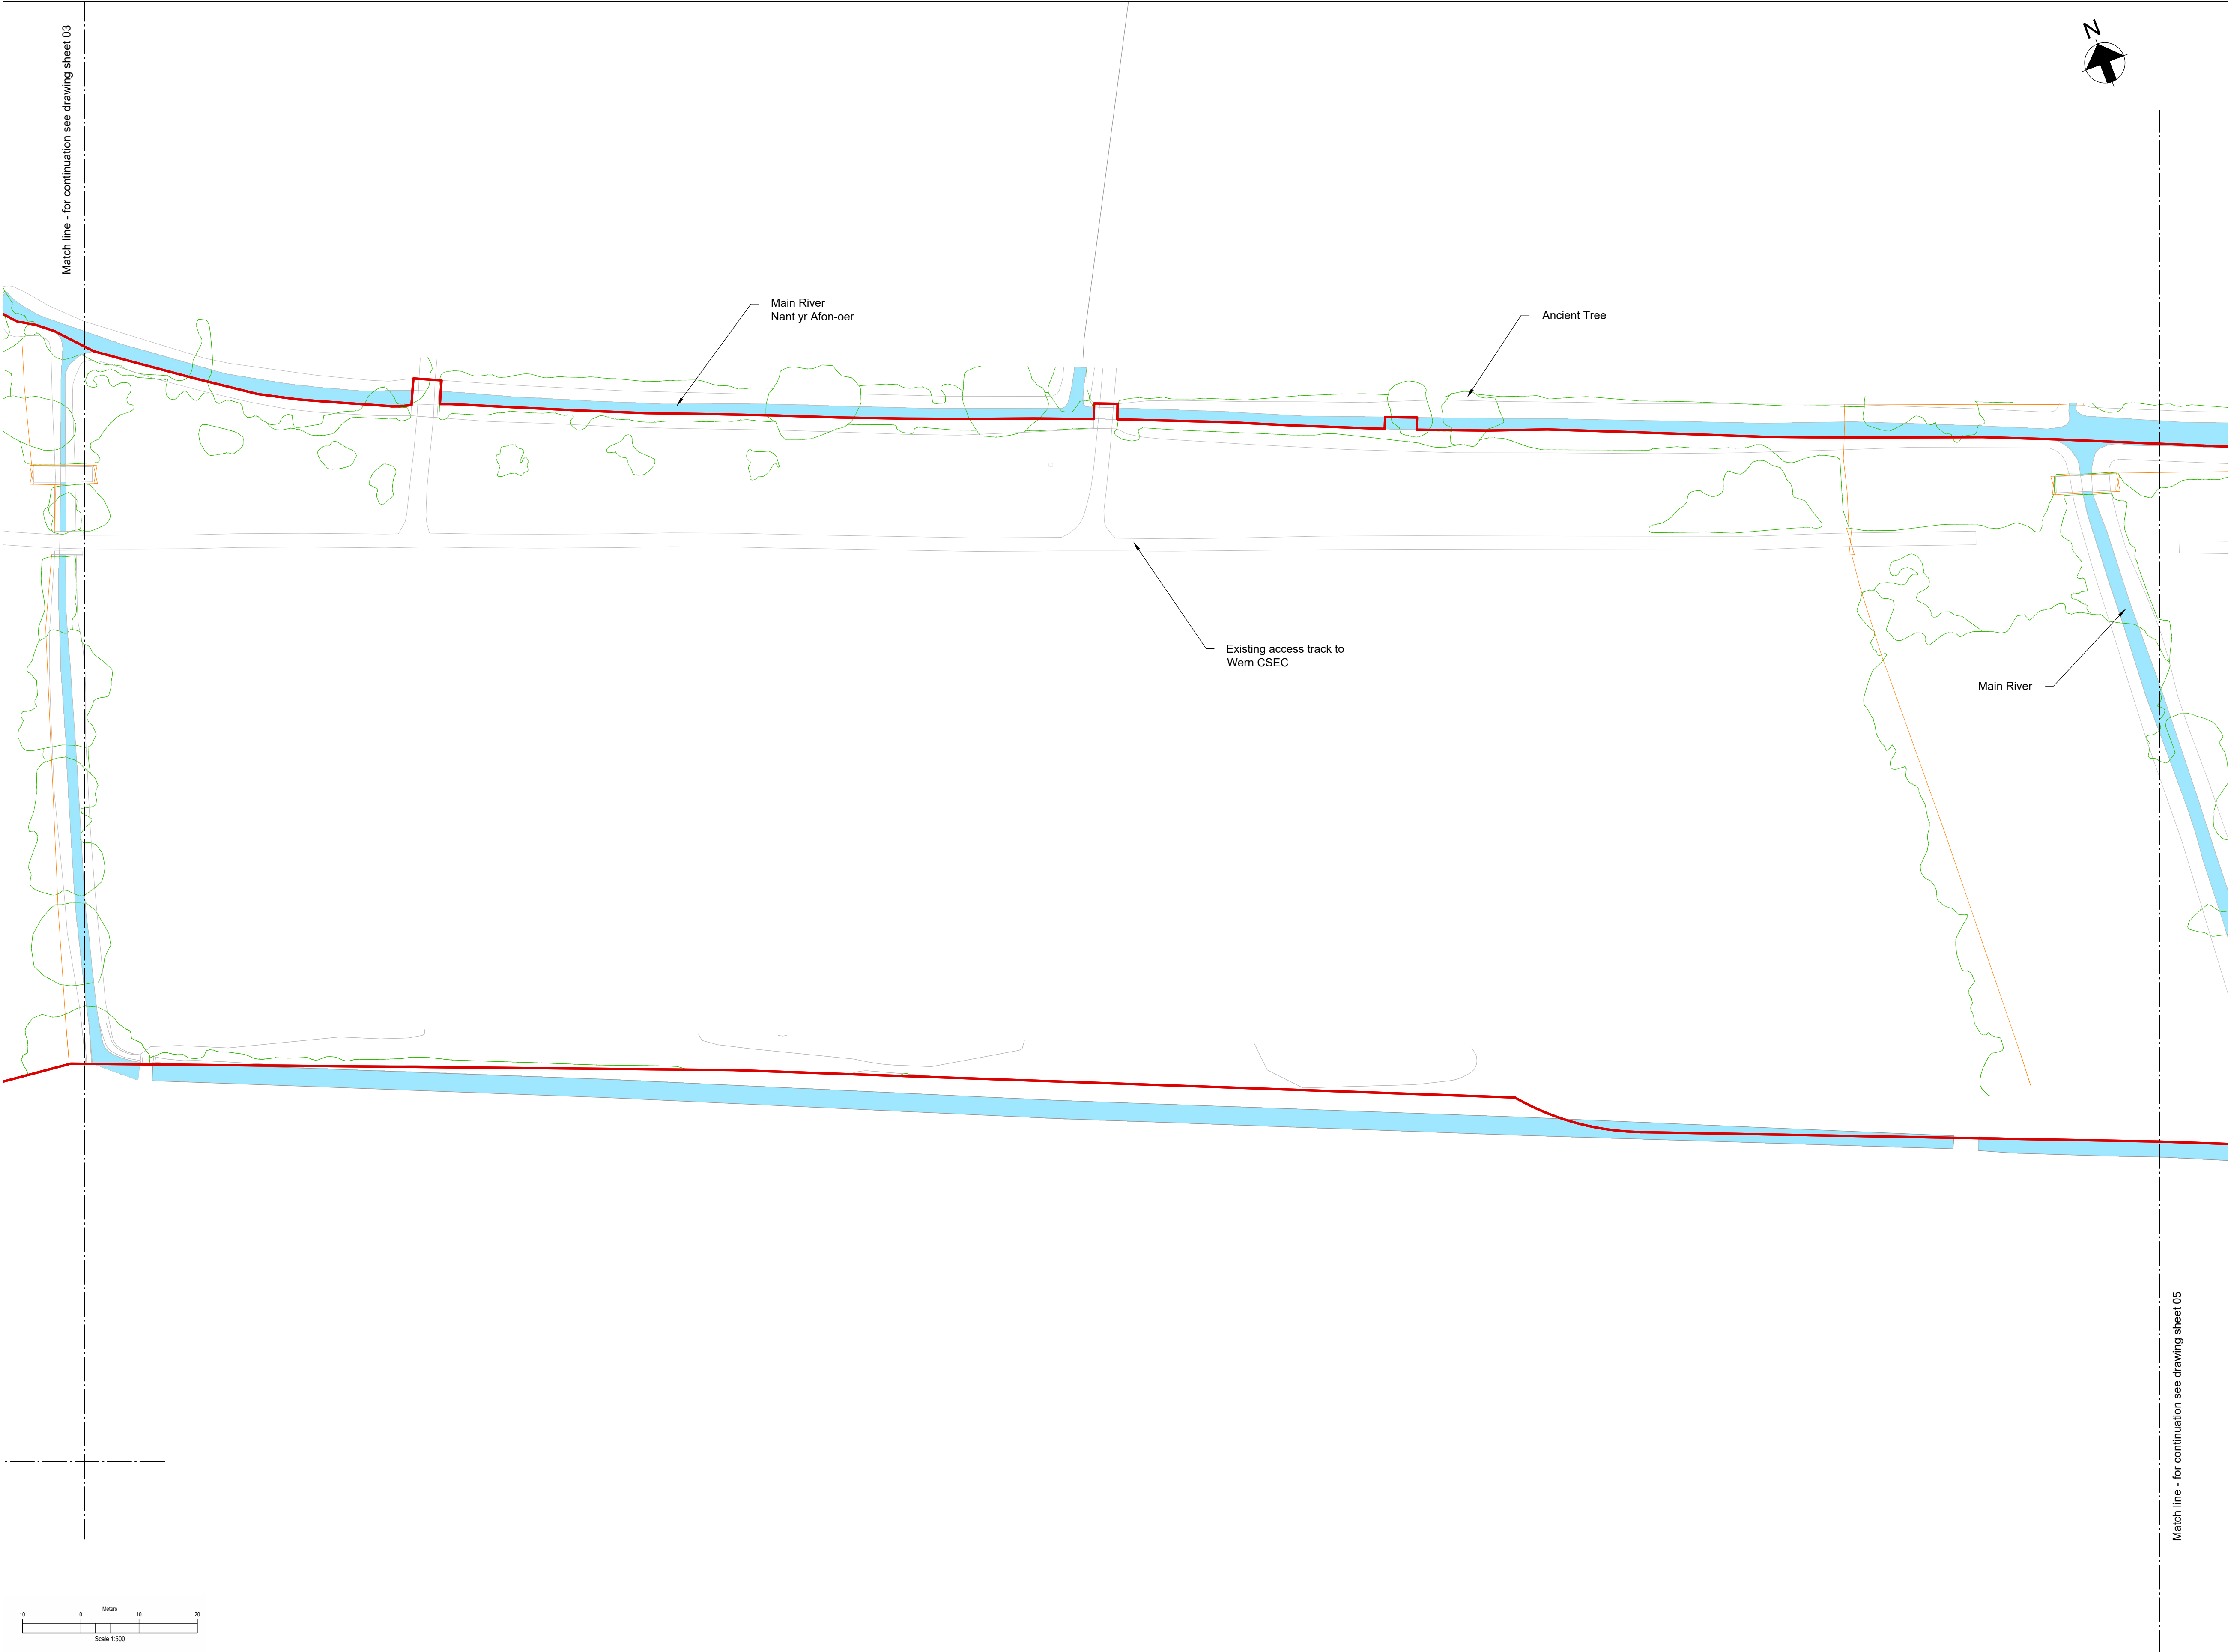

Key Plan

Notes:


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- All dimensions in metres unless otherwise stated.
- All levels are in meters Above Ordnance Datum (mAOD)
- Existing ground model and utilities information based on survey MGS54157 dated 08/09/23 and undertaken by Murphy Geospatial, with additional data from subsequent GPR.

Legend:

- Work site boundary
- Existing Watercourse
- Existing Fenceline
- Existing Gate
- Existing trees and vegetation



Key Plan

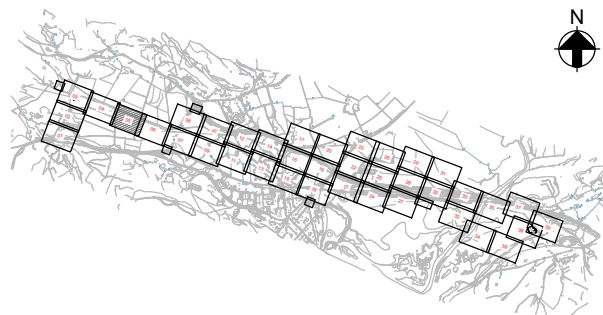

Notes:

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3. All dimensions in metres unless otherwise stated.
4. All levels are in meters Above Ordnance Datum (mAOD)
5. Existing ground model and utilities information based on survey MGS54157 dated 08/09/23 and undertaken by Murphy Geospatial, with additional data from subsequent GPR.

Legend:


Work site boundary

Existing Watercourse

Existing Fenceline

Existing Gate

Existing trees and vegetation

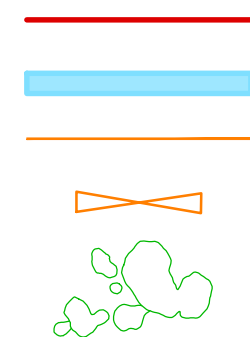

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Dwg Title:
Planning Drawings
Existing Site Plans
Sheet 5

Site: Glaslyn Cable Upgrading

A1	100%
----	------

CAD

Originator
Dwg No: GLAS-ARUP-70-XX-DR-X-9005

Originators	
Proj.Ref:	295280-00

NG Investment	
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Sheet M

Total No.

Issue:

Scale: 1:500

5

39

C



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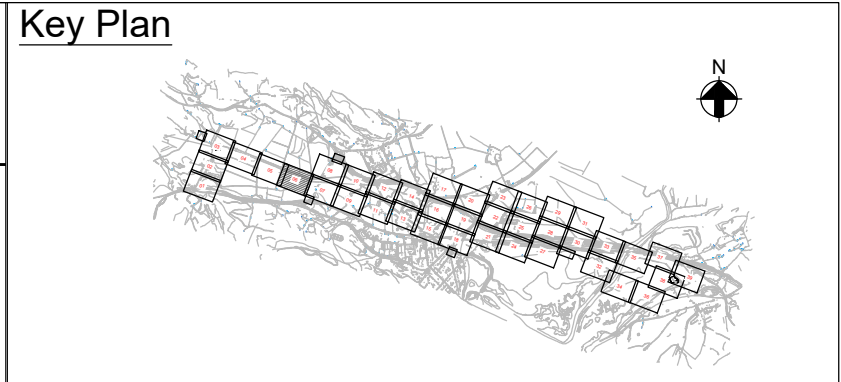
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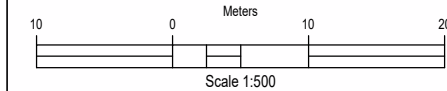
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 4. All levels are in meters Above Ordnance Datum (mAOD)
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- Legend:**
- Work site boundary
 - Existing Watercourse
 - Existing Fenceline
 - Existing Gate
 - Existing trees and vegetation



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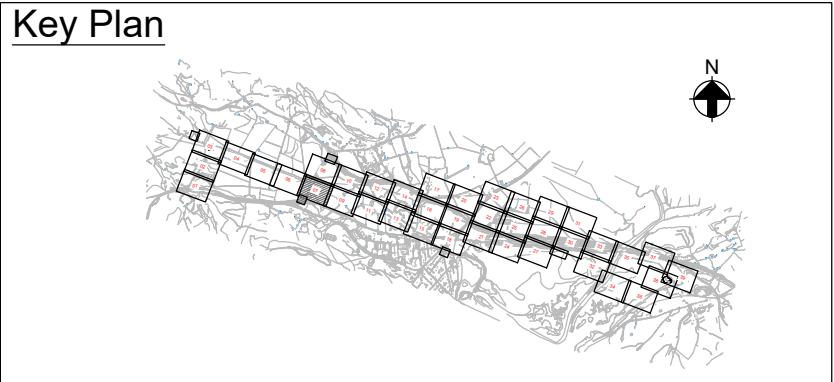
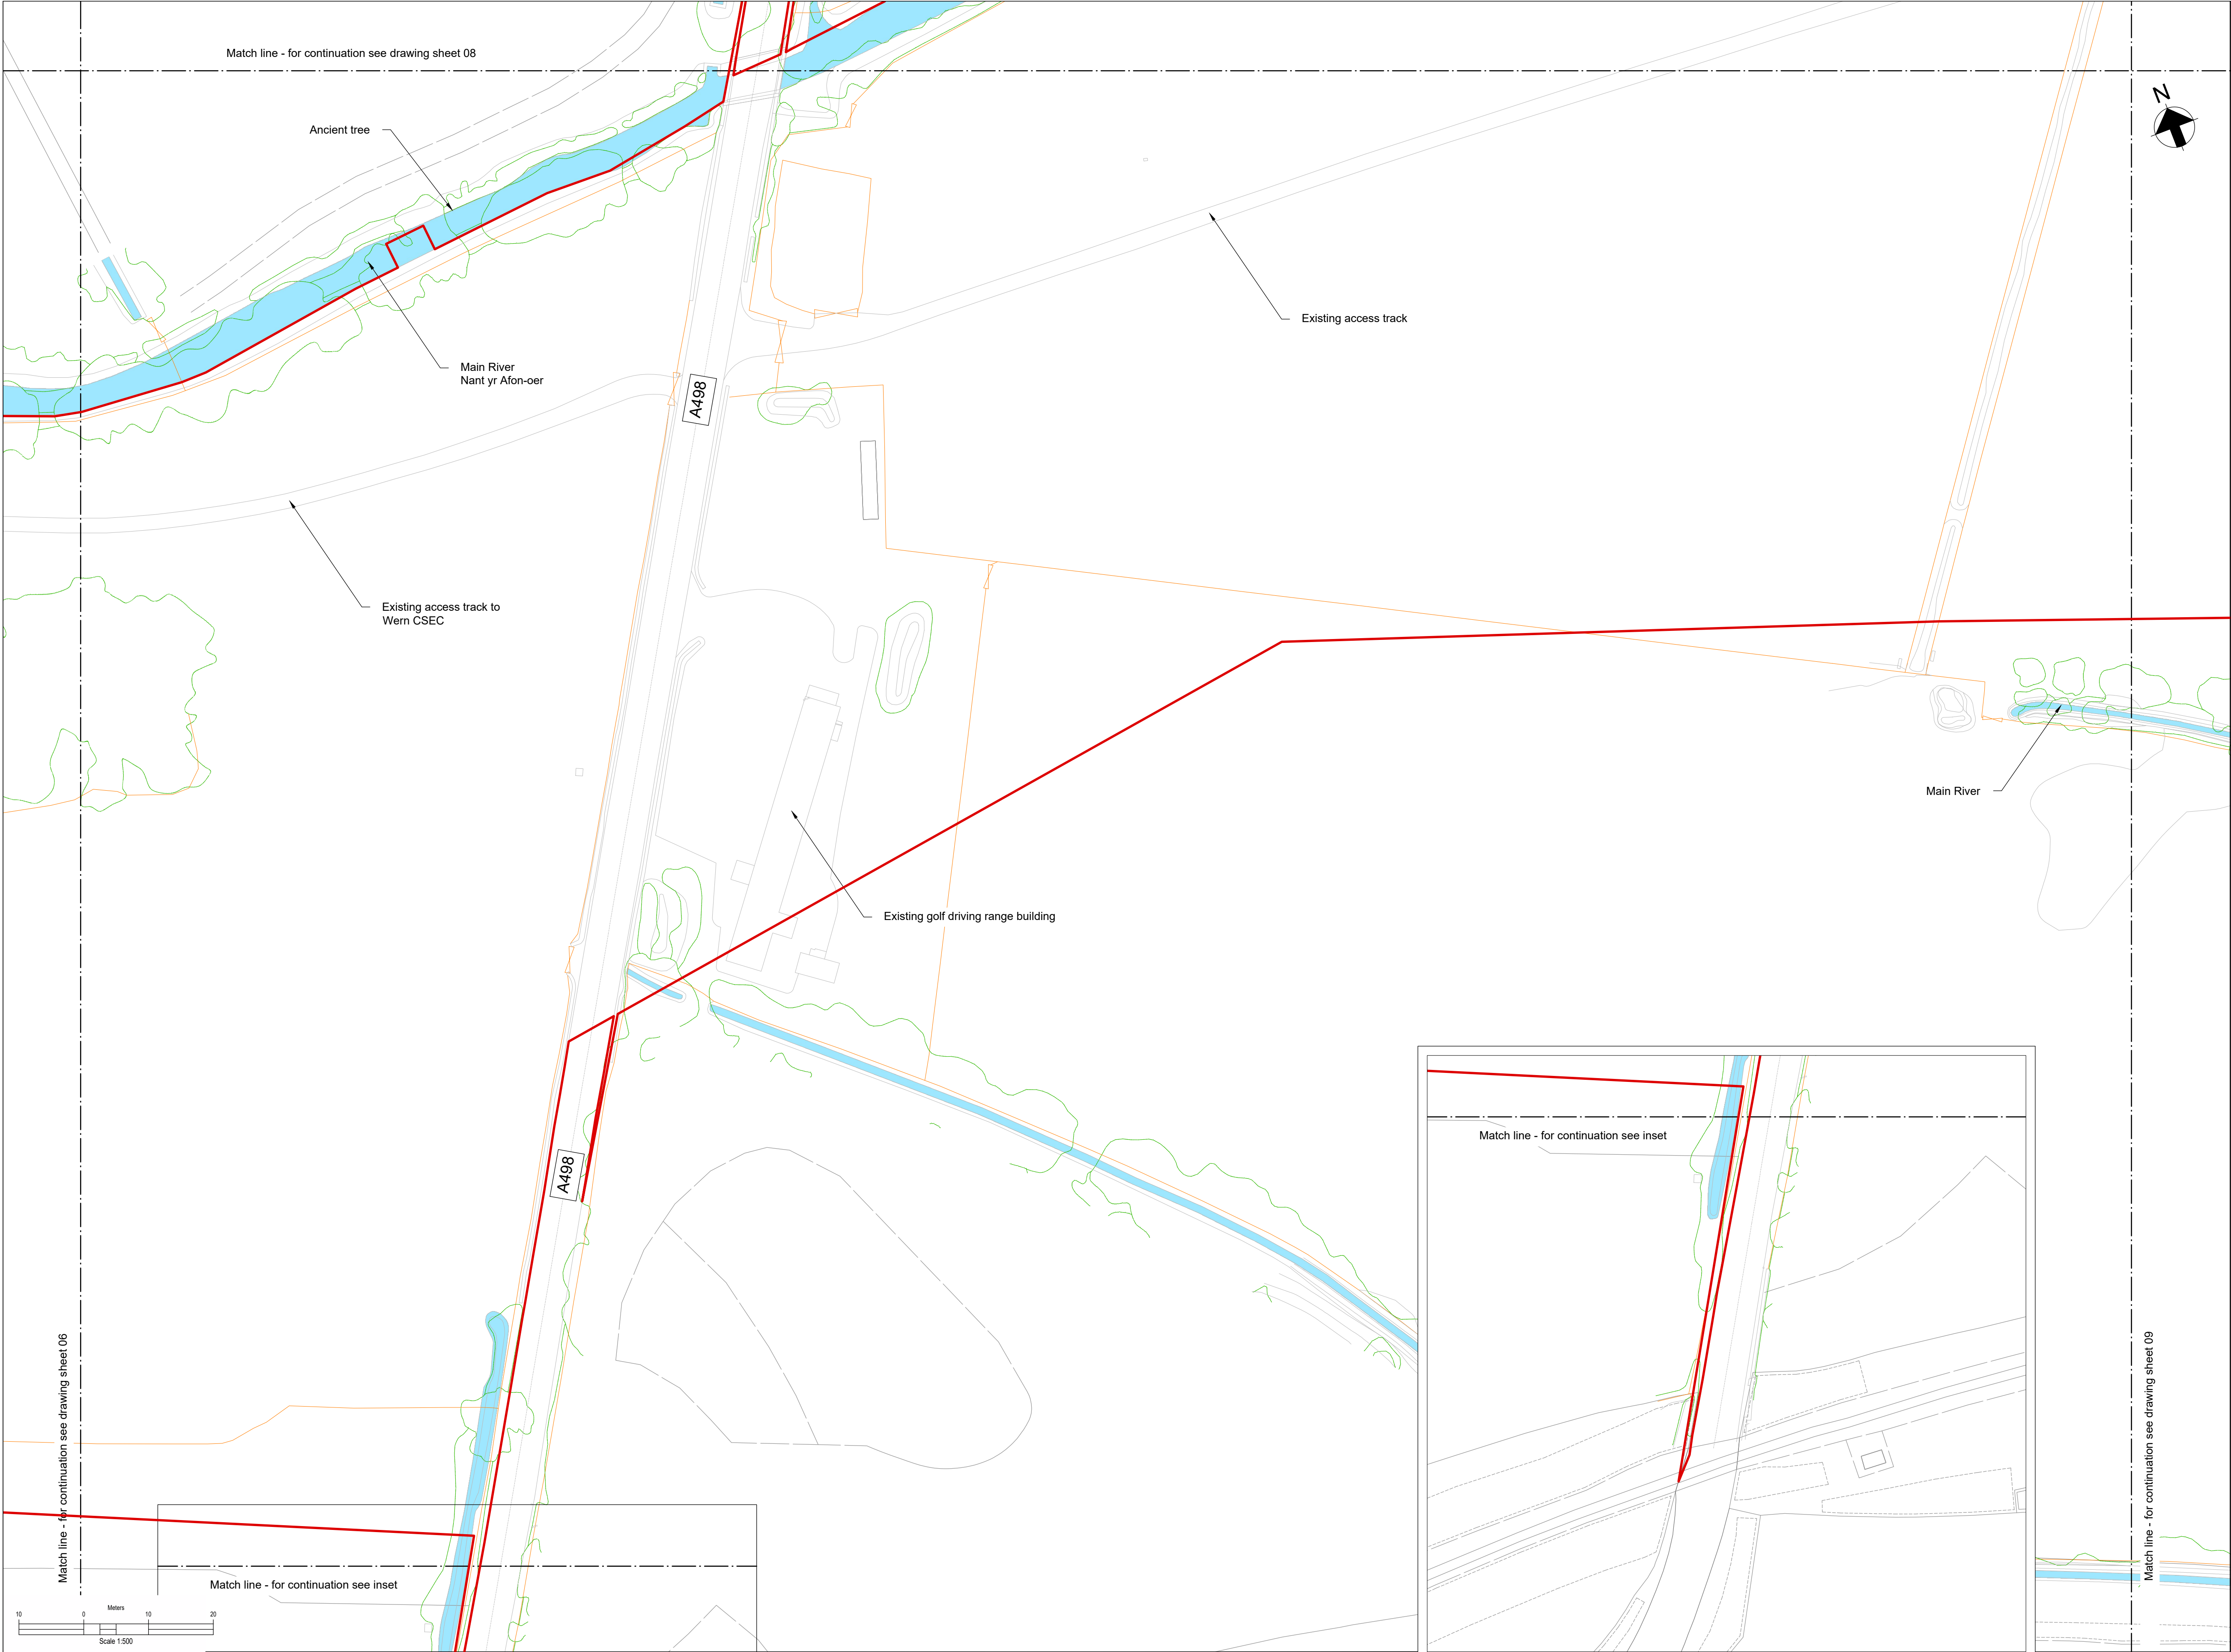
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Dwg Title:
**Planning Drawings
Existing Site Plans
Sheet 6**

Site: Glaslyn Cable Uprating		A1 100%	CAD
Originator: Dwg No: GLAS-ARUP-70-XX-DR-X-9006	Originators Proj.Ref: 295280-00		
NG Investment No:	Sheet No: 6	Total No. of Sheets 39	Issue: C
NG Dwg No:			
Scale: 1:500			



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Legend:

- Work site boundary
- Existing Watercourse
- Existing Fenceline
- Existing Gate
- Existing trees and vegetation

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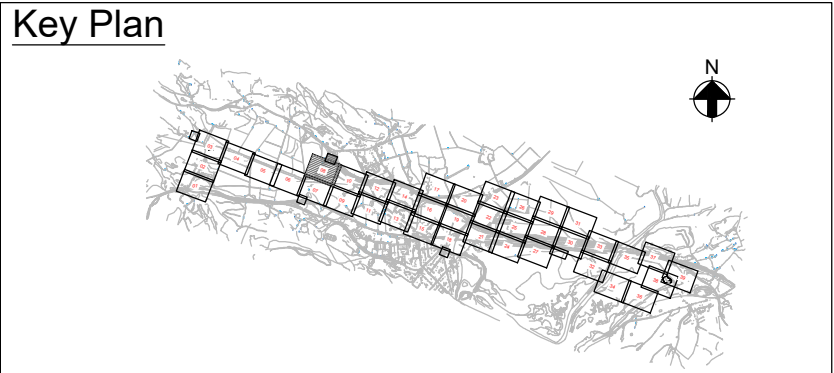
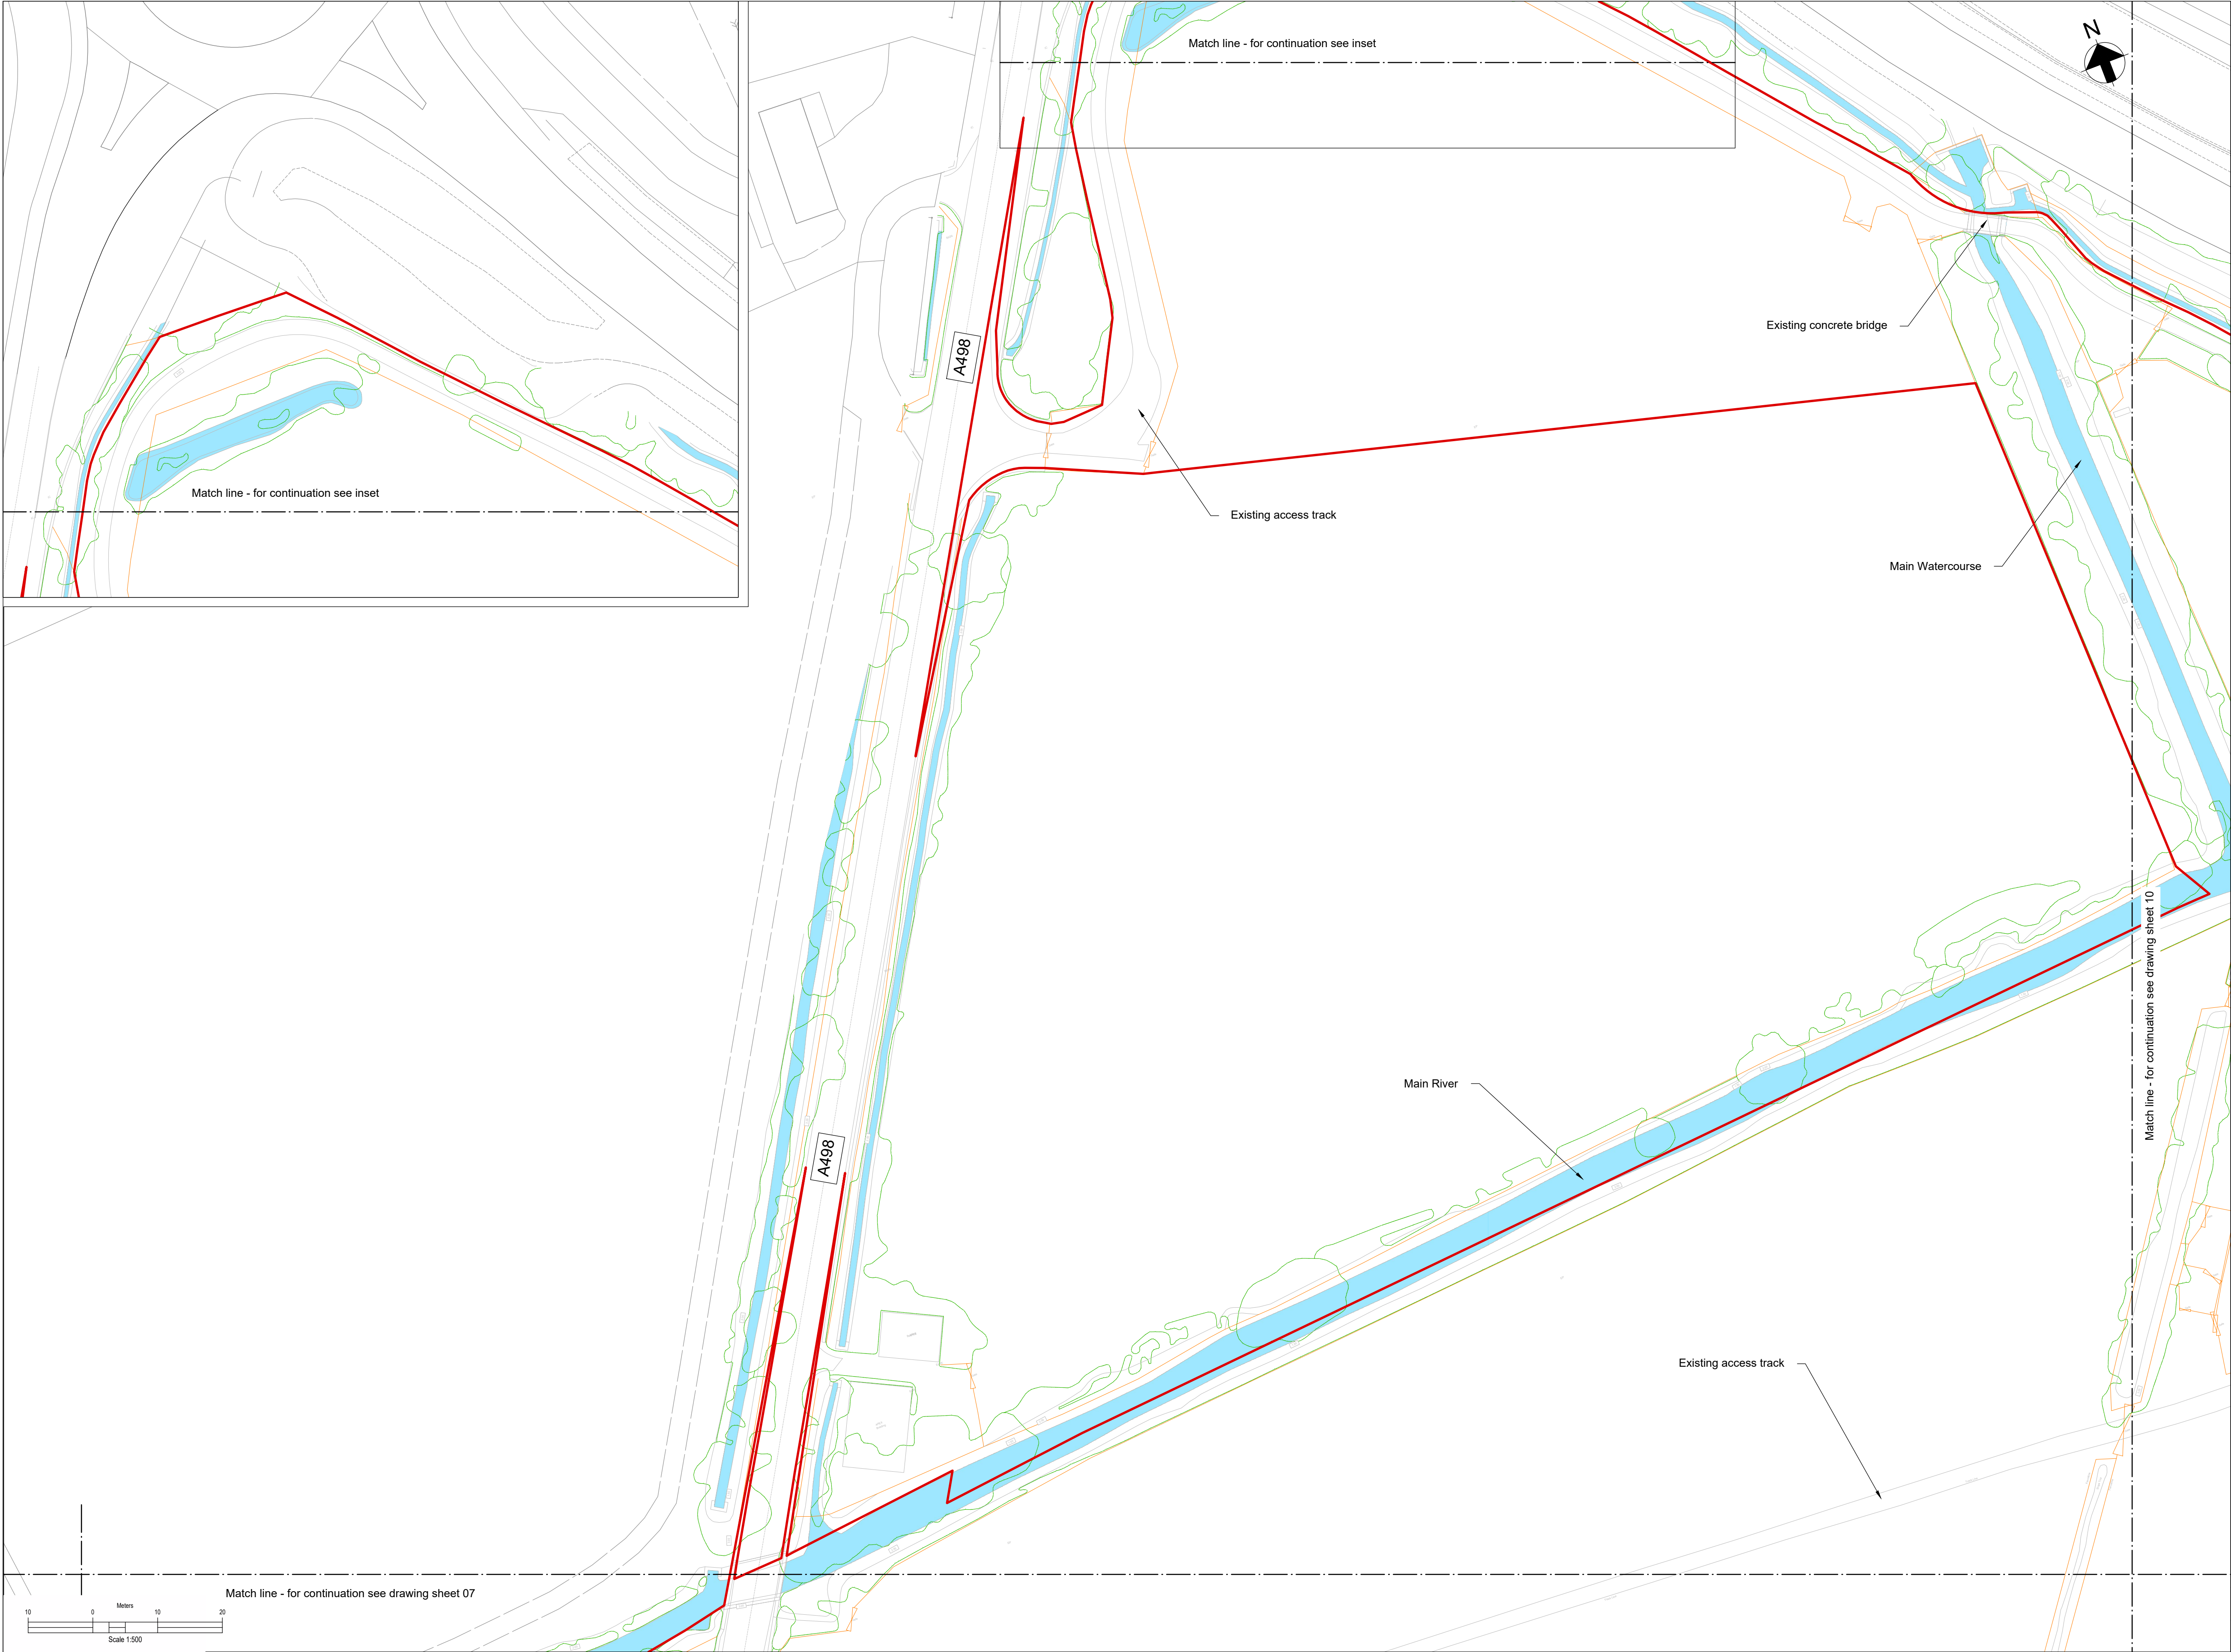
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
Dwg Title: Planning Drawings Existing Site Plans Sheet 7

Site: Glaslyn Cable Uprating	A1 100%	CAD
Originator: GLAS-ARUP-70-XX-DR-X-9007	Originators Proj.Ref: 295280-00	
NG Investment No:	Sheet No: 7	Total No. of Sheets: 39
NG Dwg No:		Issue: C
Scale: 1:500		




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 - All levels are in metres Above Ordnance Datum (mAOD)
 - Existing ground model and utilities information based on survey MGS54157 dated 08/09/23 and undertaken by Murphy Geospatial, with additional data from subsequent GPR.


- Legend:**
- Work site boundary
 - Existing Watercourse
 - Existing Fenceline
 - Existing Gate
 - Existing trees and vegetation



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


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A	11/06/25	RA	JL	GT	Issued For Planning




Dwg Title:
**Planning Drawings
Existing Site Plans
Sheet 8**

Site: Glaslyn Cable Uprating	A1 100%	CAD
Originator Dwg No: GLAS-ARUP-70-XX-DR-X-9008	Originators Proj.Ref: 295280-00	
NG Investment No:	Sheet No:	Total No. of Sheets
NG Dwg No:	8	39
Scale: 1:500		Issue: C

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Key Plan

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Legend:


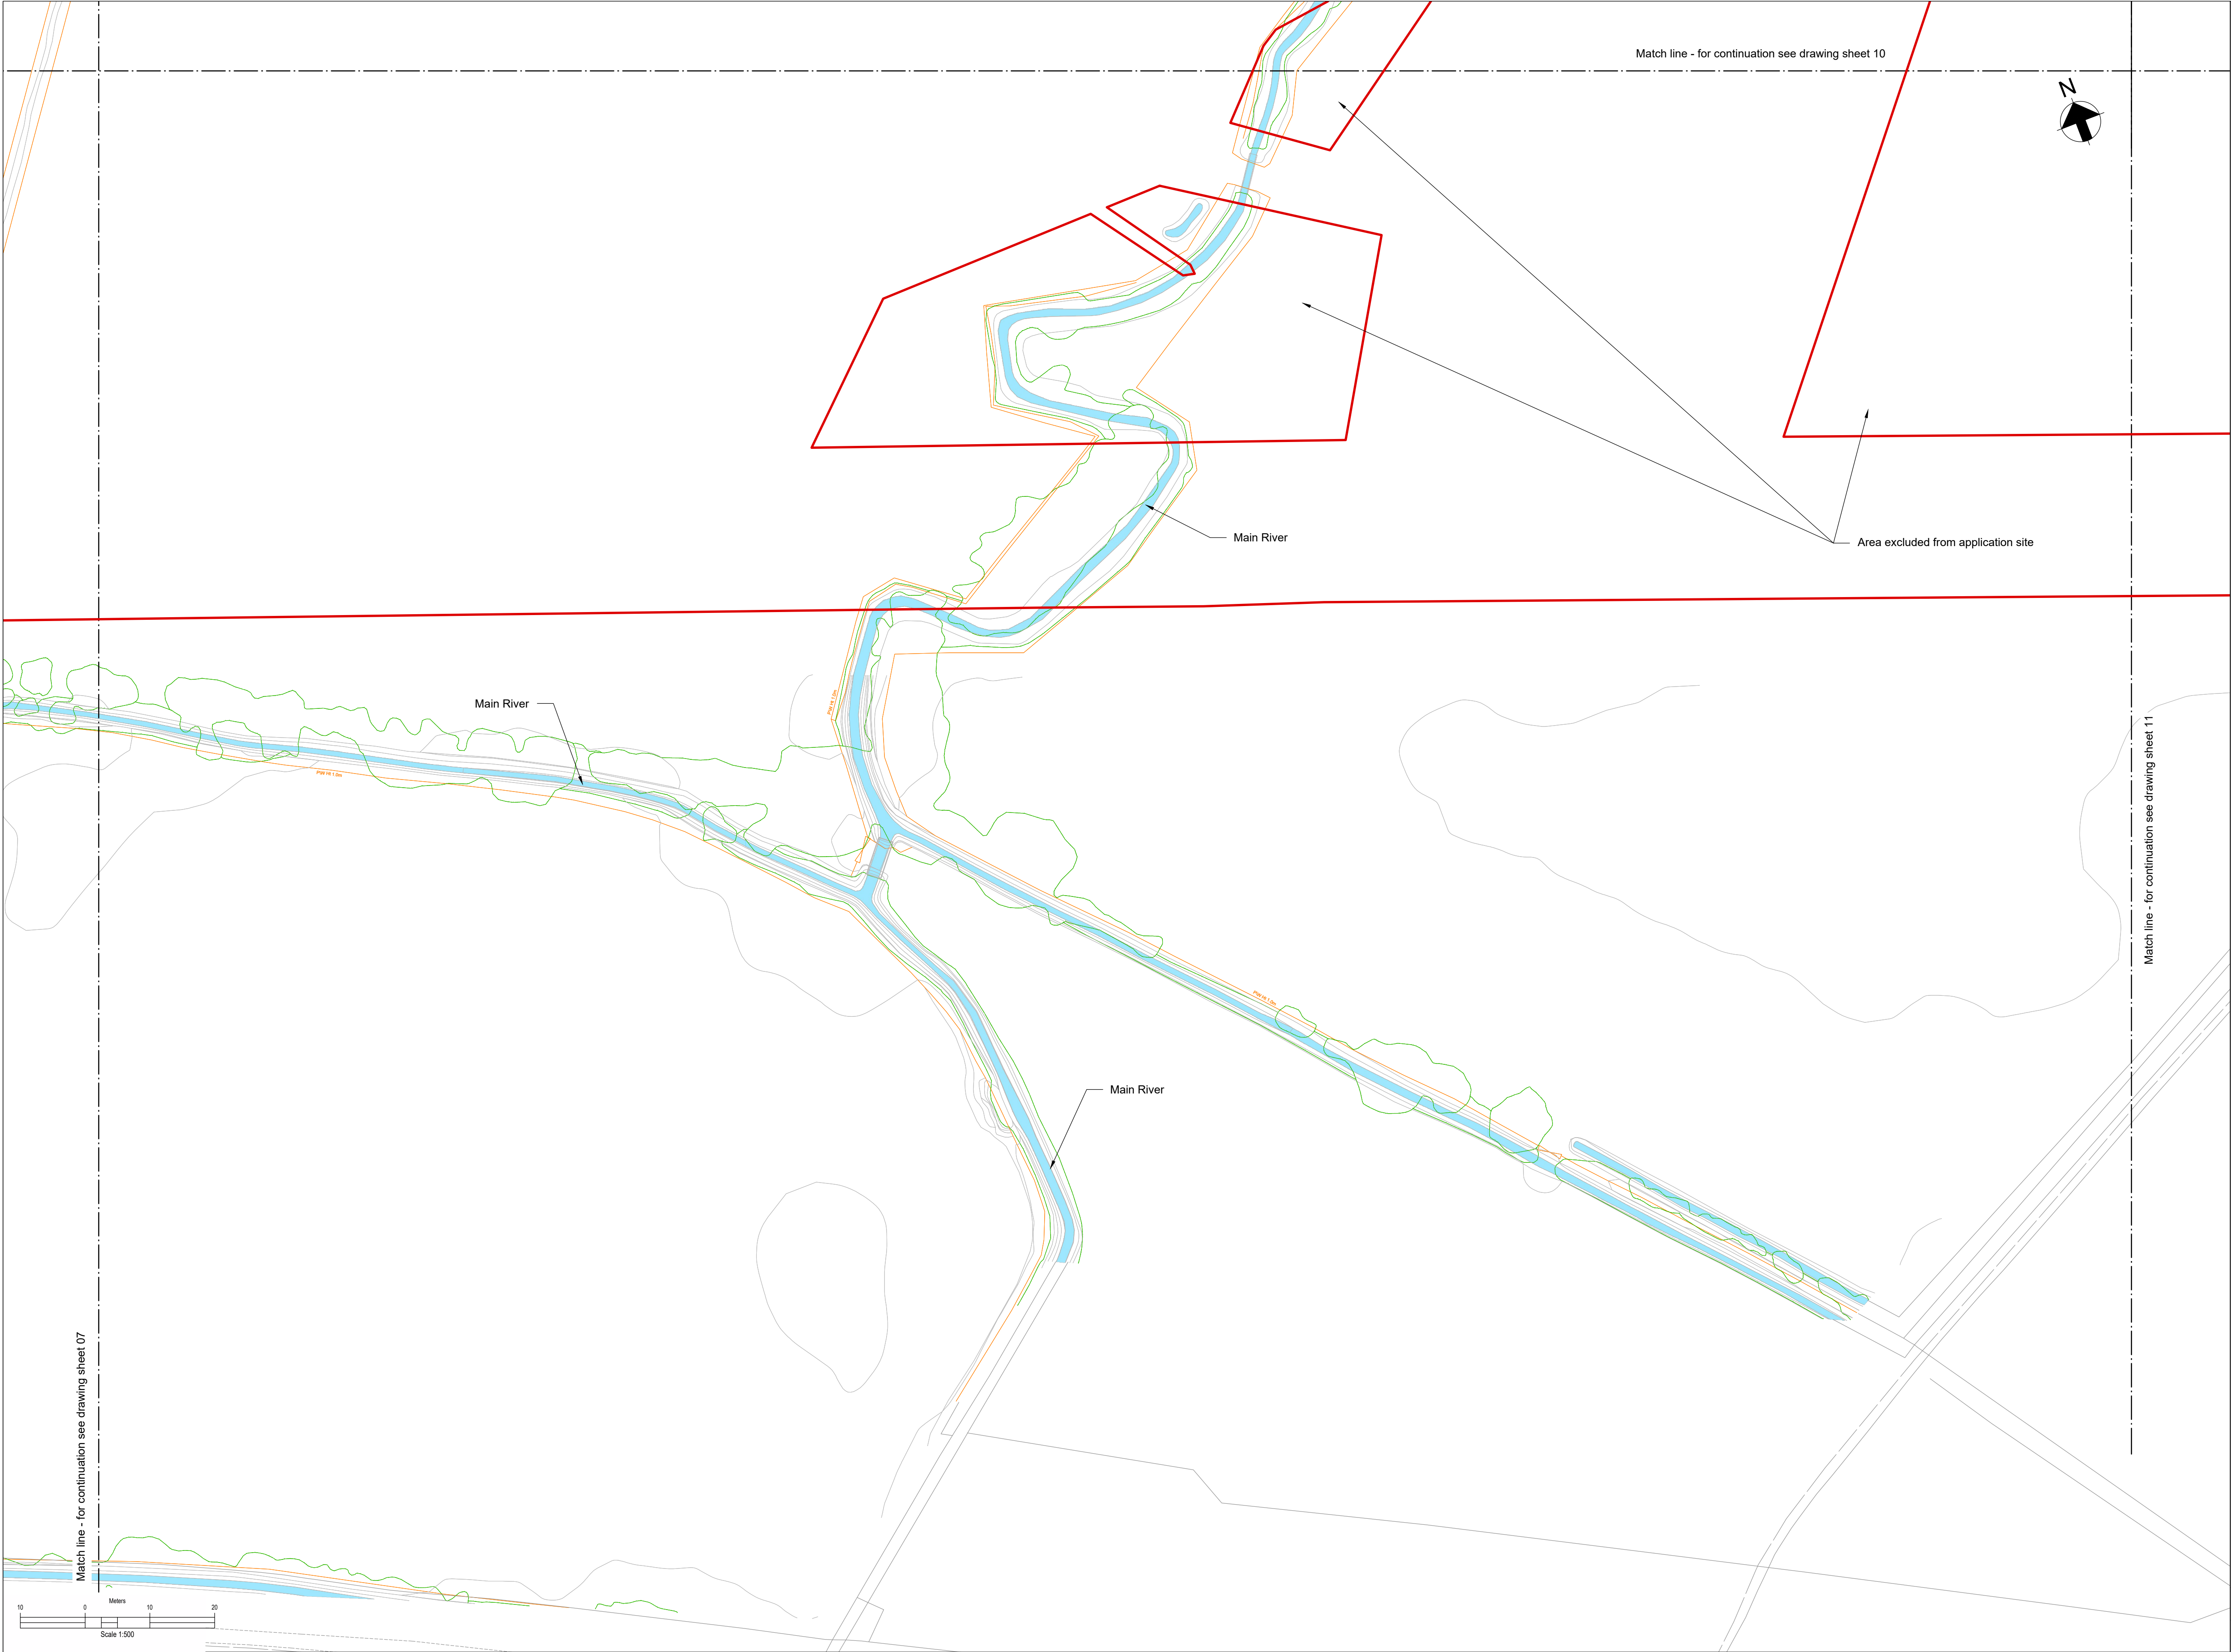
Work site boundary

Existing Watercourse

Existing Fenceline


Existing Gate

Existing trees and vegetation

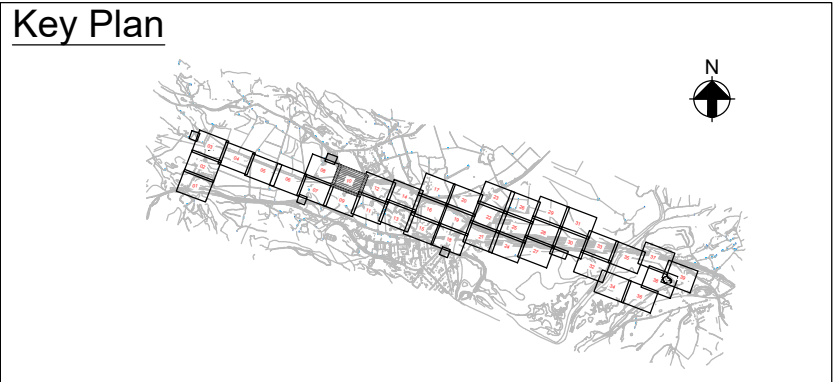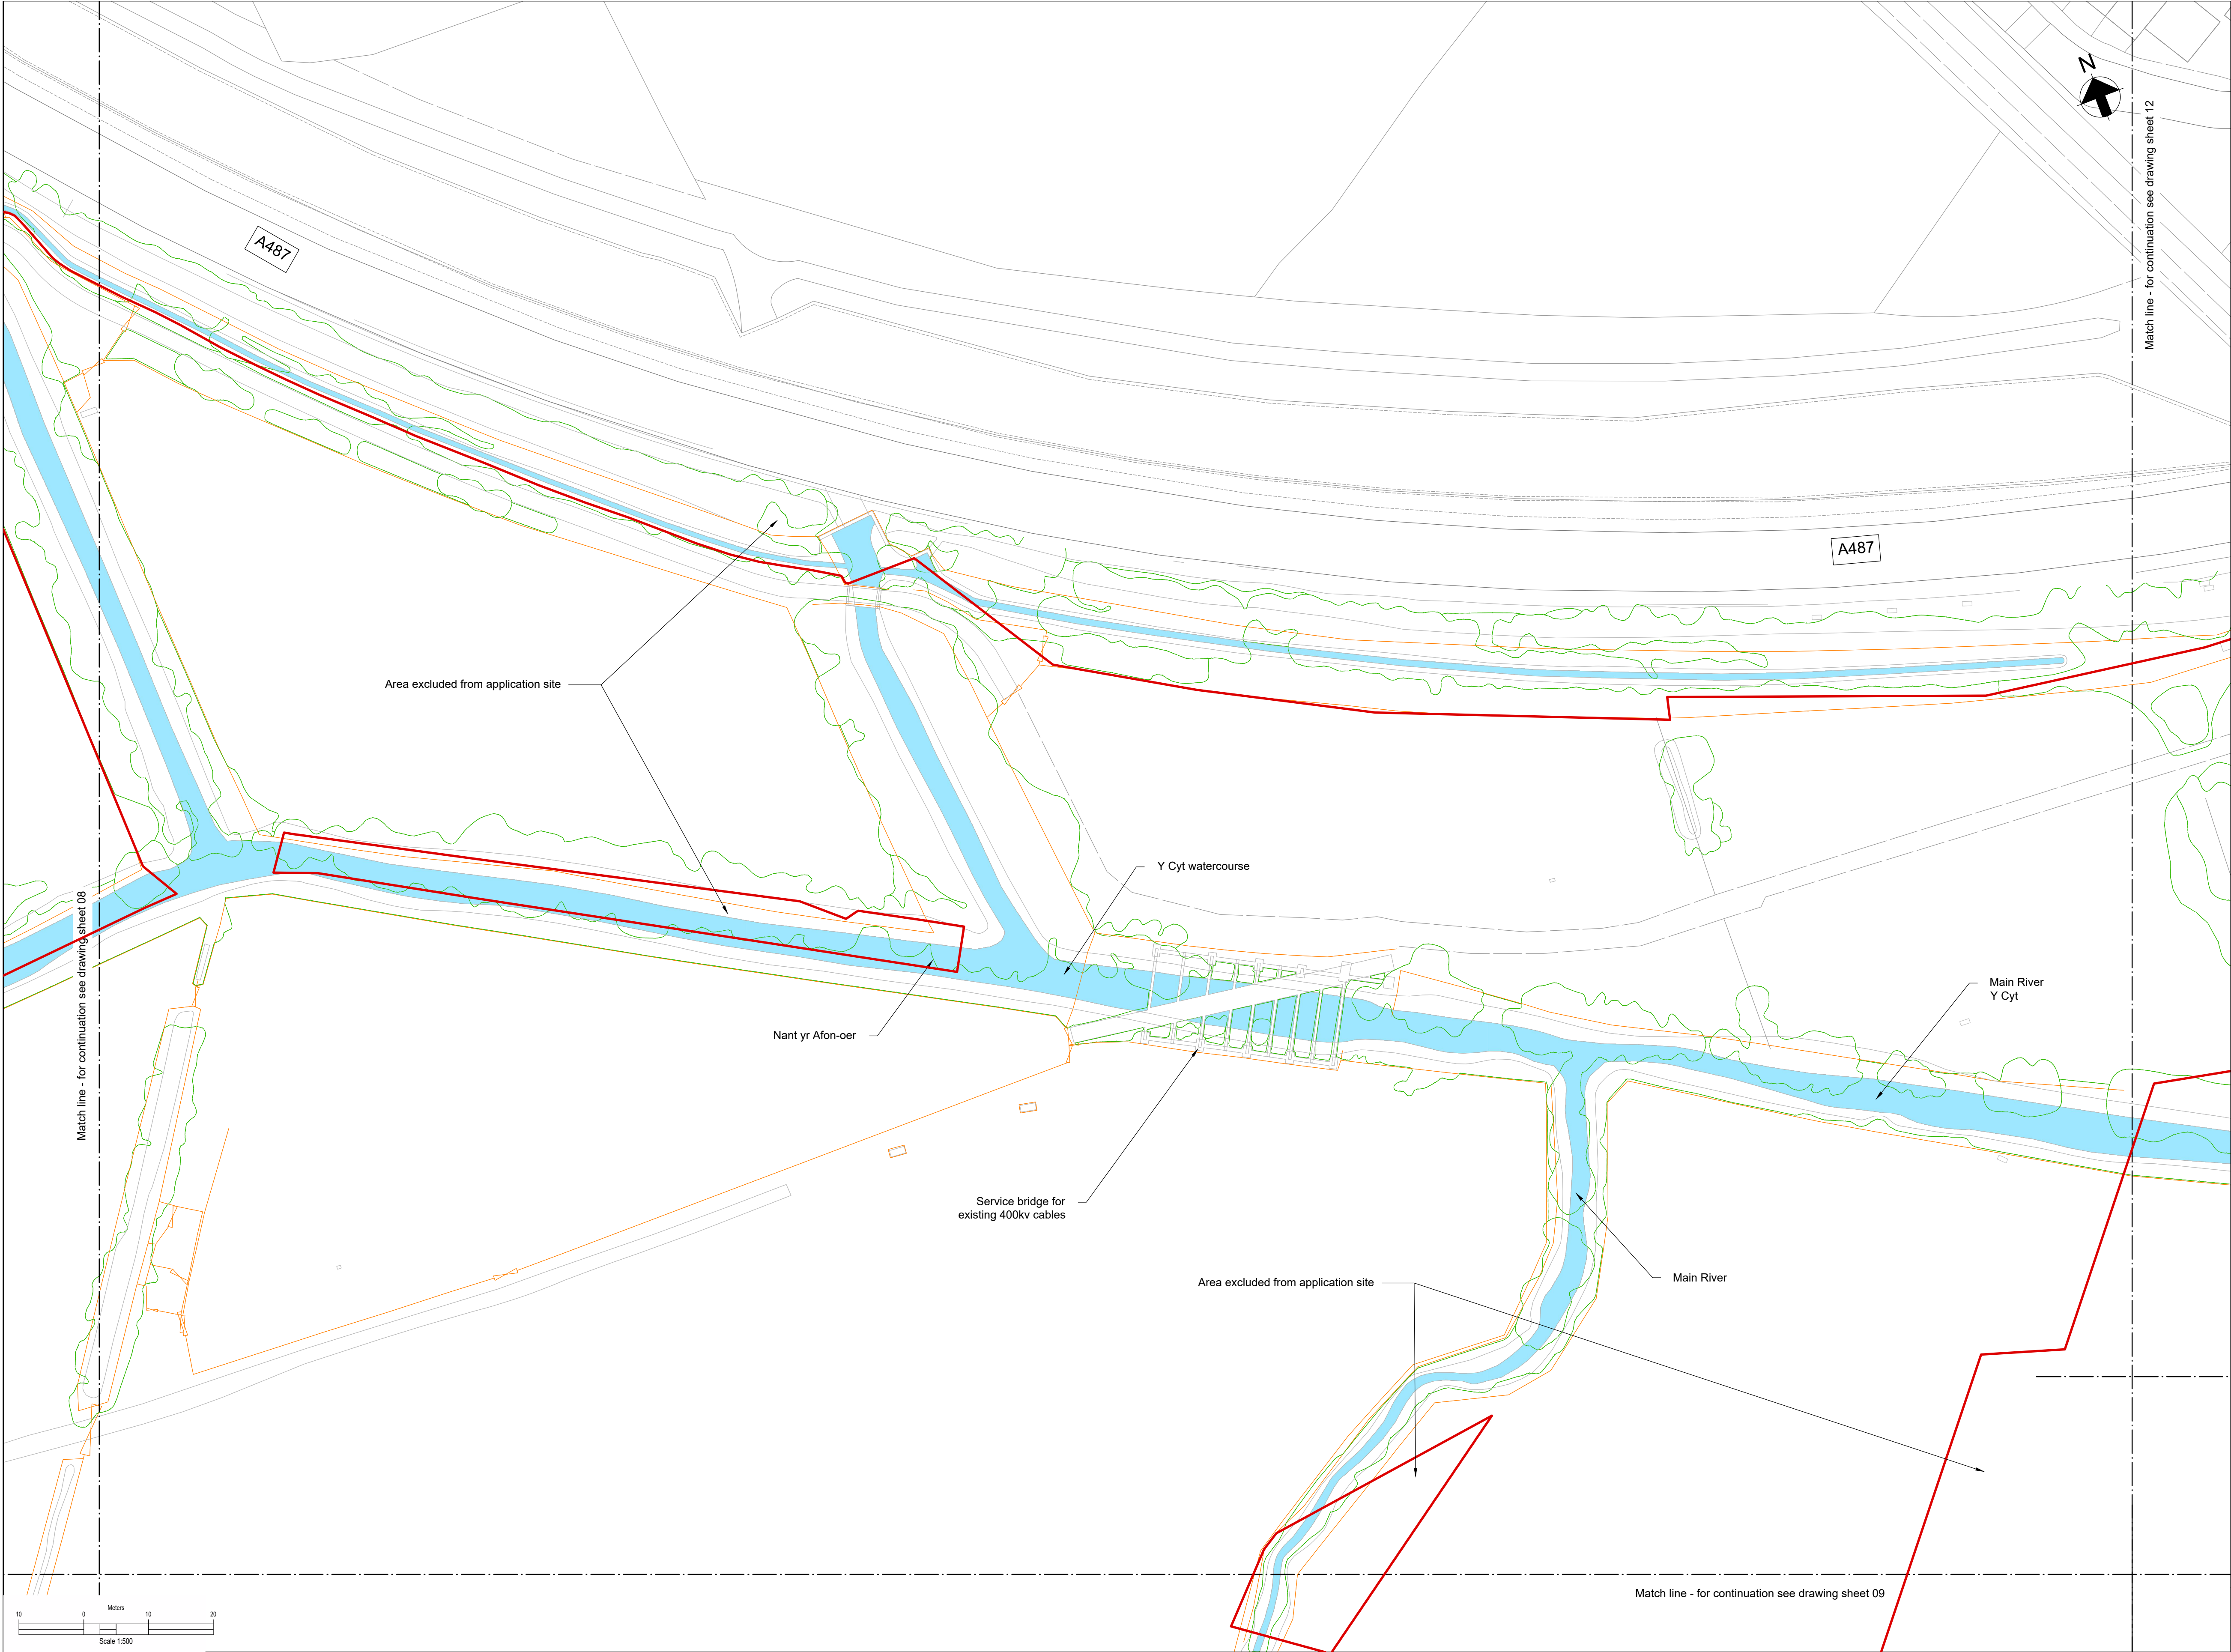

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 3. All dimensions in metres unless otherwise stated.
 4. All levels are in meters Above Ordnance Datum (mAOD)
 5. Existing ground model and utilities information based on survey MGS54157 dated 08/09/23 and undertaken by Murphy Geospatial, with additional data from subsequent GPR.

- Legend:
- Work site boundary
 - Existing Watercourse
 - Existing Fenceline
 - Existing Gate
 - Existing trees and vegetation

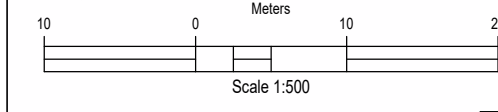

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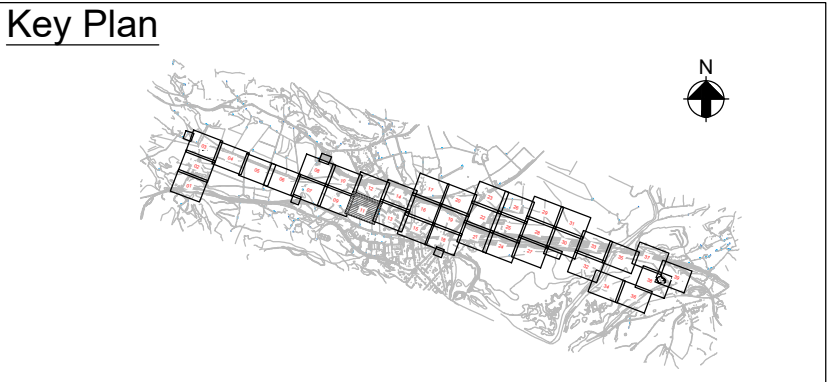
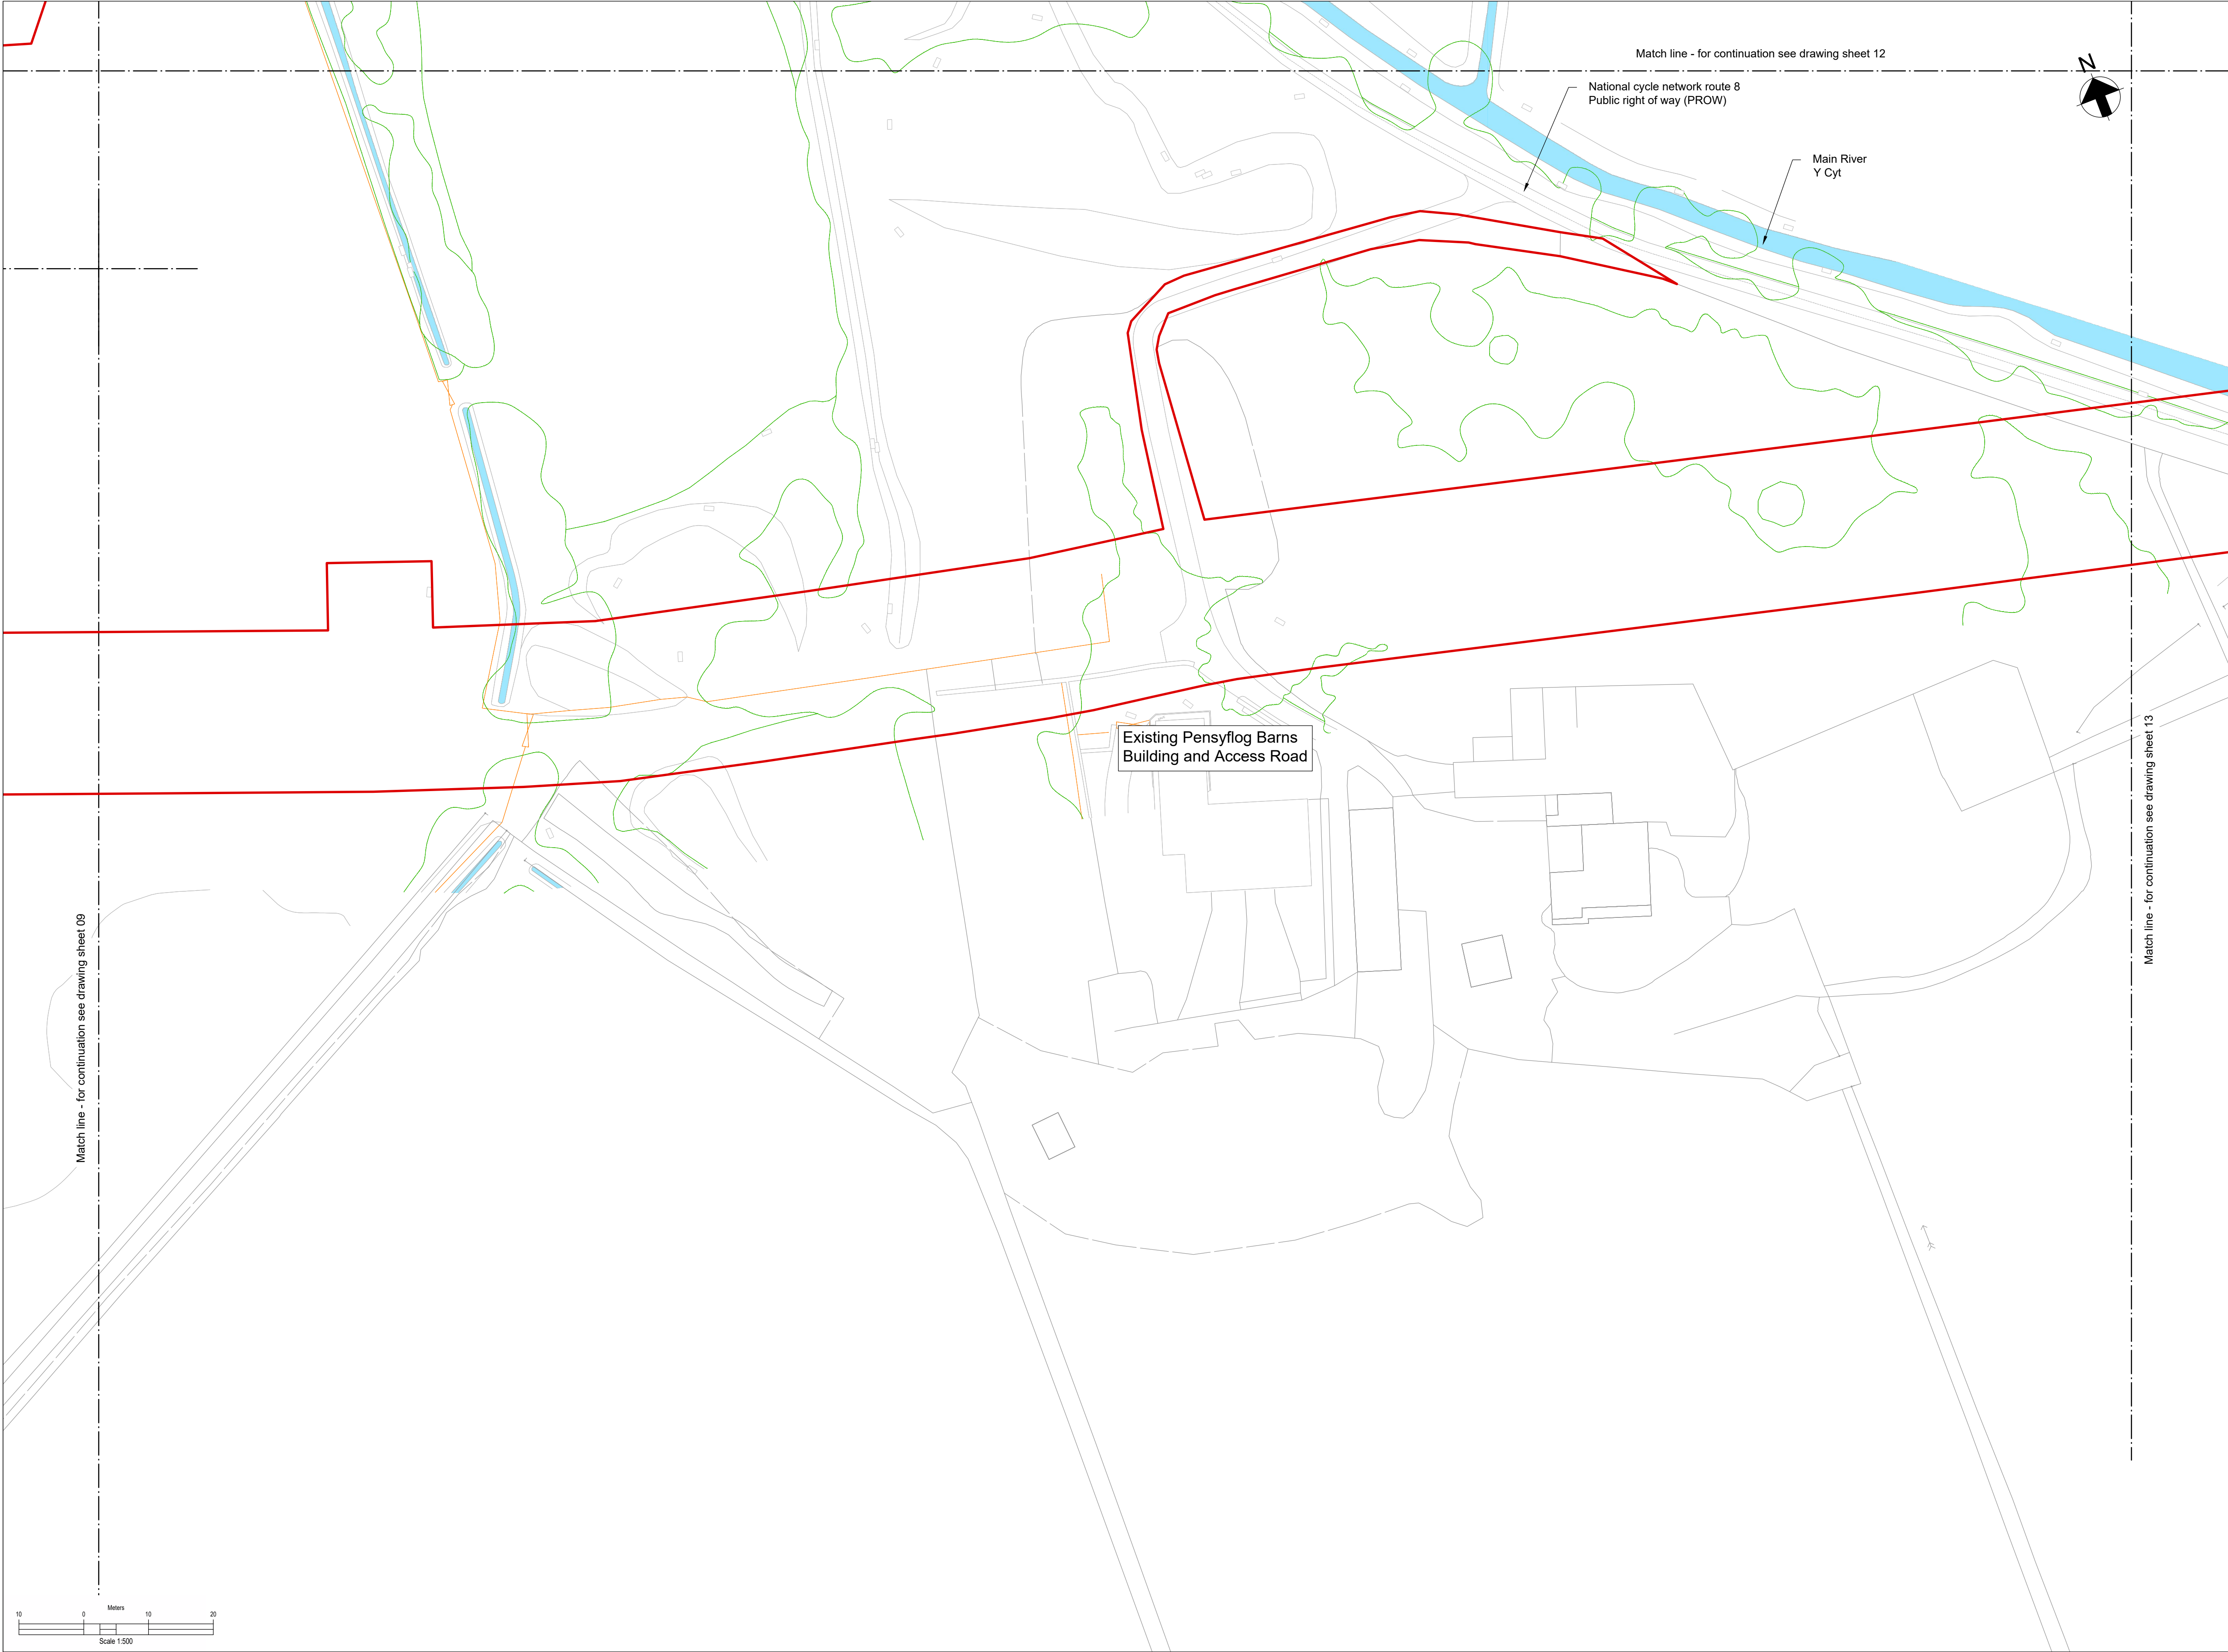
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
Dwg Title:
Planning Drawings
Existing Site Plans
Sheet 10

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NG Investment No:	Sheet No: 10	Total No. of Sheets: 39
NG Dwg No:		Issue: C
Scale: 1:500		



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 3. All dimensions in metres unless otherwise stated.
 4. All levels are in metres Above Ordnance Datum (mAOD)
 5. Existing ground model and utilities information based on survey MGS54157 dated 08/09/23 and undertaken by Murphy Geospatial, with additional data from subsequent GPR.

- Legend:
- Work site boundary
 - Existing Watercourse
 - Existing Fenceline
 - Existing Gate
 - Existing trees and vegetation



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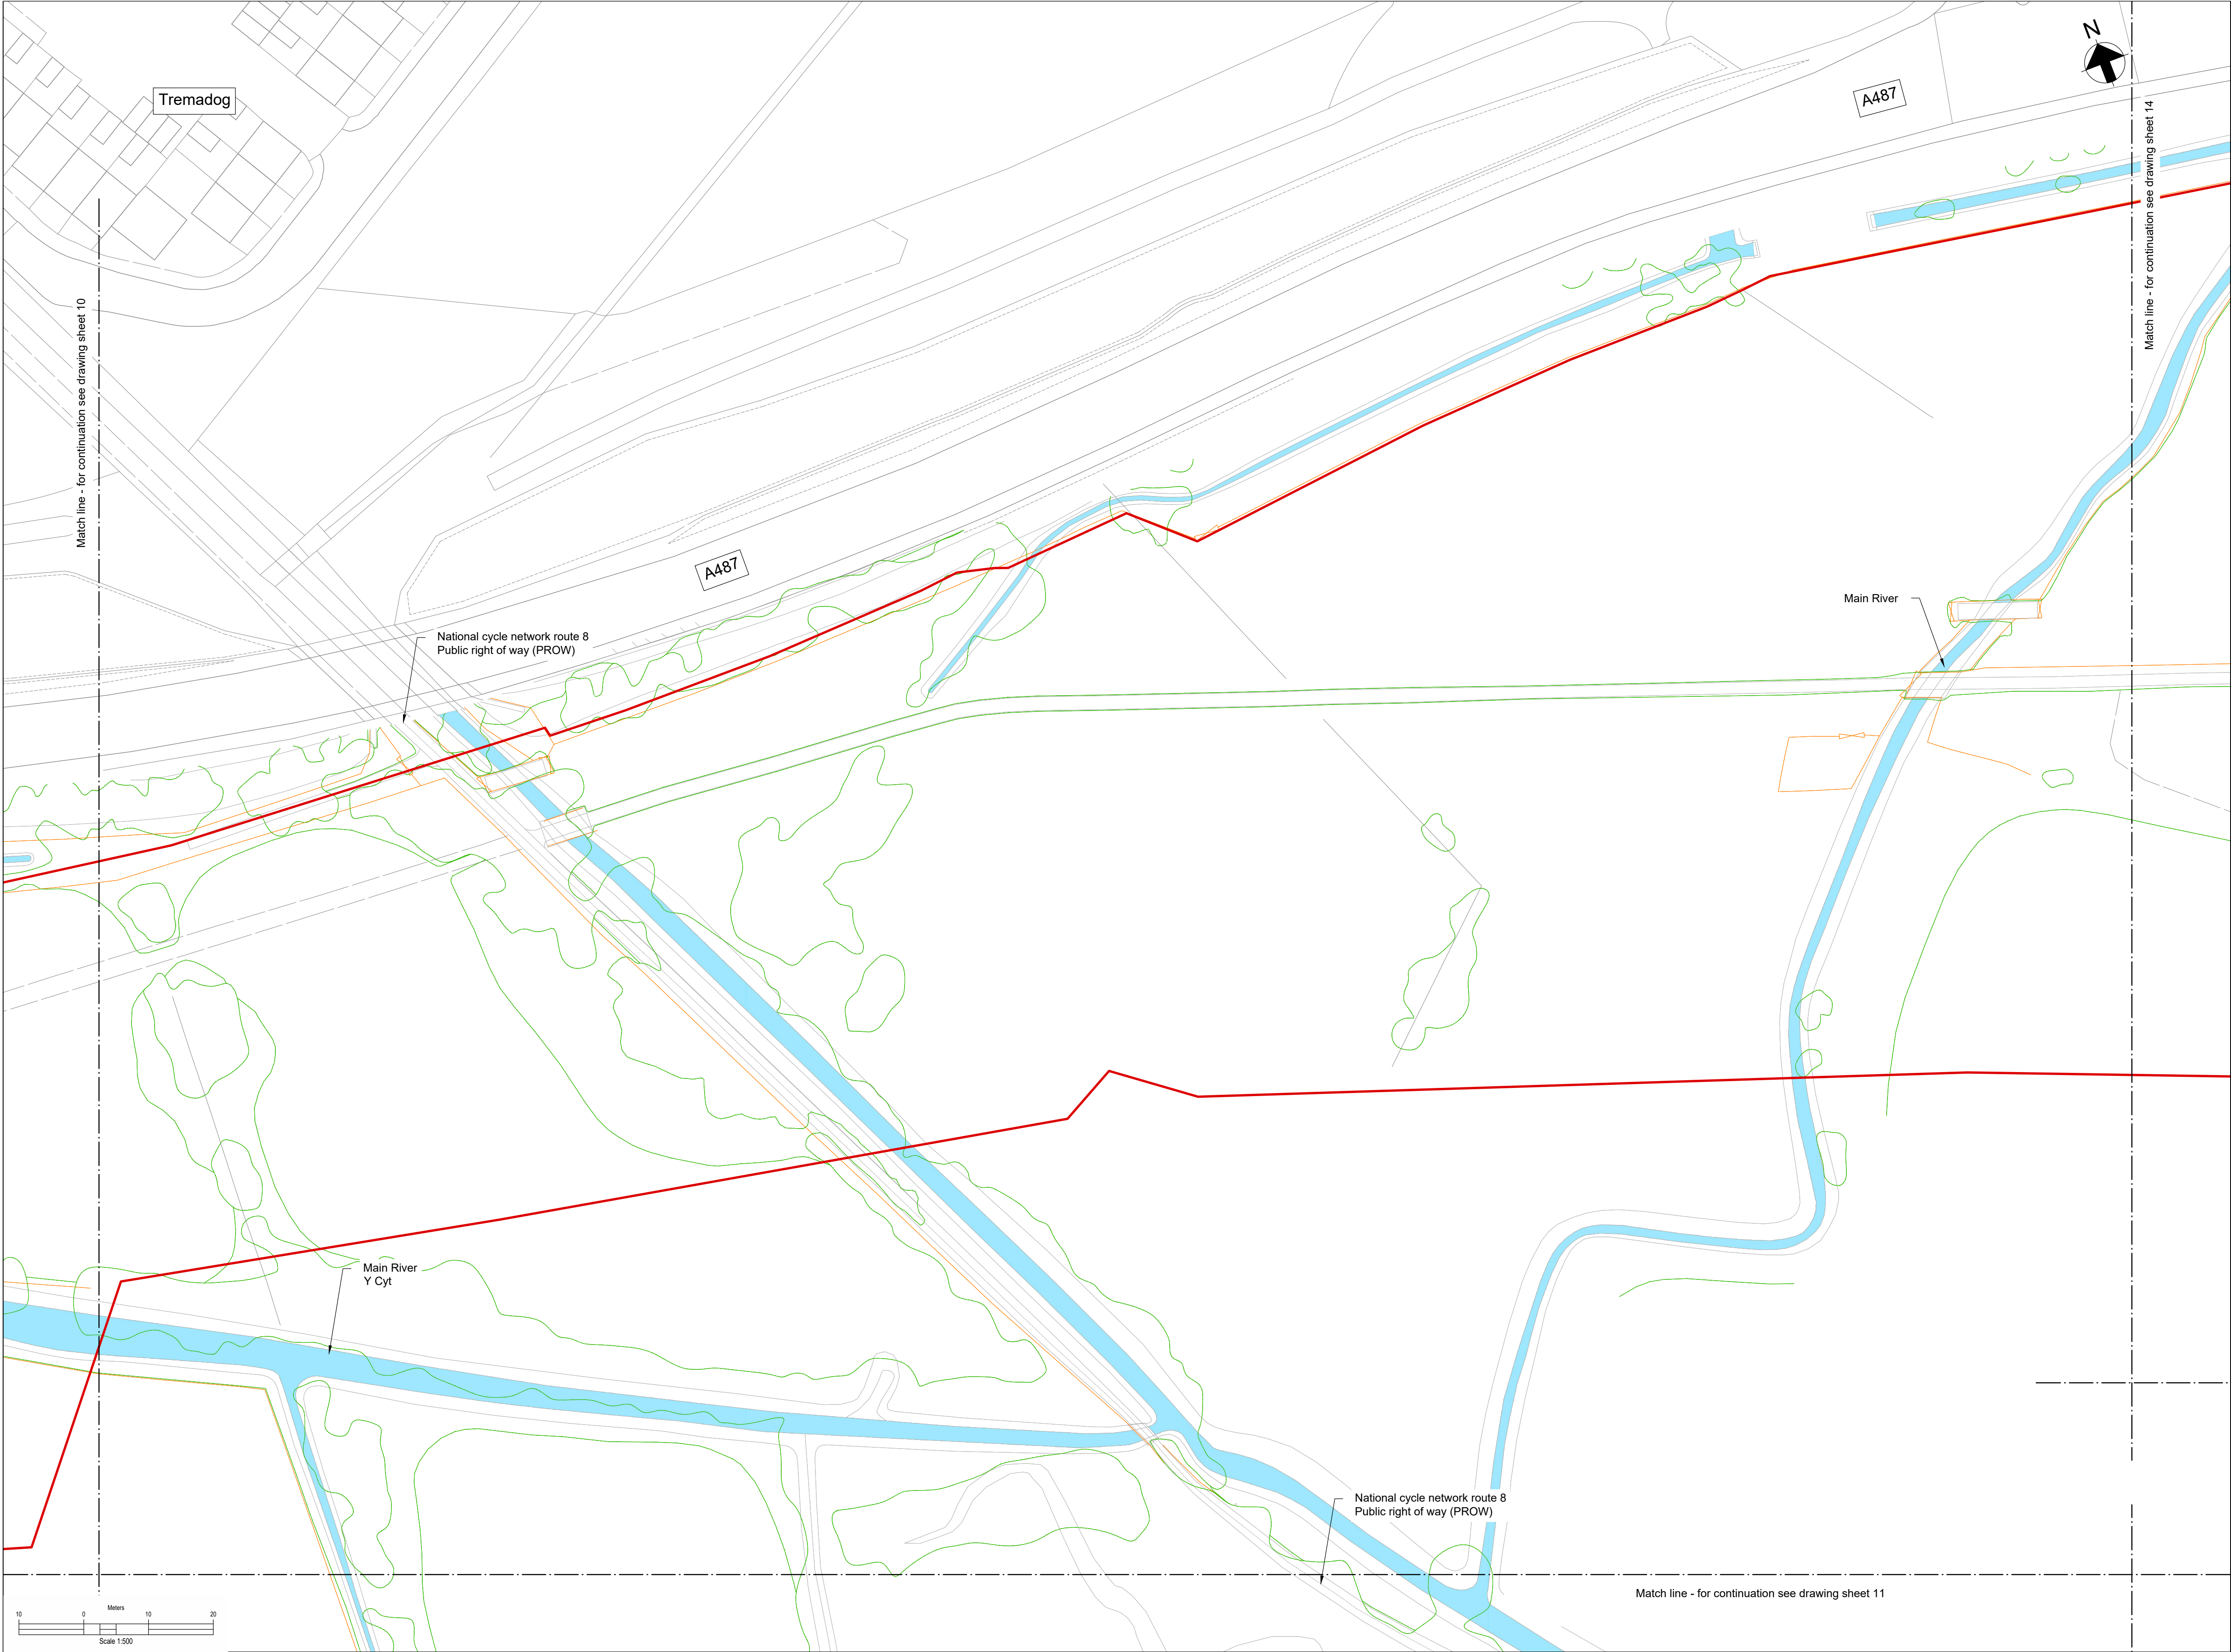
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Dwg Title:
Planning Drawings
Existing Site Plans
Sheet 11

Site: Glaslyn Cable Uprating	A1 100%	CAD
Originator Dwg No: GLAS-ARUP-70-XX-DR-X-9011	Originators Proj.Ref: 295280-00	
NG Investment No:	Sheet No:	Total No. of Sheets
NG Dwg No:	11	39
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Notes:

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- All levels are in meters Above Ordnance Datum (mAOD)
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Legend:


Work site boundary

Existing Watercourse

Existing Fenceline

Existing Gate

Existing trees and vegetation

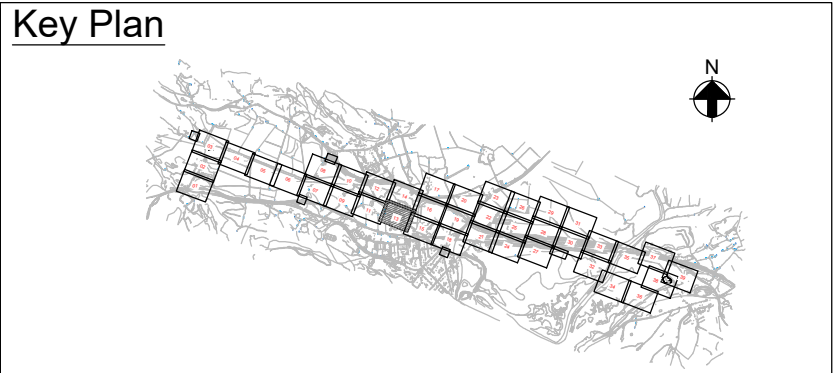

- Notes:**
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 2. Drawing to be printed in colour.
 3. All dimensions in metres unless otherwise stated.
 4. All levels are in metres Above Ordnance Datum (mAOD)
 5. Existing ground model and utilities information based on survey MGS54157 dated 08/09/23 and undertaken by Murphy Geospatial, with additional data from subsequent GPR.

- Legend:**
- Work site boundary
 - Existing Watercourse
 - Existing Fenceline
 - Existing Gate
 - Existing trees and vegetation

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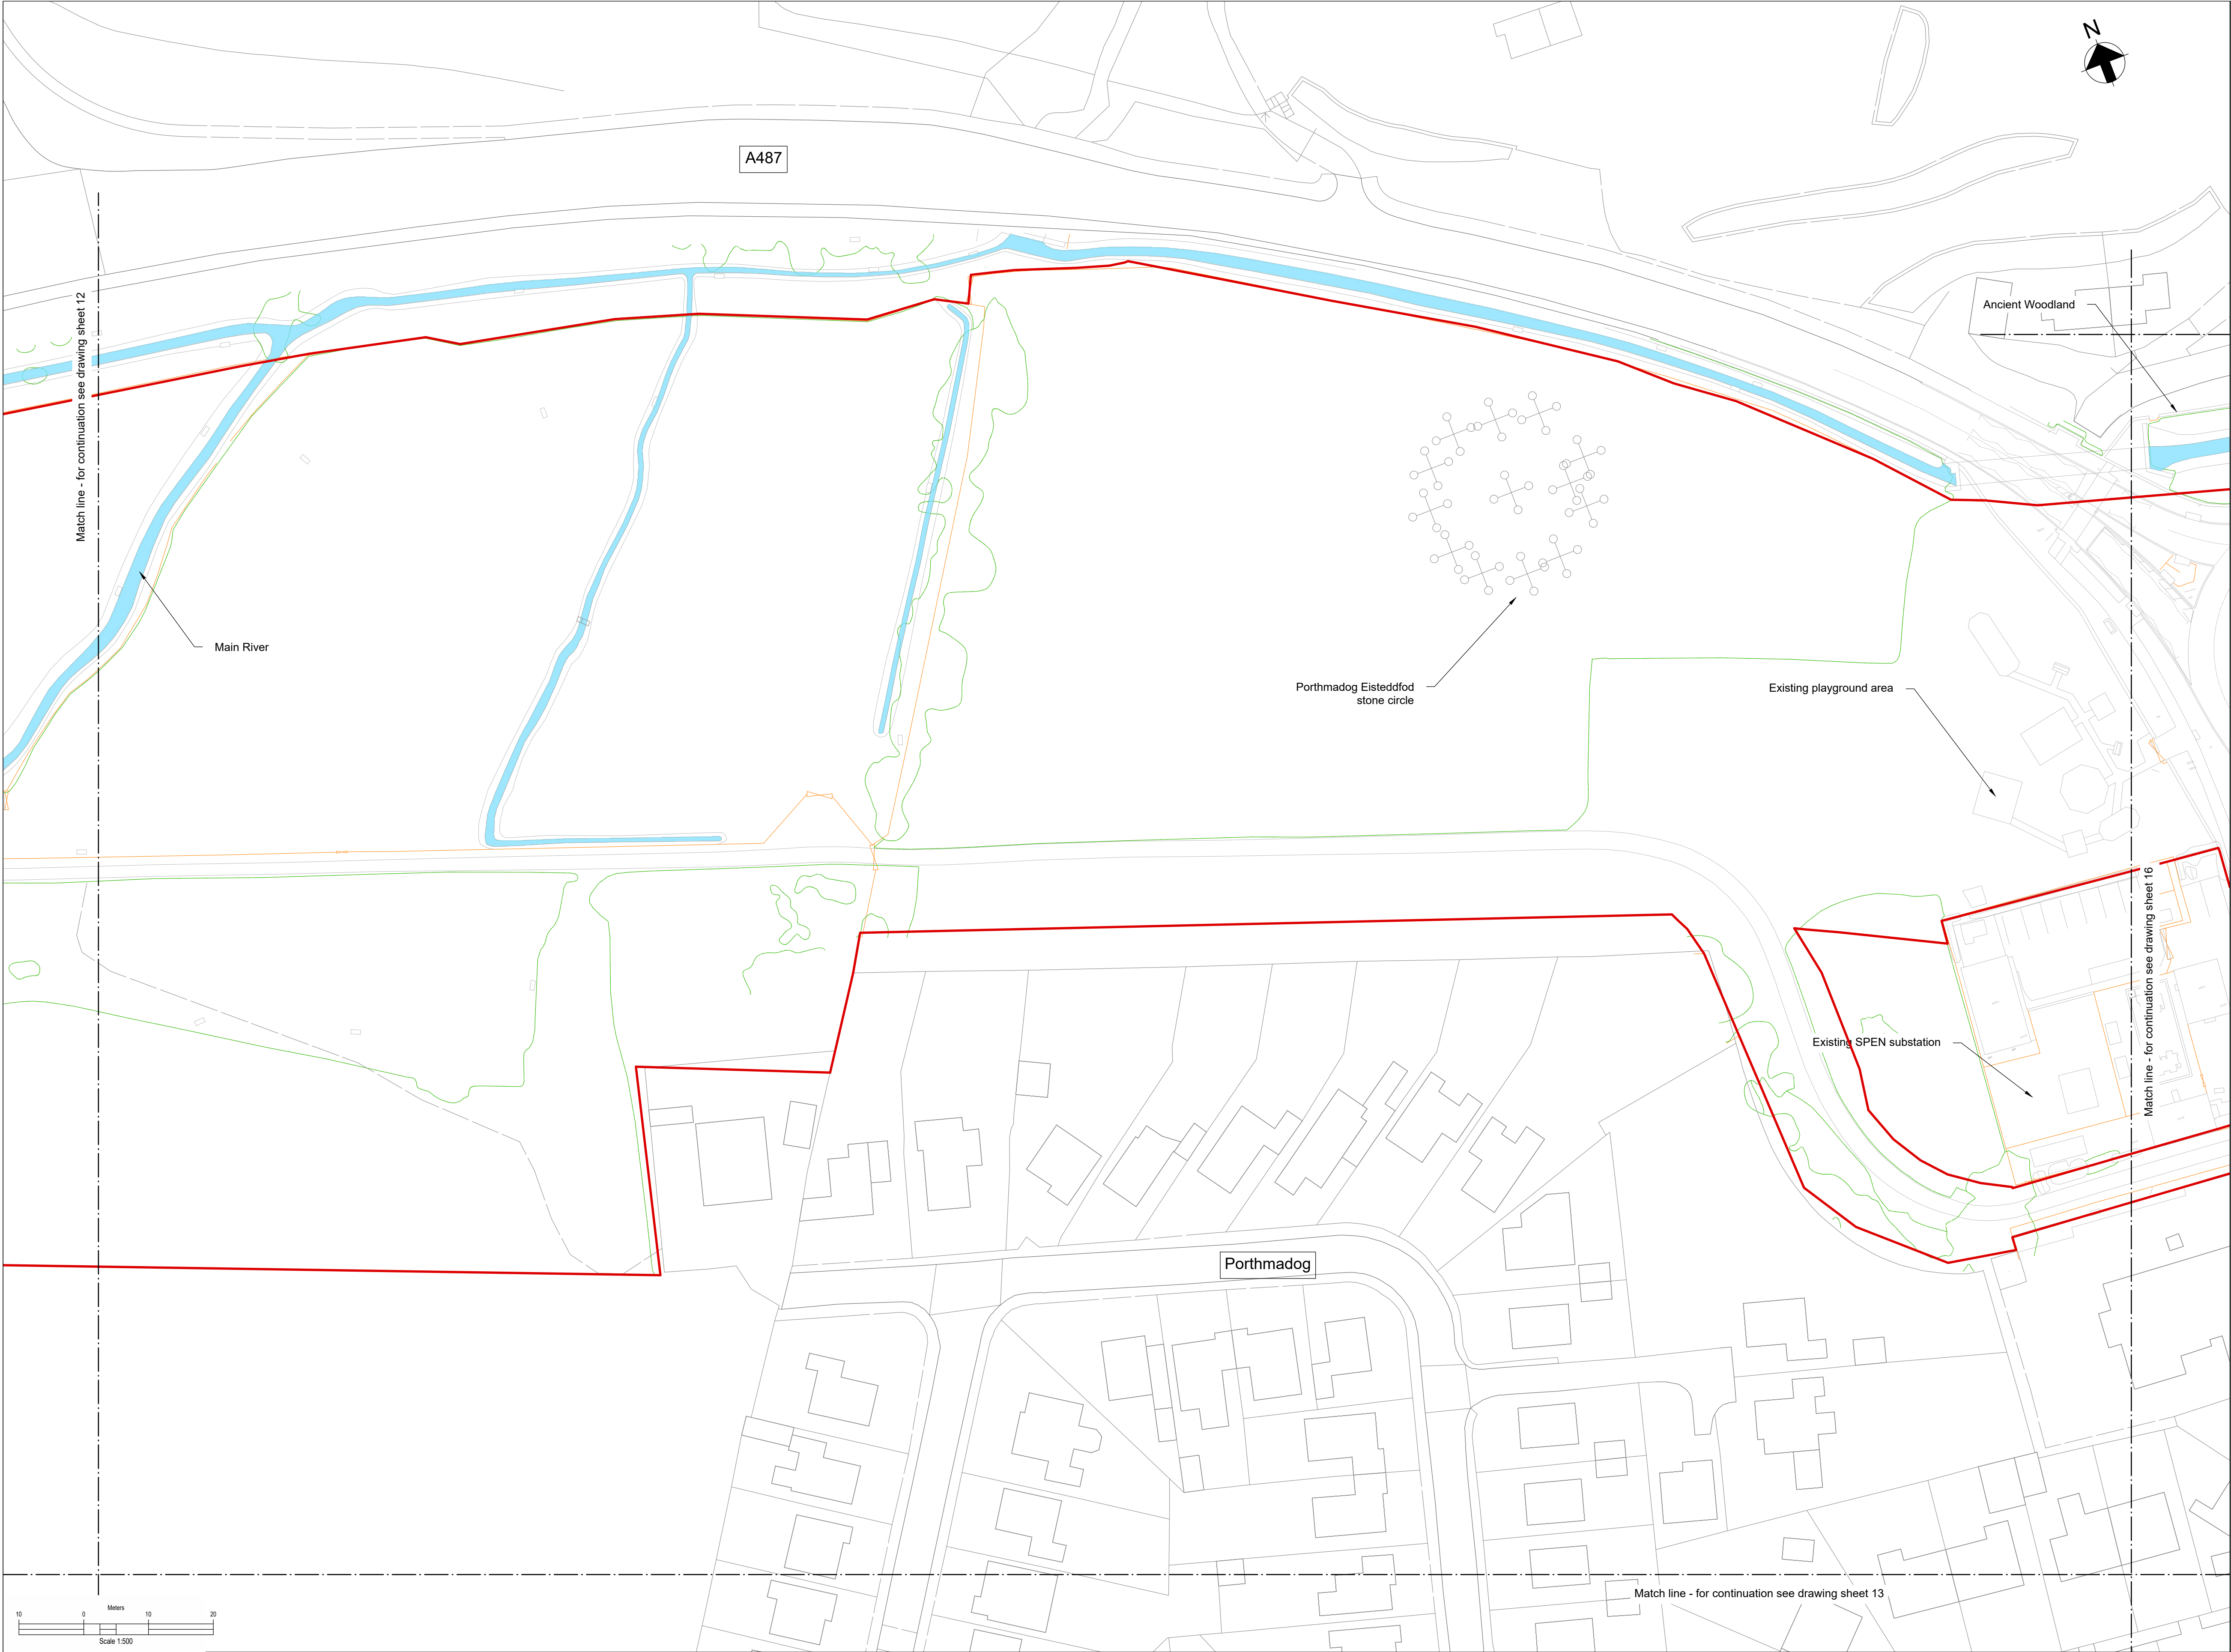
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B	07/08/25	RA	RB	GT	Updated following NG comments
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Dwg Title:
**Planning Drawings
Existing Site Plans
Sheet 13**

Site: Glaslyn Cable Uprating	A1 100%	CAD
Originator: Dwg No: GLAS-ARUP-70-XX-DR-X-9013	Originators Proj.Ref: 295280-00	
NG Investment	Sheet No: 13	Total No. of Sheets: 39
NG Dwg No:		Issue: C
Scale: 1:500		



Key Plan

Notes:

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- Existing ground model and utilities information based on survey MGS54157 dated 08/09/23 and undertaken by Murphy Geospatial, with additional data from subsequent GPR.

Legend:


Work site boundary

Existing Watercourse


Existing Fenceline

Existing Gate

Existing trees and vegetation

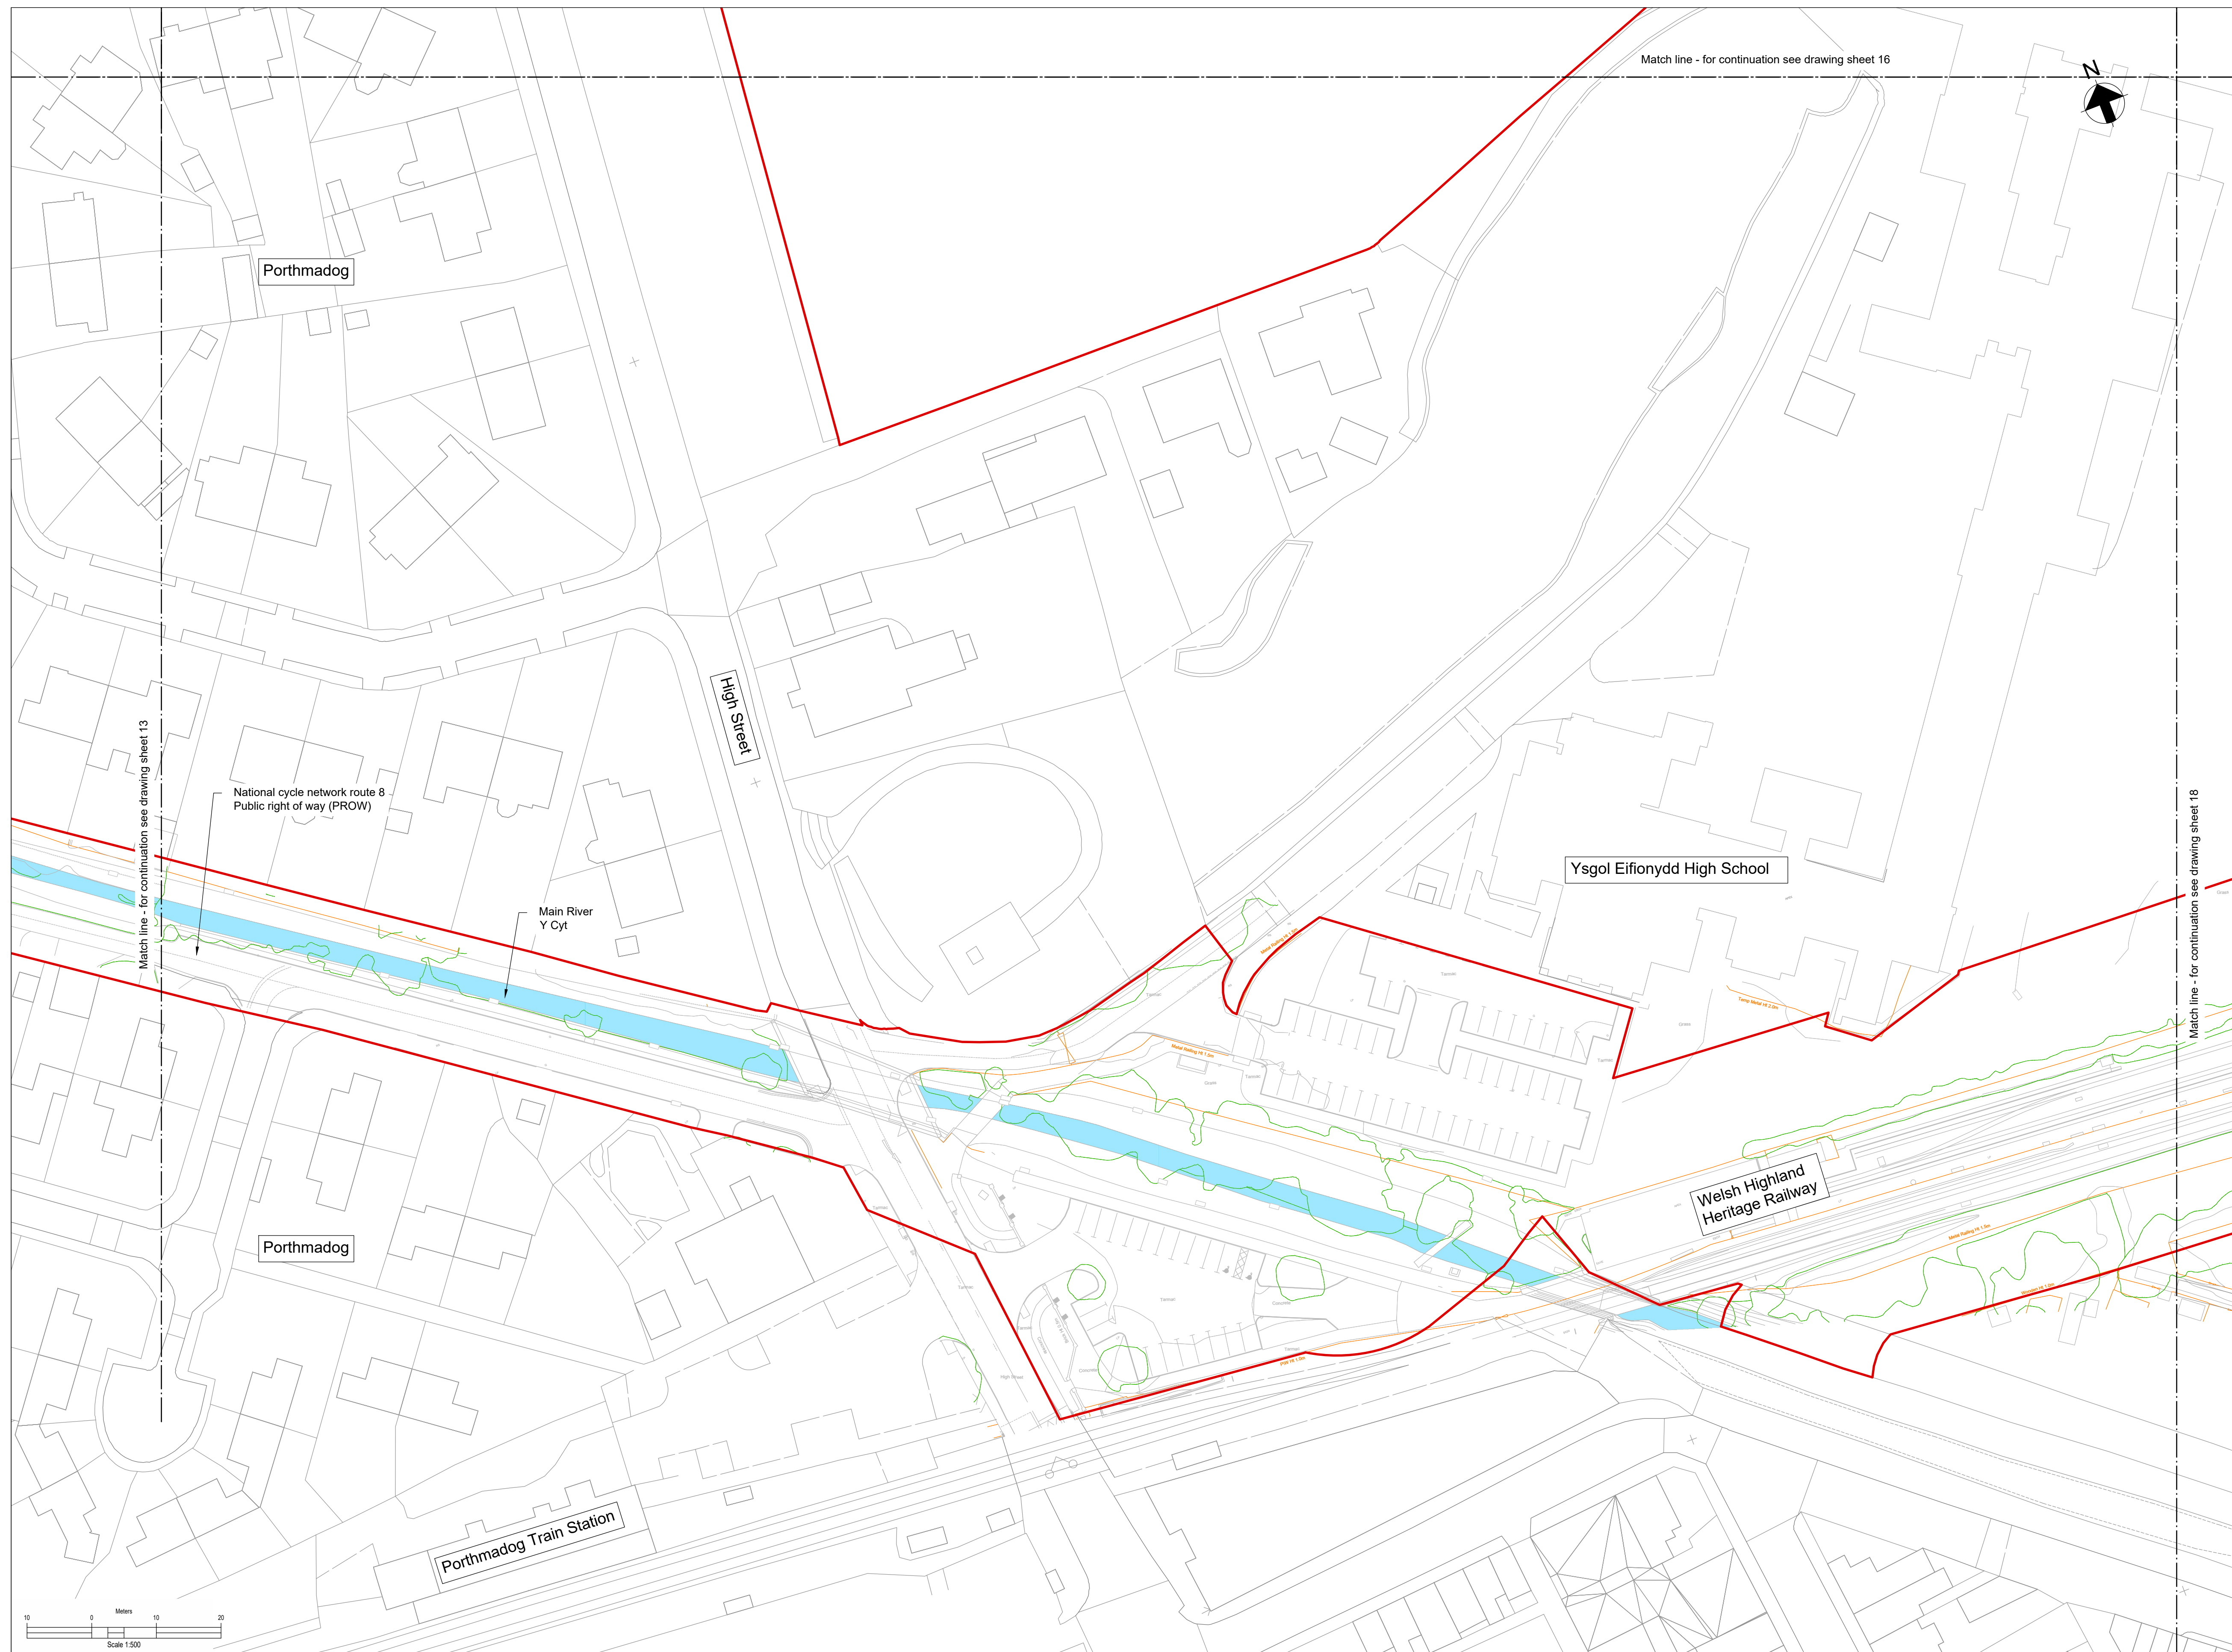

Key Plan

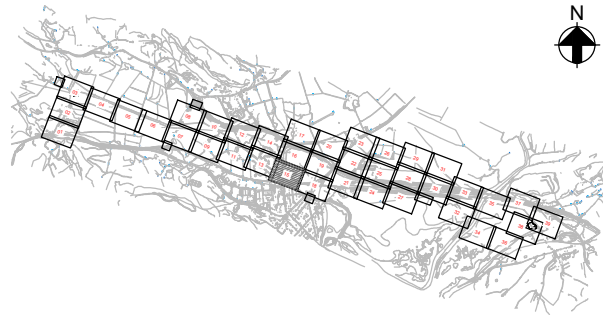

Notes:

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3. All dimensions in metres unless otherwise stated.
4. All levels are in meters Above Ordnance Datum (mAOD)
5. Existing ground model and utilities information based on survey MGS54157 dated 08/09/23 and undertaken by Murphy Geospatial, with additional data from subsequent GPR.

Legend:

Work site boundary



Existing Watercourse



Existing Fenceline



Existing Gate



Existing trees and vegetation

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Dwg Title:
Planning Drawings
Existing Site Plans
Sheet 15

Site: Glaslyn Cable Upgrading

A1 100%	CAD
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Originator	GLAS ARUP 70 YY DB Y 9015
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Originators
Proj. Ref: 295280-00

NG Investment
Mn:

Sheet No:	Total No. of Sheets	Issue:
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Scale: 1:500



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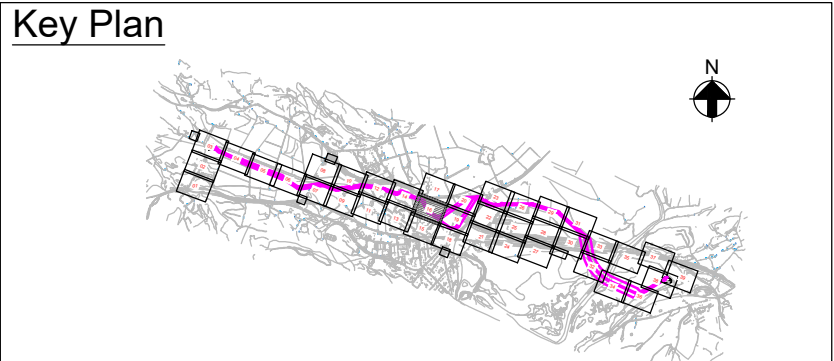
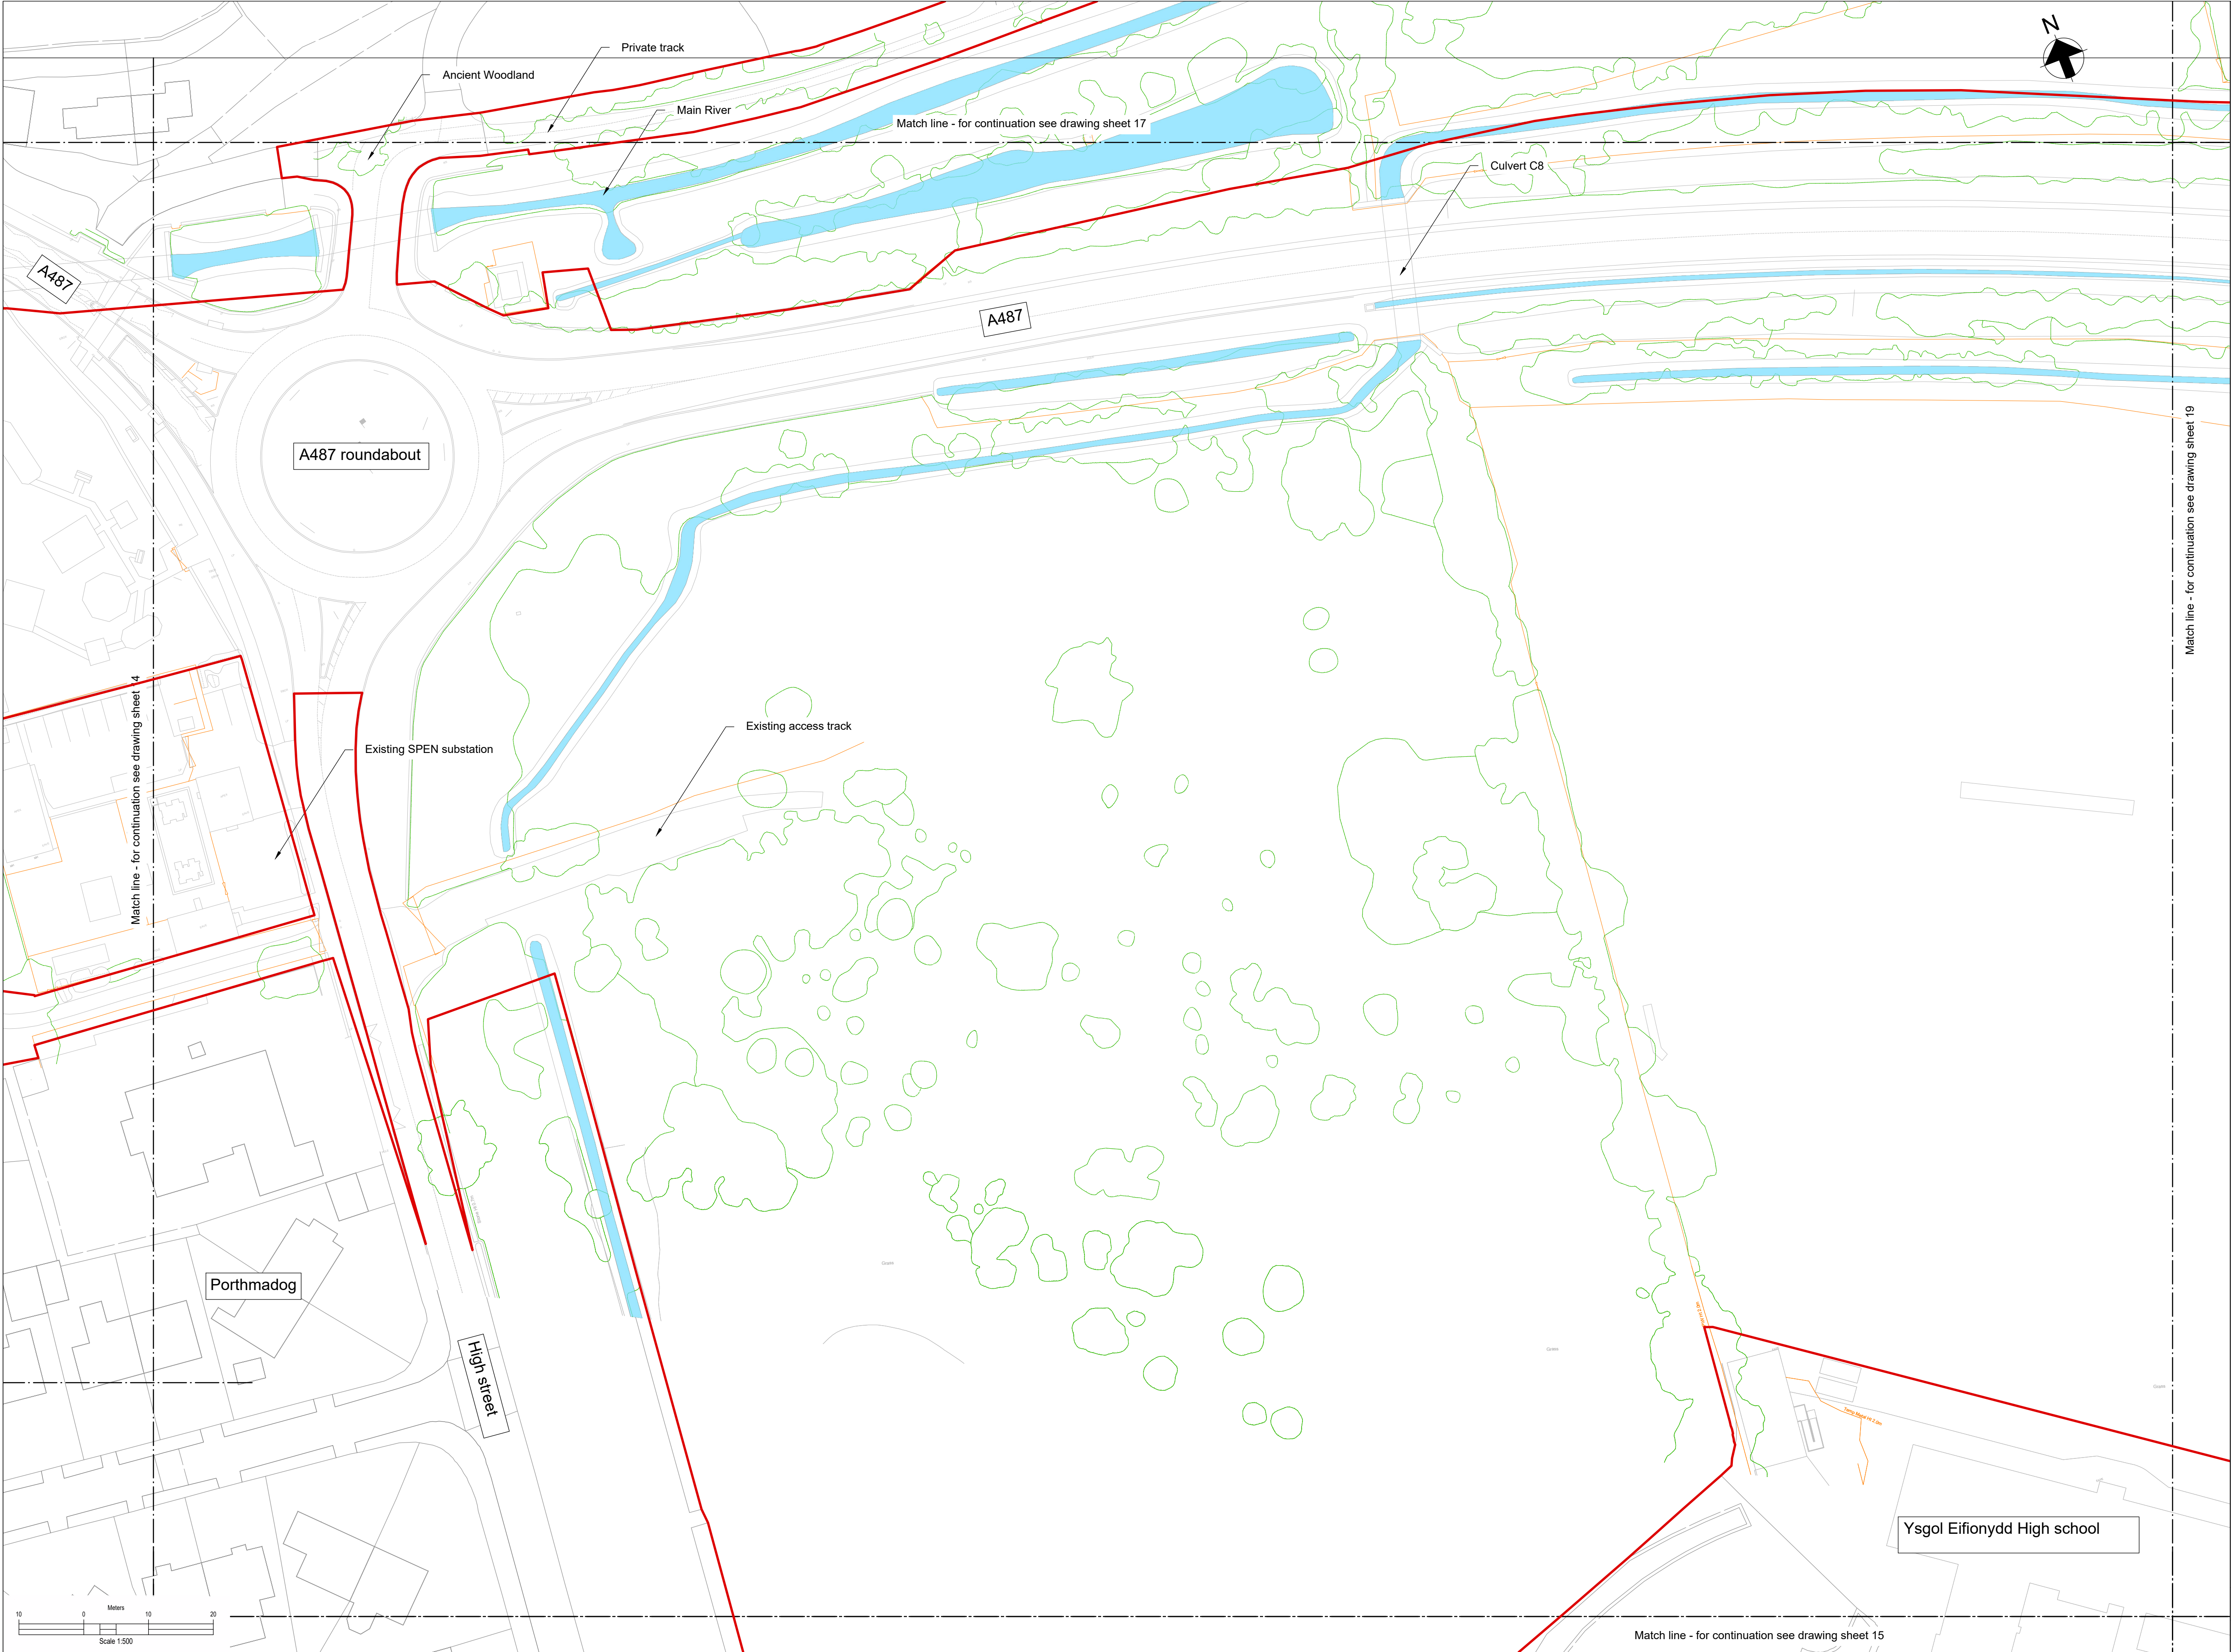
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 4. All levels are in meters Above Ordnance Datum (mAOD)
 5. Existing ground model and utilities information based on survey MGS54157 dated 08/09/23 and undertaken by Murphy Geospatial, with additional data from subsequent GPR.

- Legend:**
- Work site boundary
 - Existing Watercourse
 - Existing Fenceline
 - Existing Gate
 - Existing trees and vegetation

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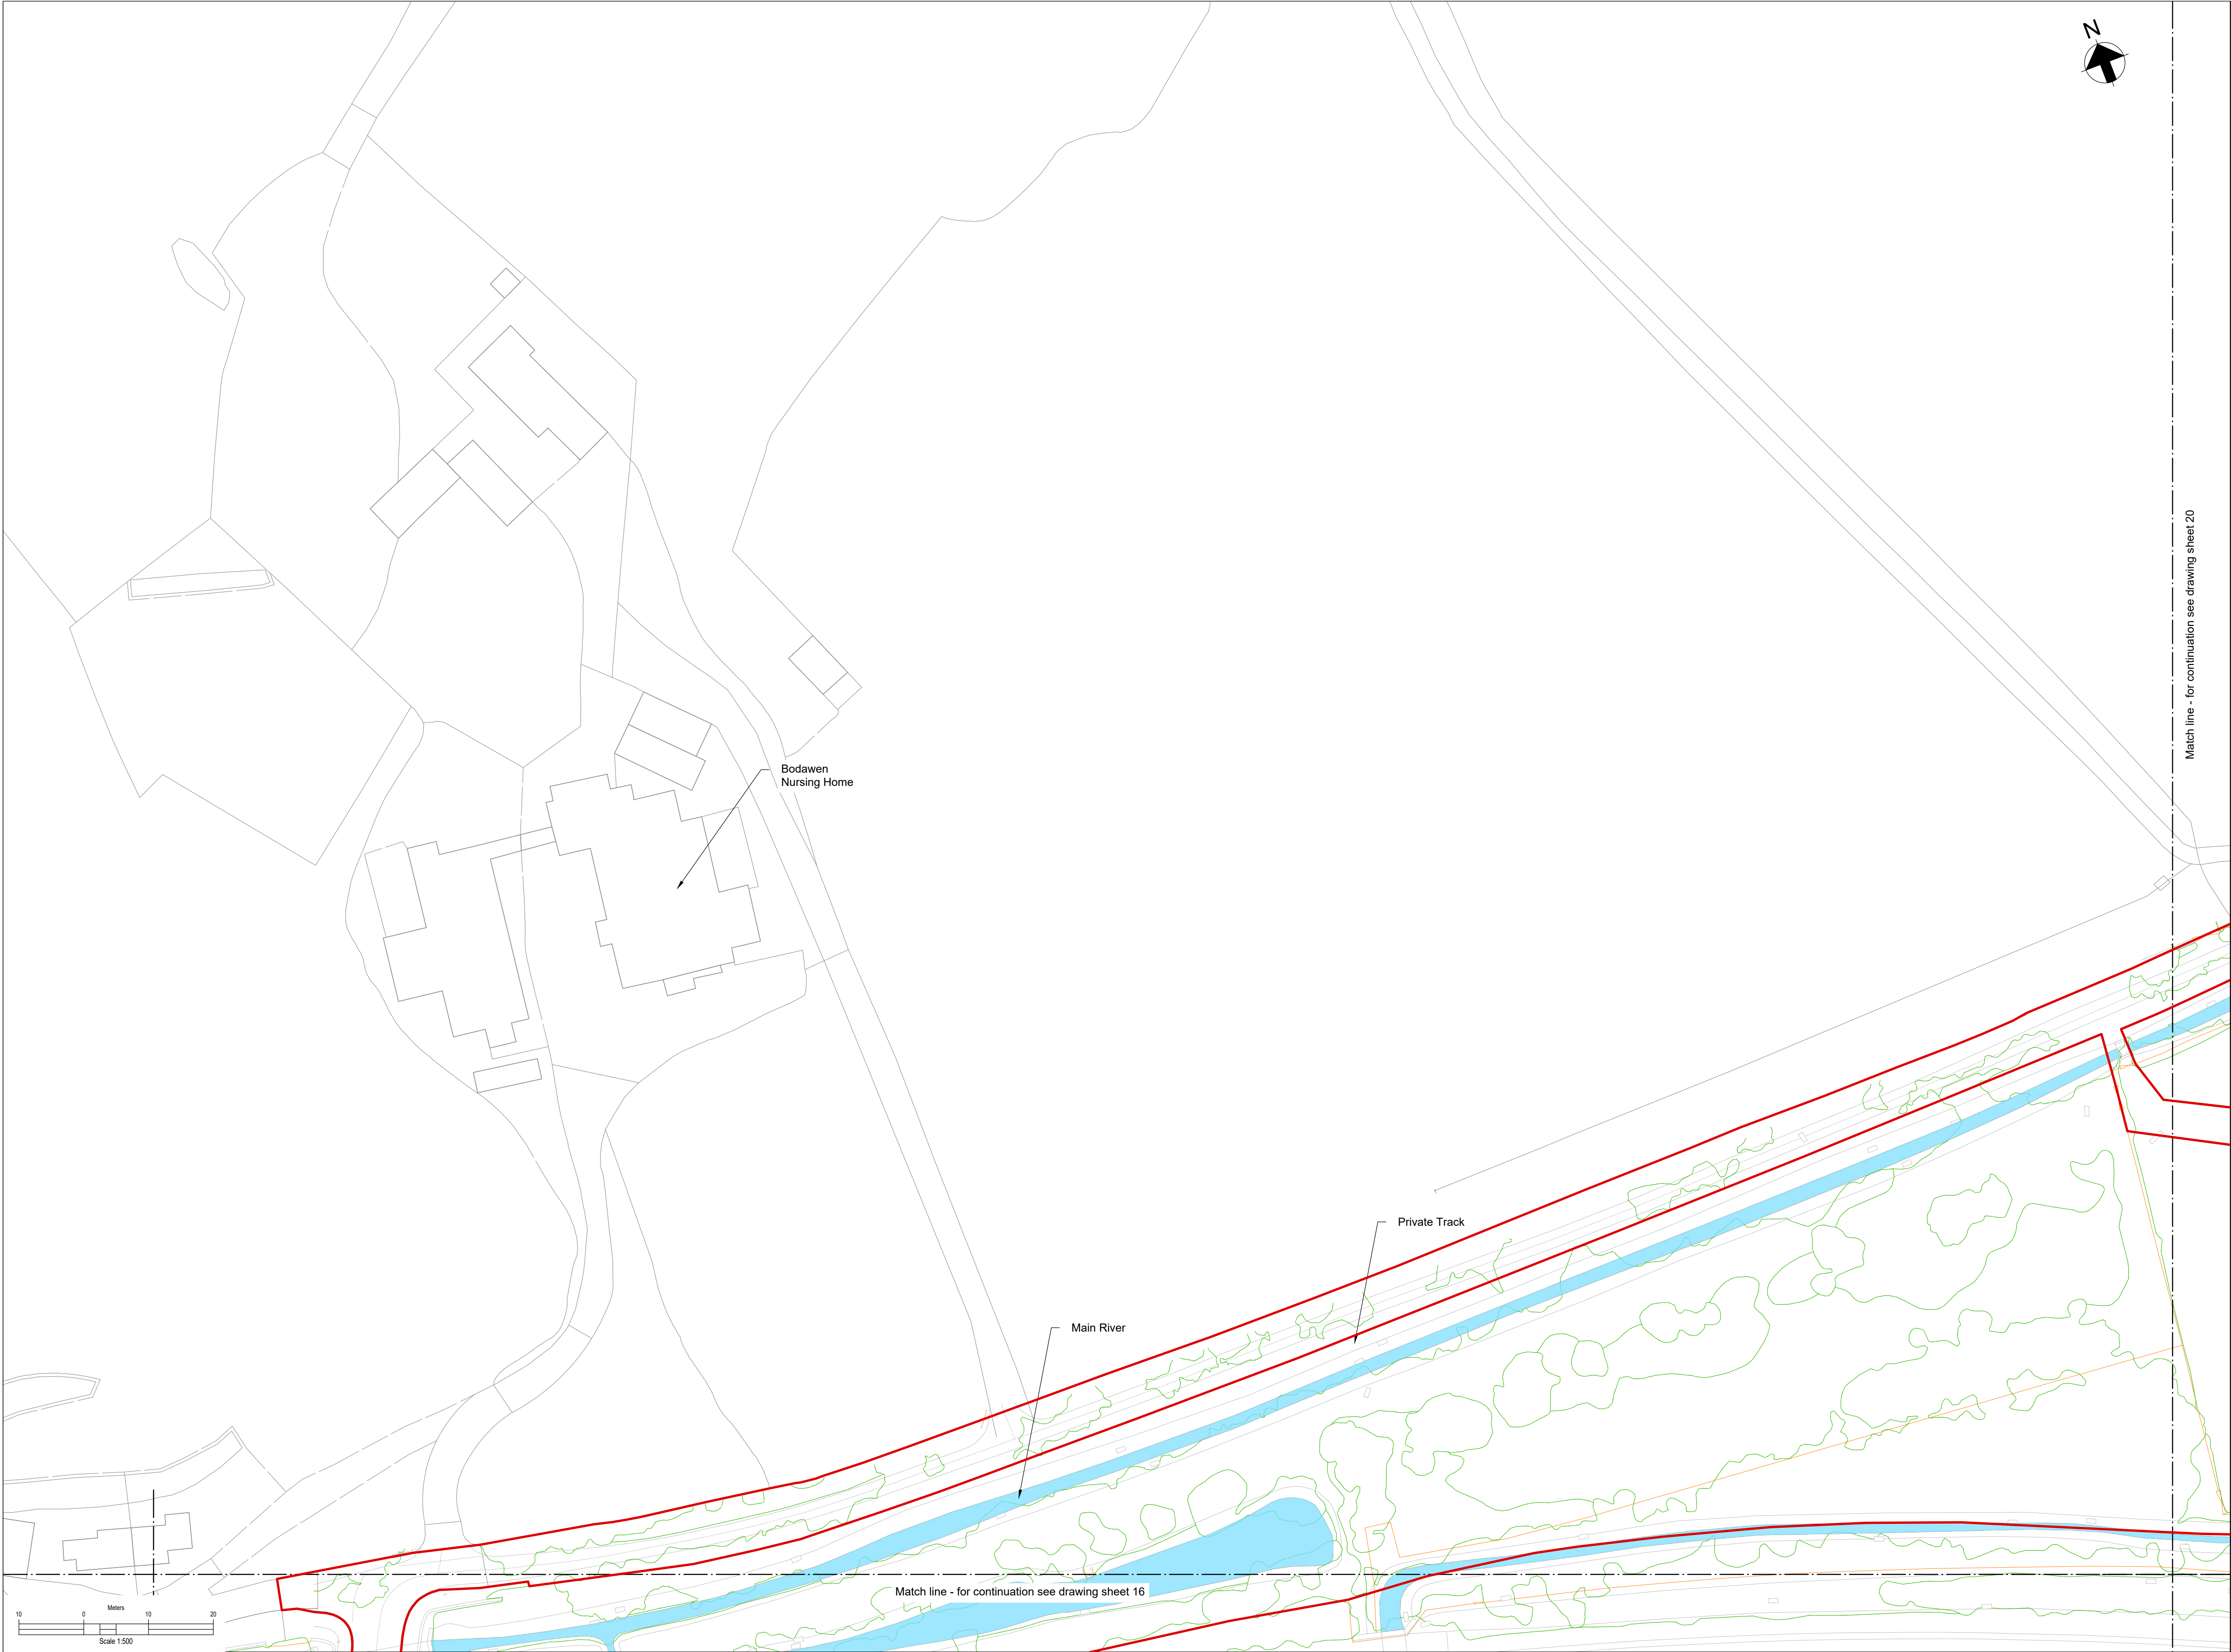
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Dwg Title:
Planning Drawings
Existing Site Plans
Sheet 16

Site: Glaslyn Cable Uprating	A1 100%	CAD
Originator: Dwg No: GLAS-ARUP-70-XX-DR-X-9016	Originators Proj.Ref: 295280-00	
NG Investment No:	Sheet No: 16	Total No. of Sheets: 39
NG Dwg No:		Issue: C
Scale: 1:500		



Key Plan

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Legend:


Work site boundary

Existing Watercourse

Existing Fenceline

Existing Gate

Existing trees and vegetation

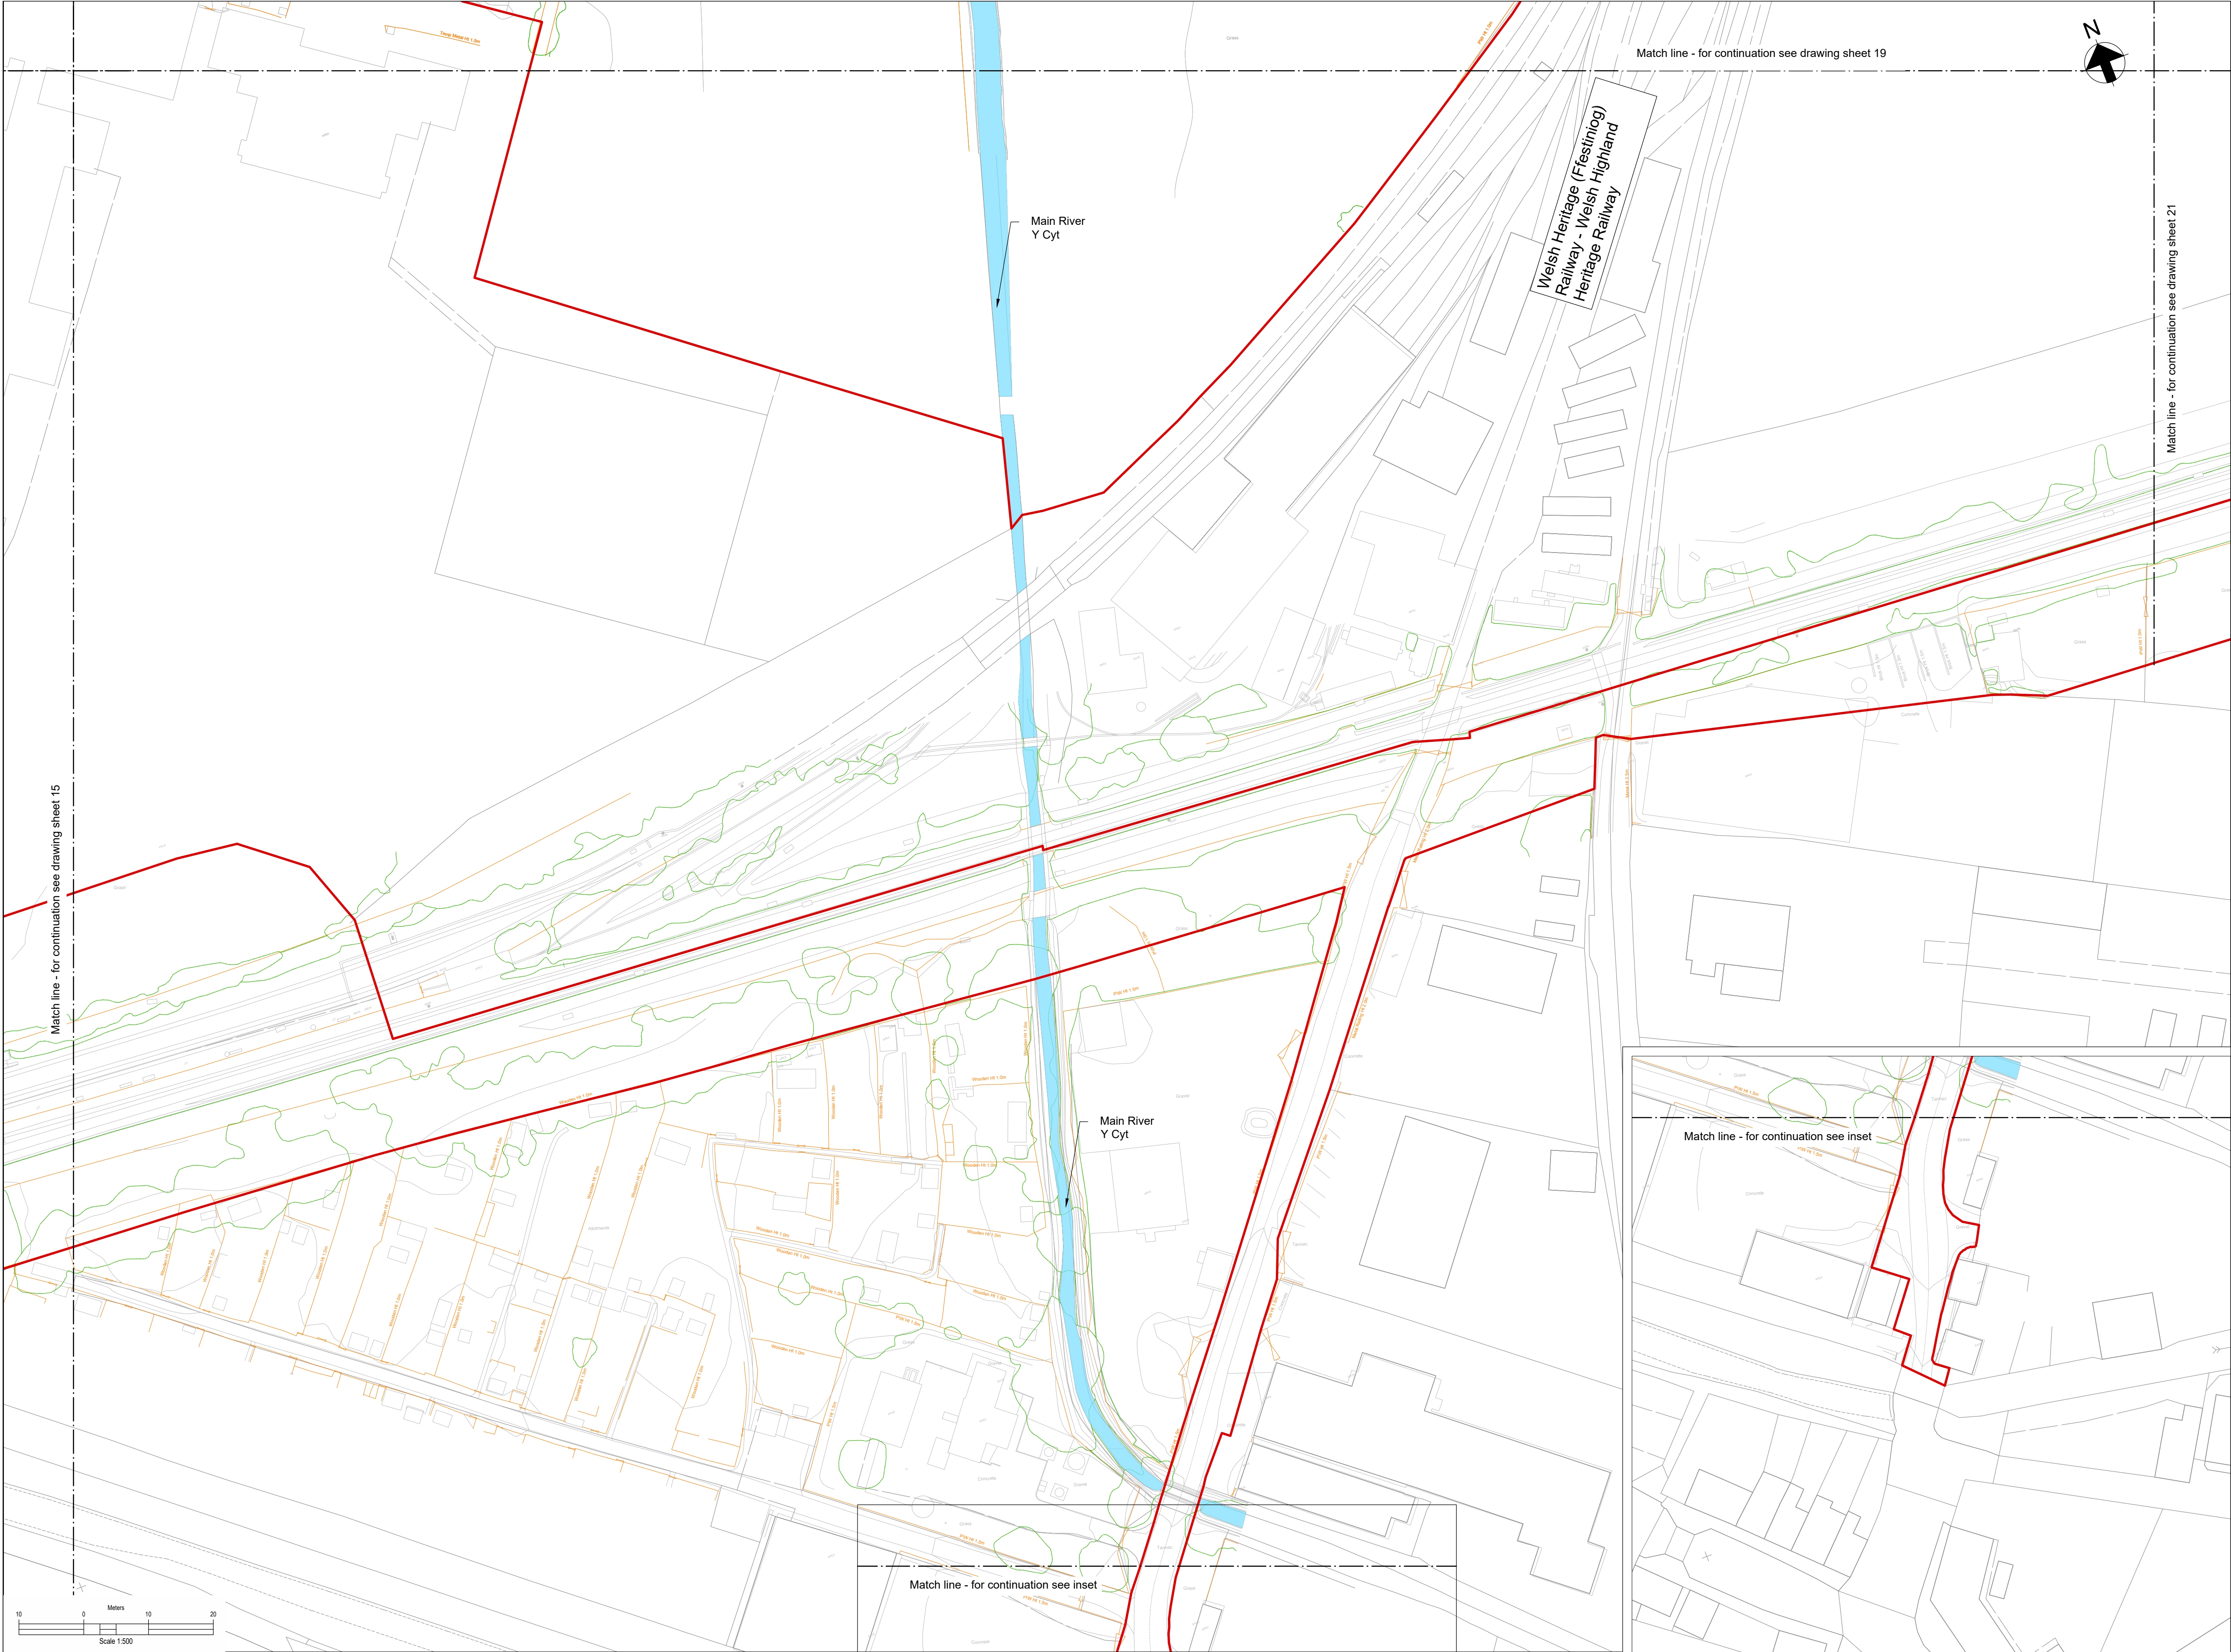

Key Plan

Notes:

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2. Drawing to be printed in colour.
3. All dimensions in metres unless otherwise stated.
4. All levels are in meters Above Ordnance Datum (mAOD)
5. Existing ground model and utilities information based on survey MGS54157 dated 08/09/23 and undertaken by Murphy Geospatial, with additional data from subsequent GPR.

Legend:

Work site boundary

Existing Watercourse

Existing Fenceline

Existing Gate


Existing trees and vegetation

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Dwg Title:
**Planning Drawings
Existing Site Plans
Sheet 18**

Site: Glaslyn Cable Uprating		A1 100%	CAD
Originator Dwg No: GLAS-ARUP-70-XX-DR-X-9018		Originators Proj.Ref: 295280-00	
NG Investment No:		Sheet No:	Total No. of Sheets
NG Dwg No:		18	39
Scale: 1:500		Issue: C	





Key Plan

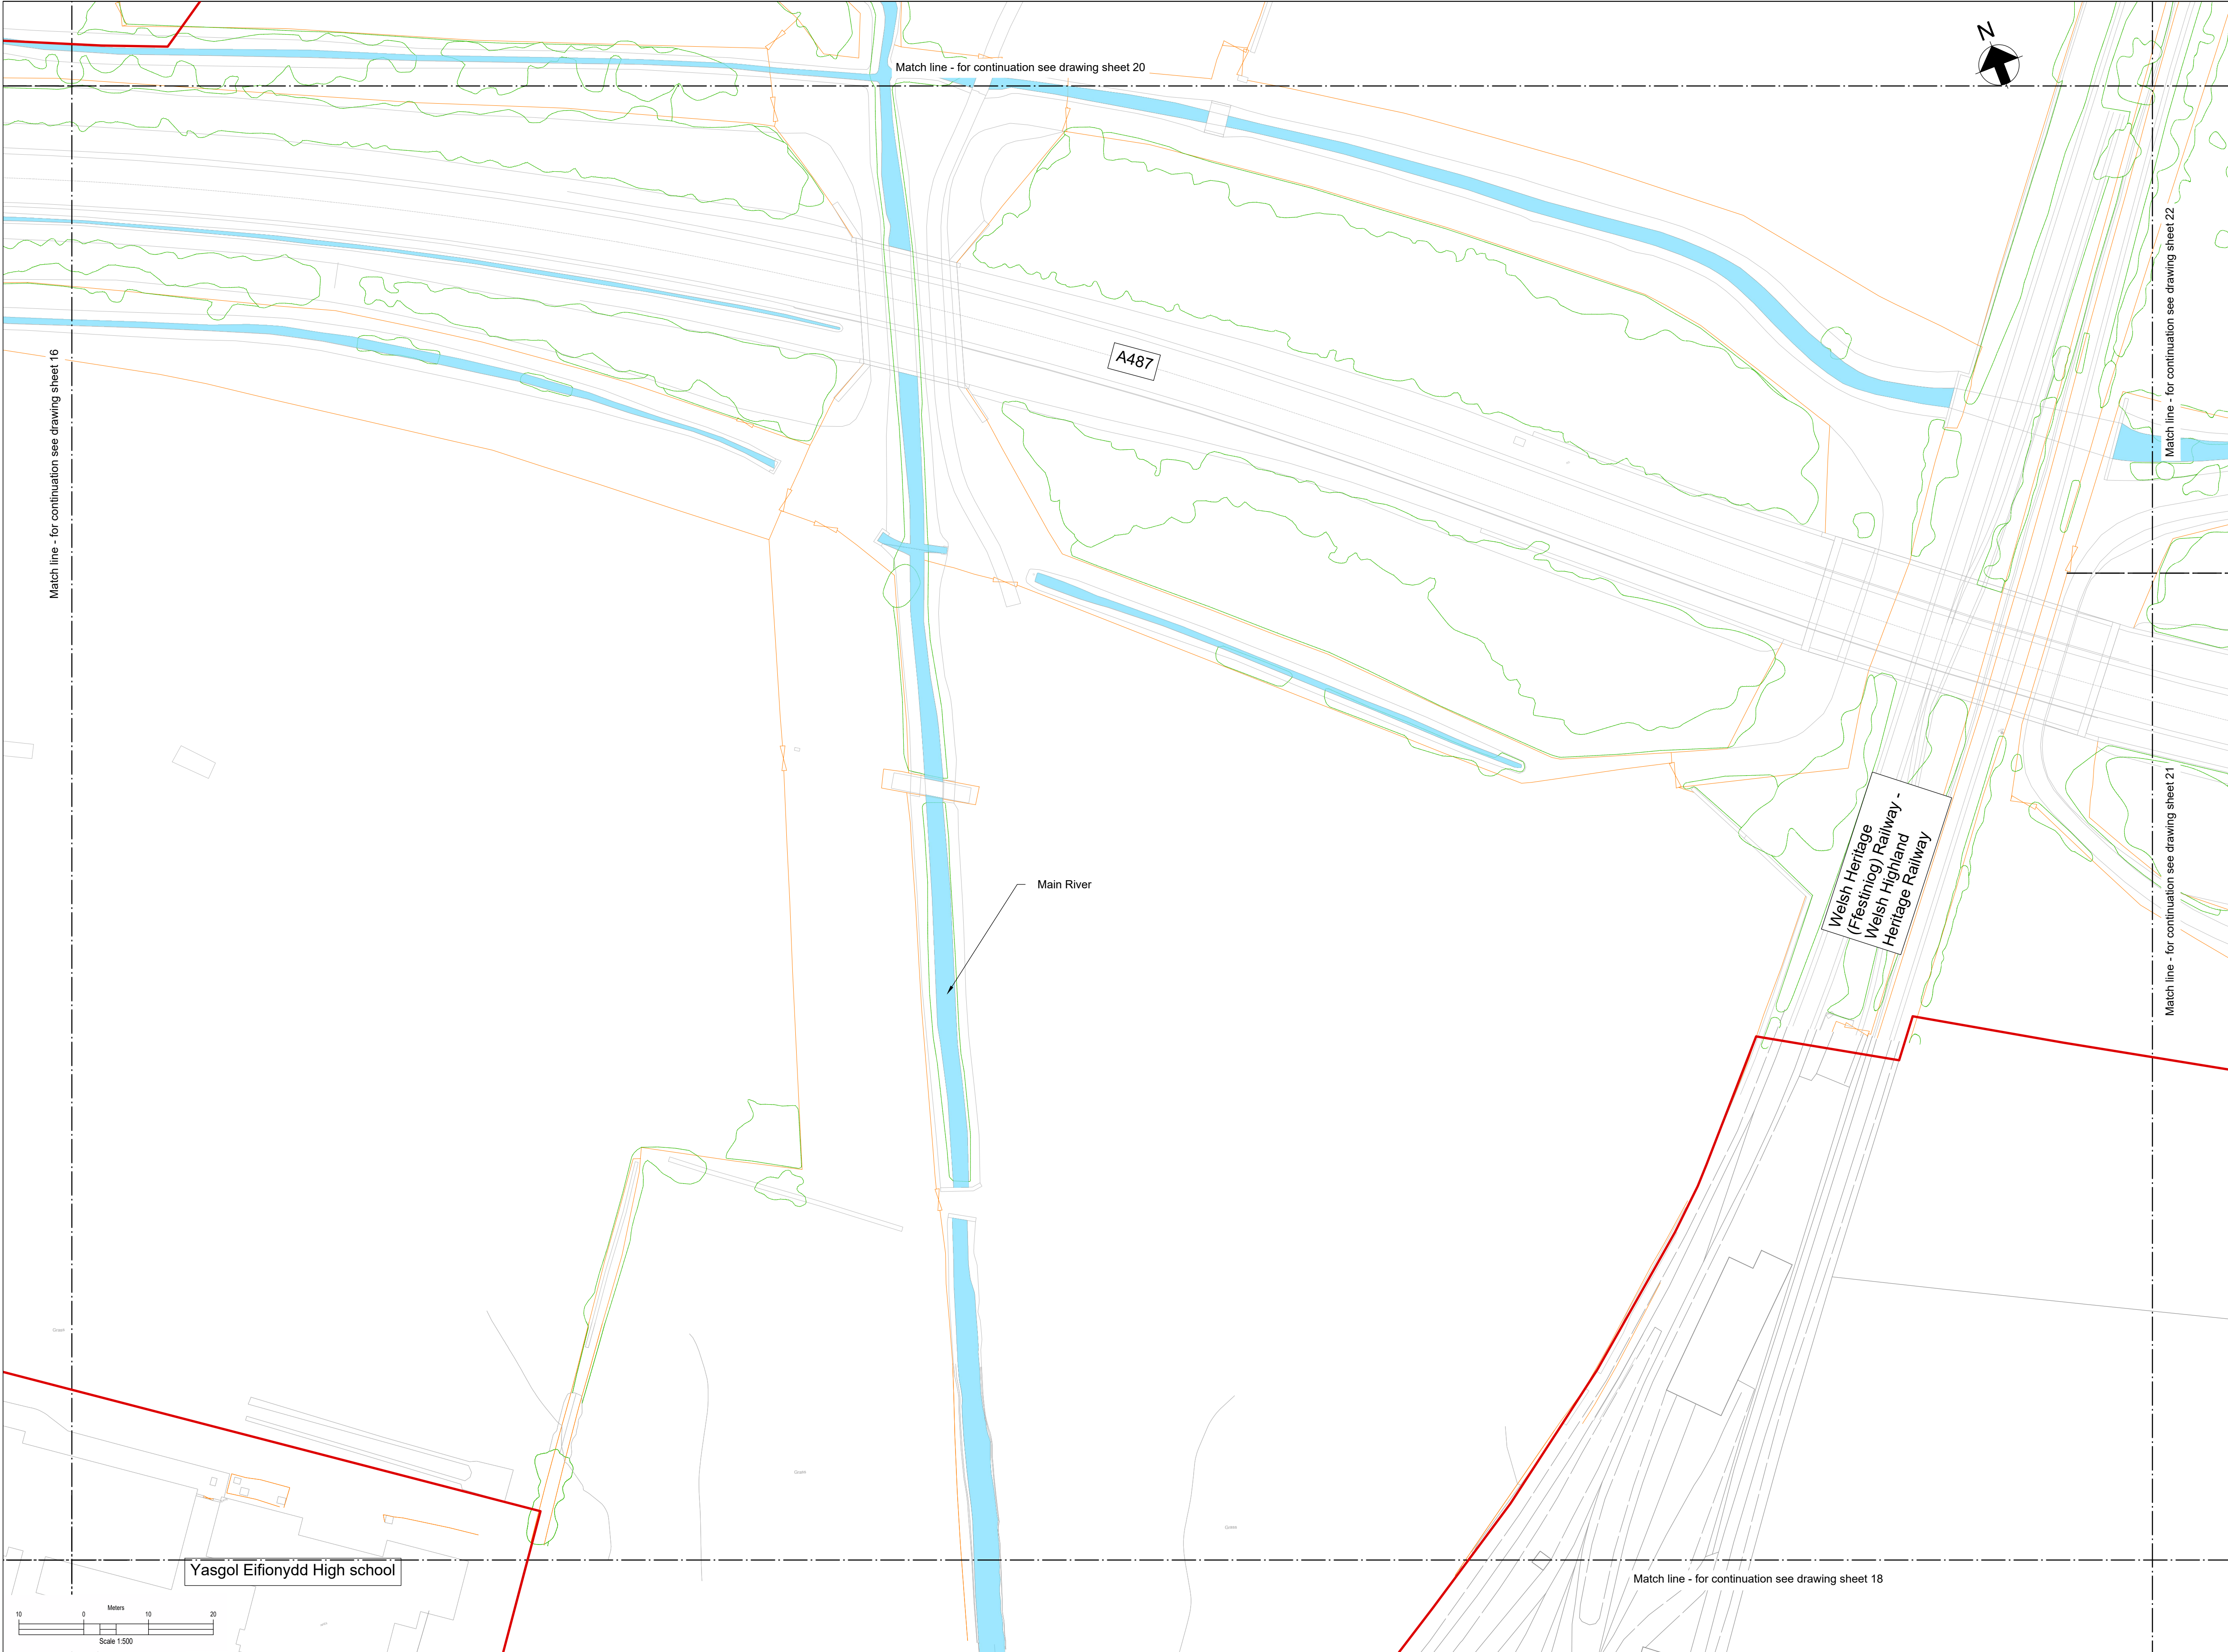Notes:

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- All levels are in meters Above Ordnance Datum (mAOD)
- Existing ground model and utilities information based on survey MGS54157 dated 08/09/23 and undertaken by Murphy Geospatial, with additional data from subsequent GPR.

Legend:

- Work site boundary
- Existing Watercourse
- Existing Fenceline
- Existing Gate
- Existing trees and vegetation

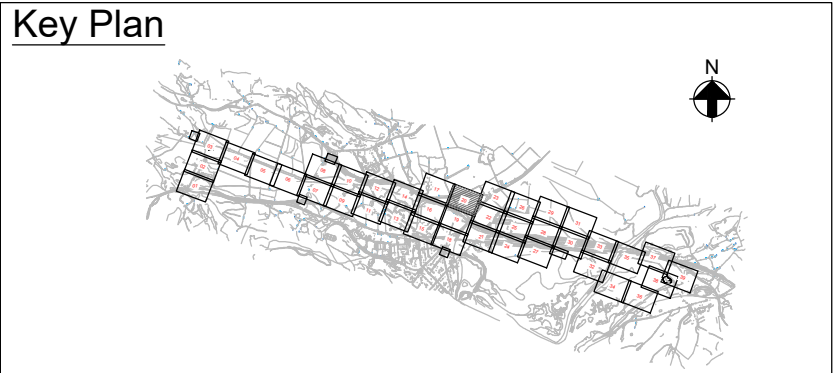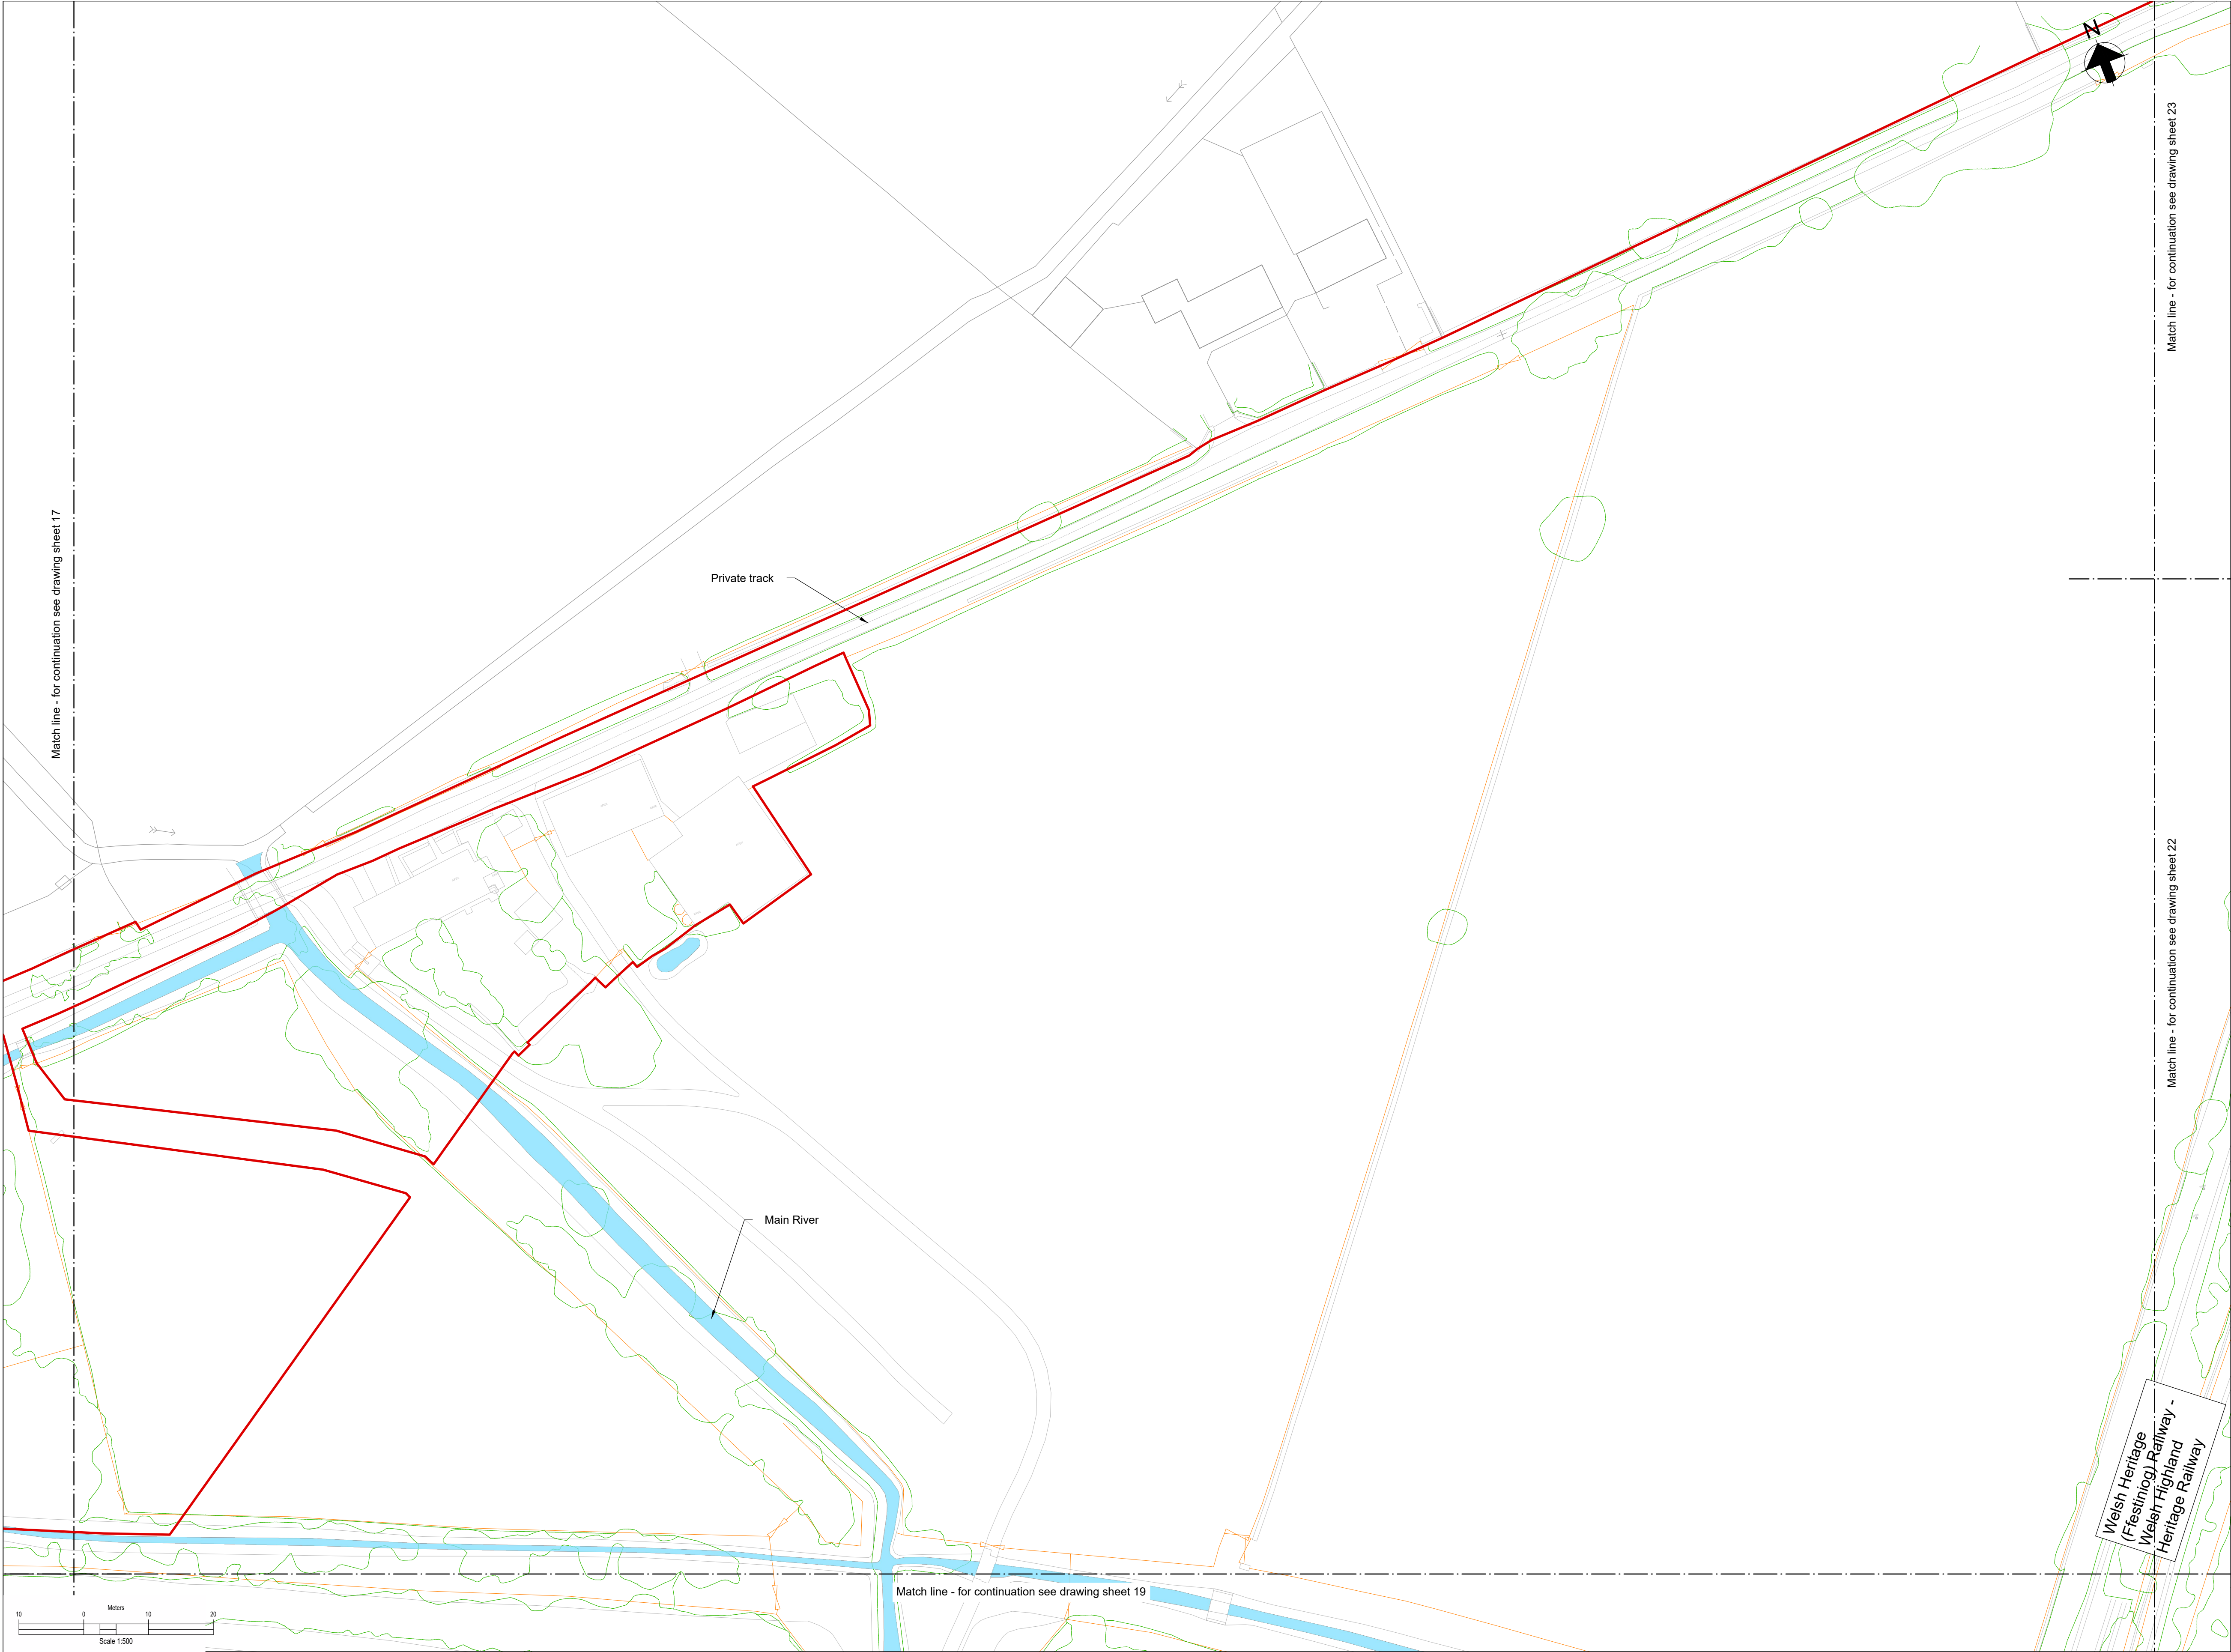

- Notes:**
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 - Existing ground model and utilities information based on survey MGS54157 dated 08/09/23 and undertaken by Murphy Geospatial, with additional data from subsequent GPR.

- Legend:**
- Work site boundary
 - Existing Watercourse
 - Existing Fenceline
 - Existing Gate
 - Existing trees and vegetation

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Dwg Title:
Planning Drawings
Existing Site Plans
Sheet 20

Site: Glaslyn Cable Uprating		A1 100%	CAD
Originator Dwg No: GLAS-ARUP-70-XX-DR-X-9020	Originators Proj Ref: 295280-00		
NG Investment No:	Sheet No: 20	Total No. of Sheets 39	Issue: C
NG Dwg No:			
Scale: 1:500			




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Key Plan

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Legend:

Work site boundary

Existing Watercourse

Existing Fenceline

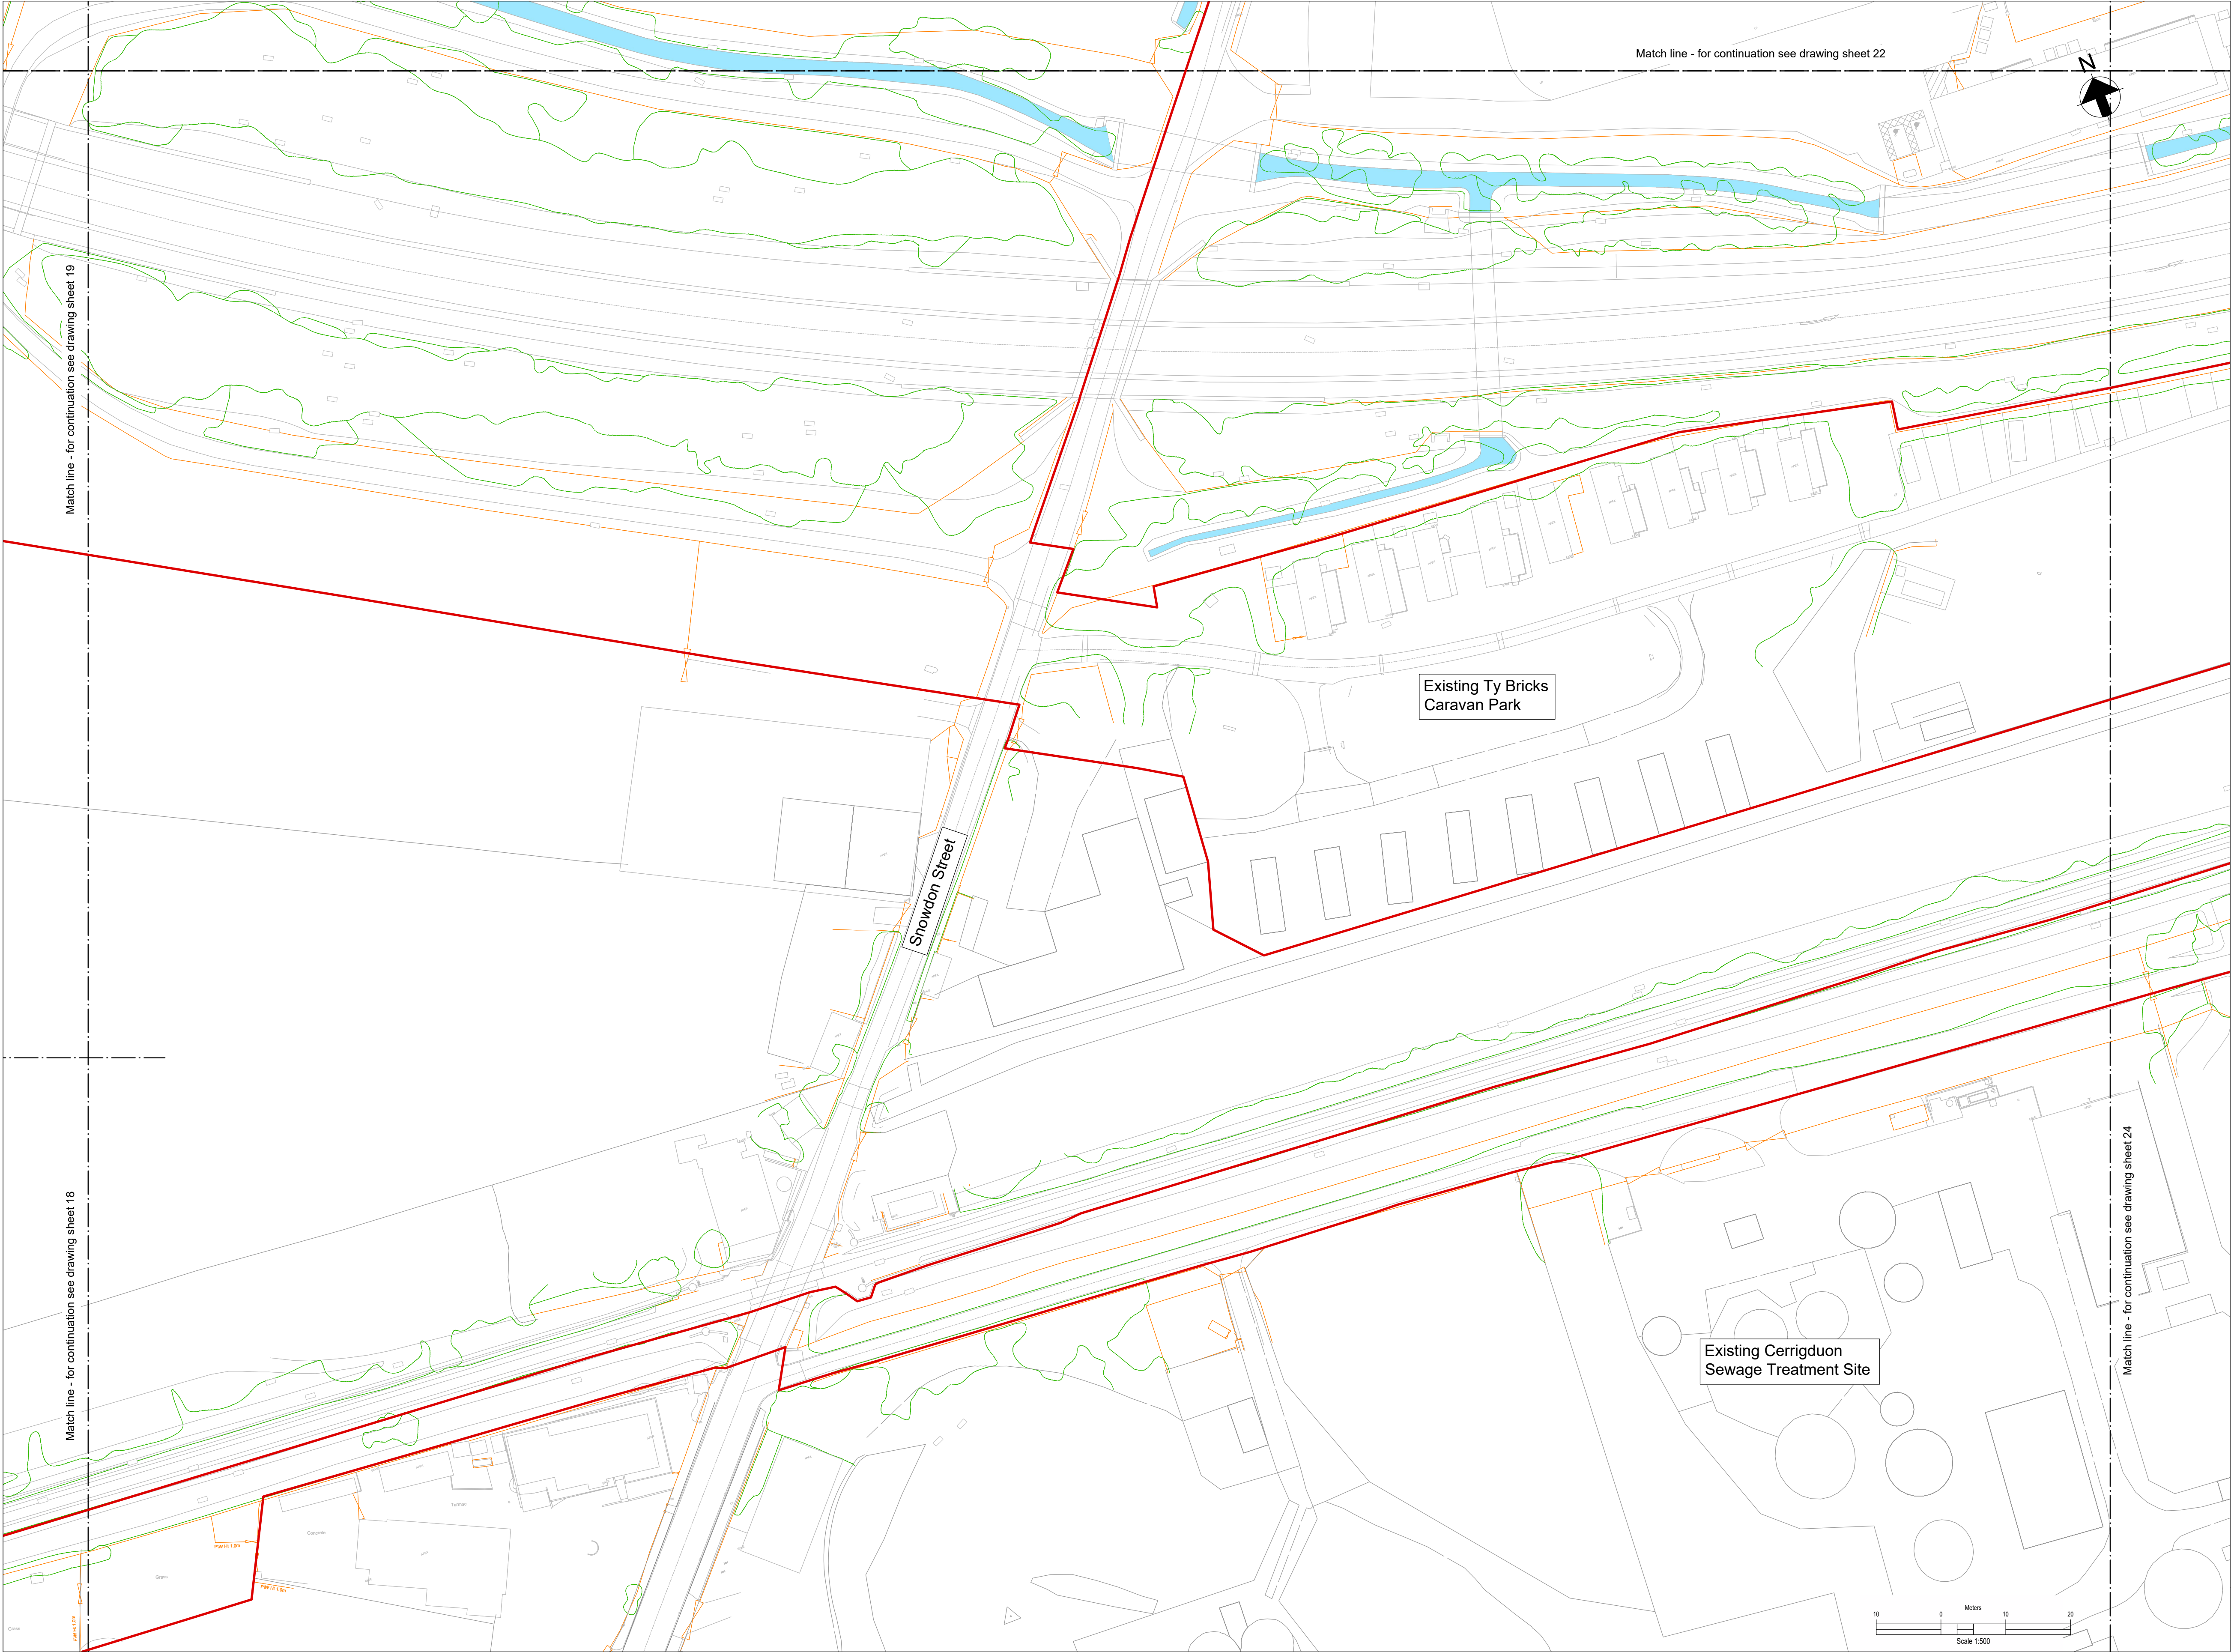Existing Gate


Existing trees and vegetation

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Dwg Title:
Planning Drawings
Existing Site Plans
Sheet 21

Site: Glaslyn Cable Uprating		A1 100%	CAD
Originator Dwg No: GLAS-ARUP-70-XX-DR-X-9021		Originators Proj.Ref: 295280-00	
NG Investment No:		Sheet No:	Total No. of Sheets
NG Dwg No:		21	39
Scale: 1:500		Issue: C	



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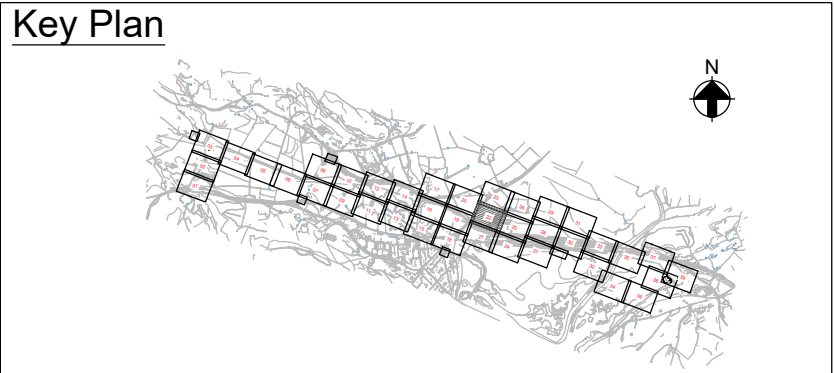
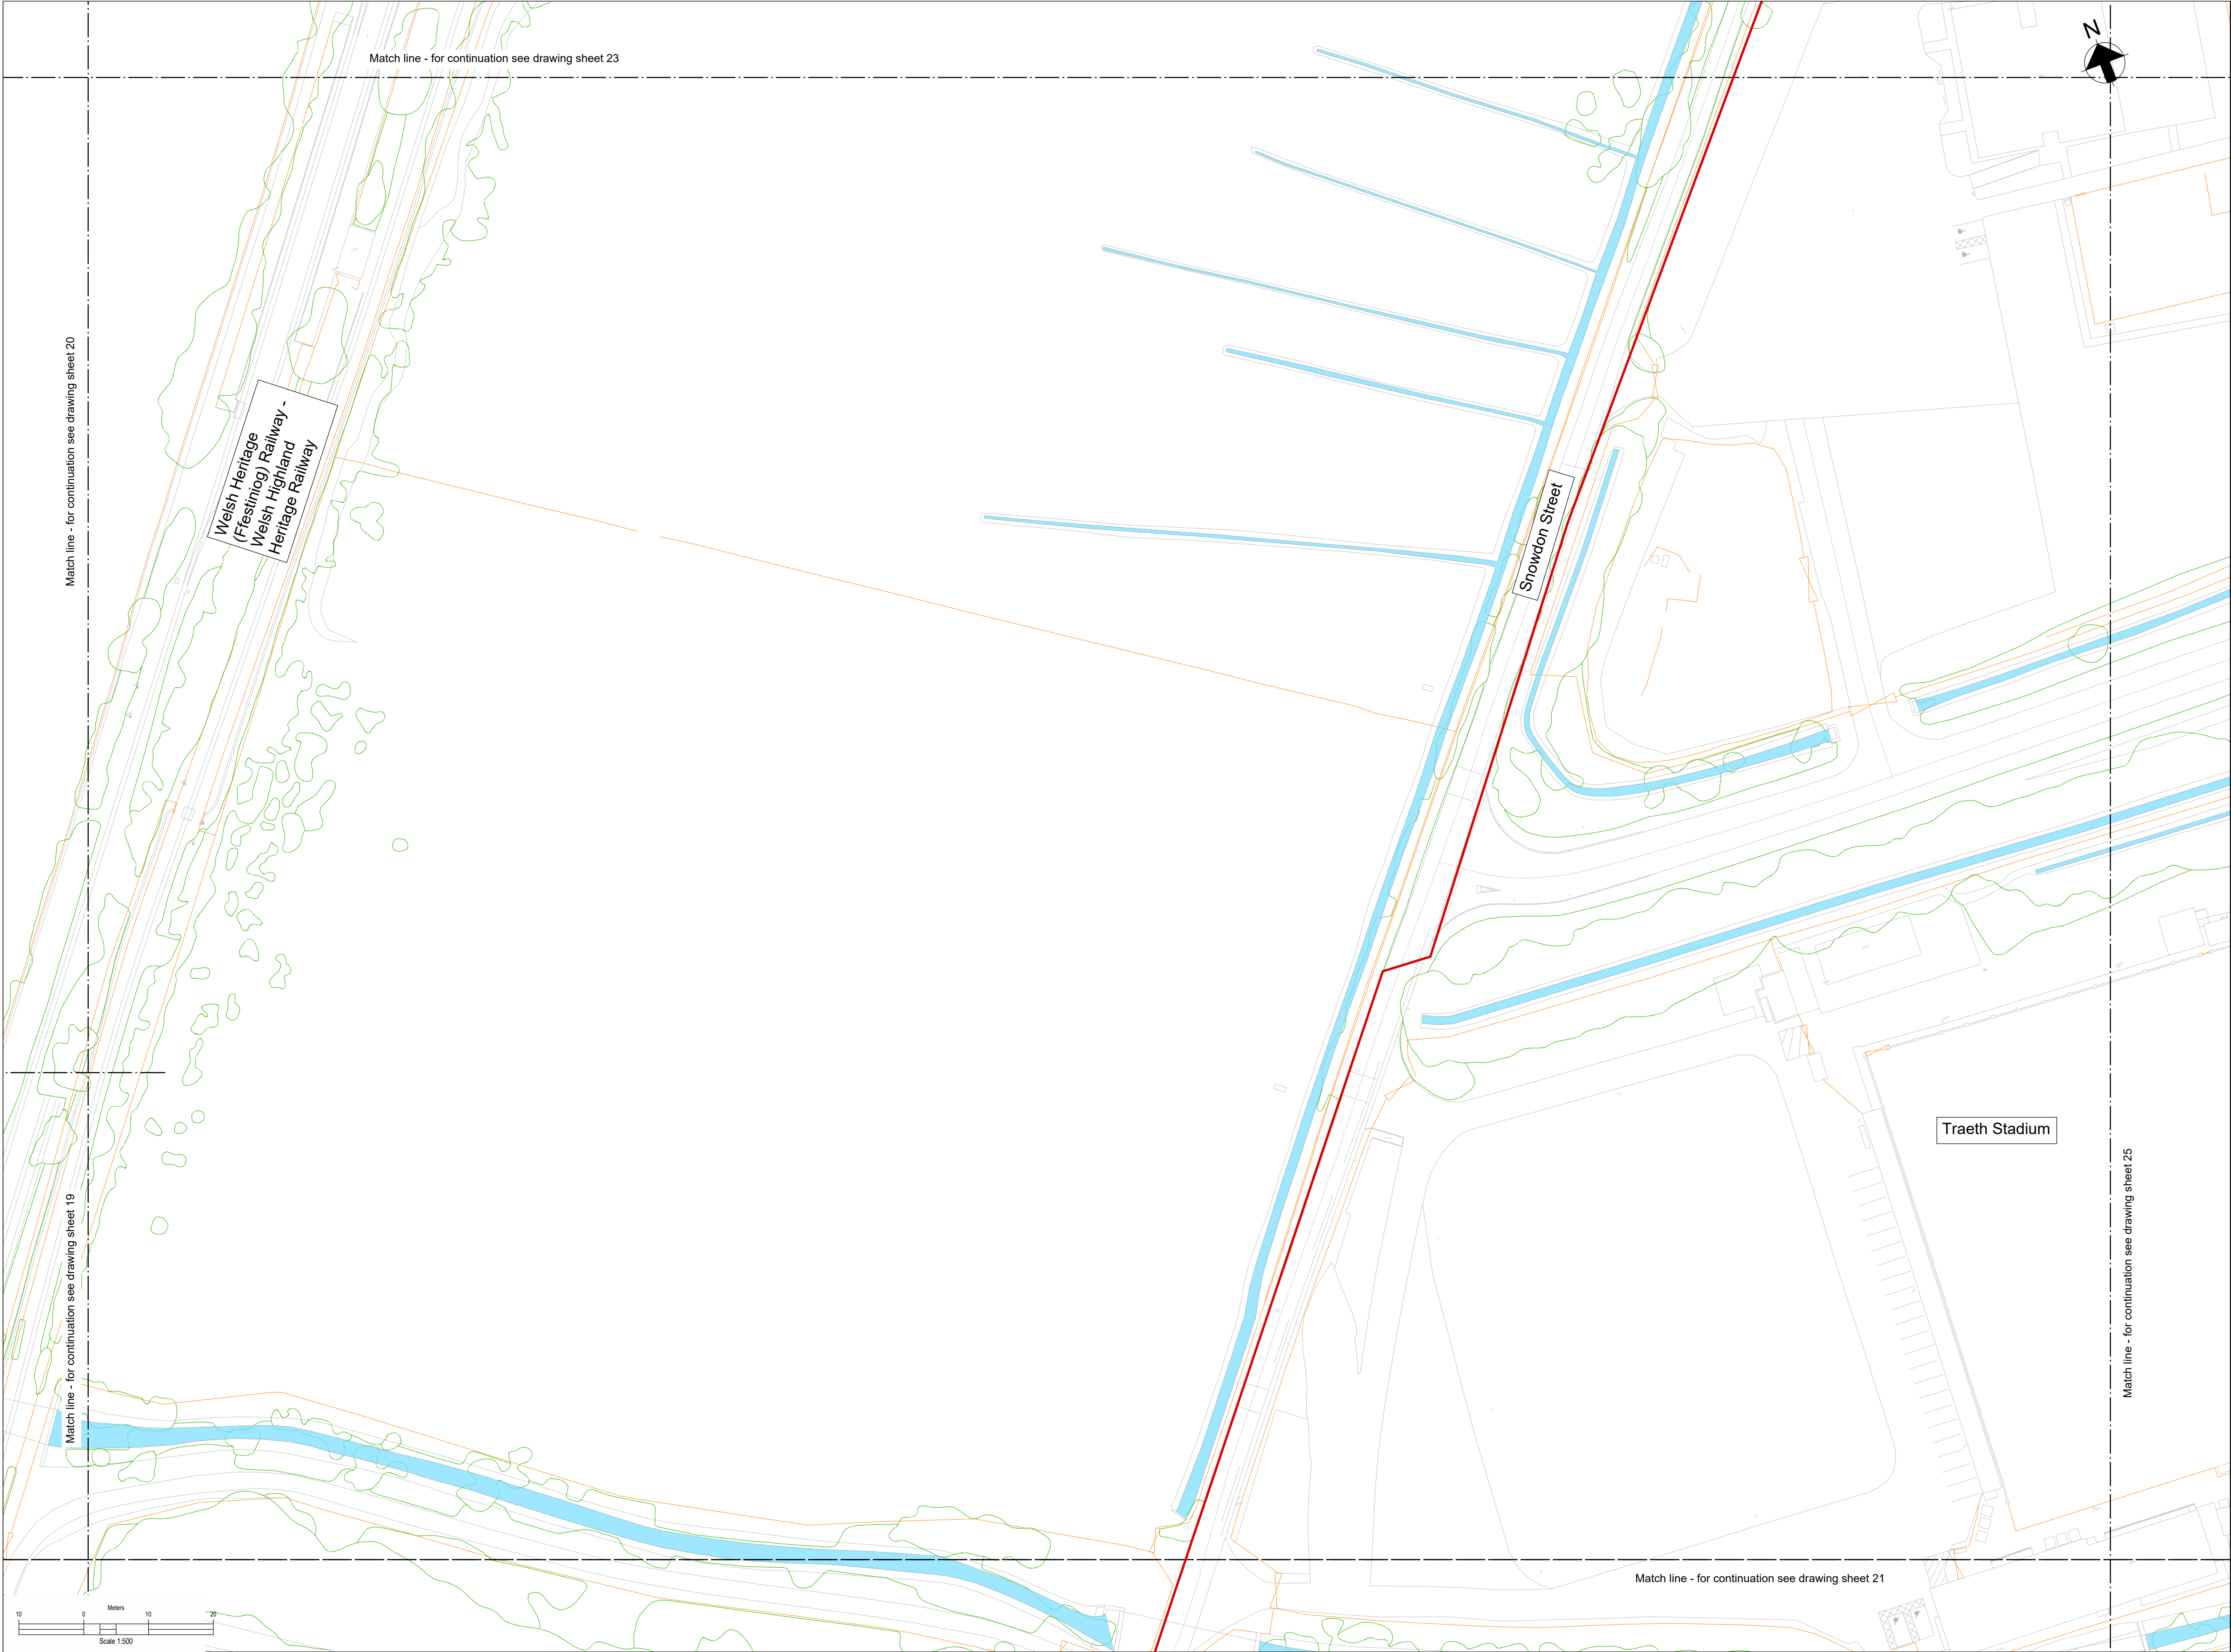
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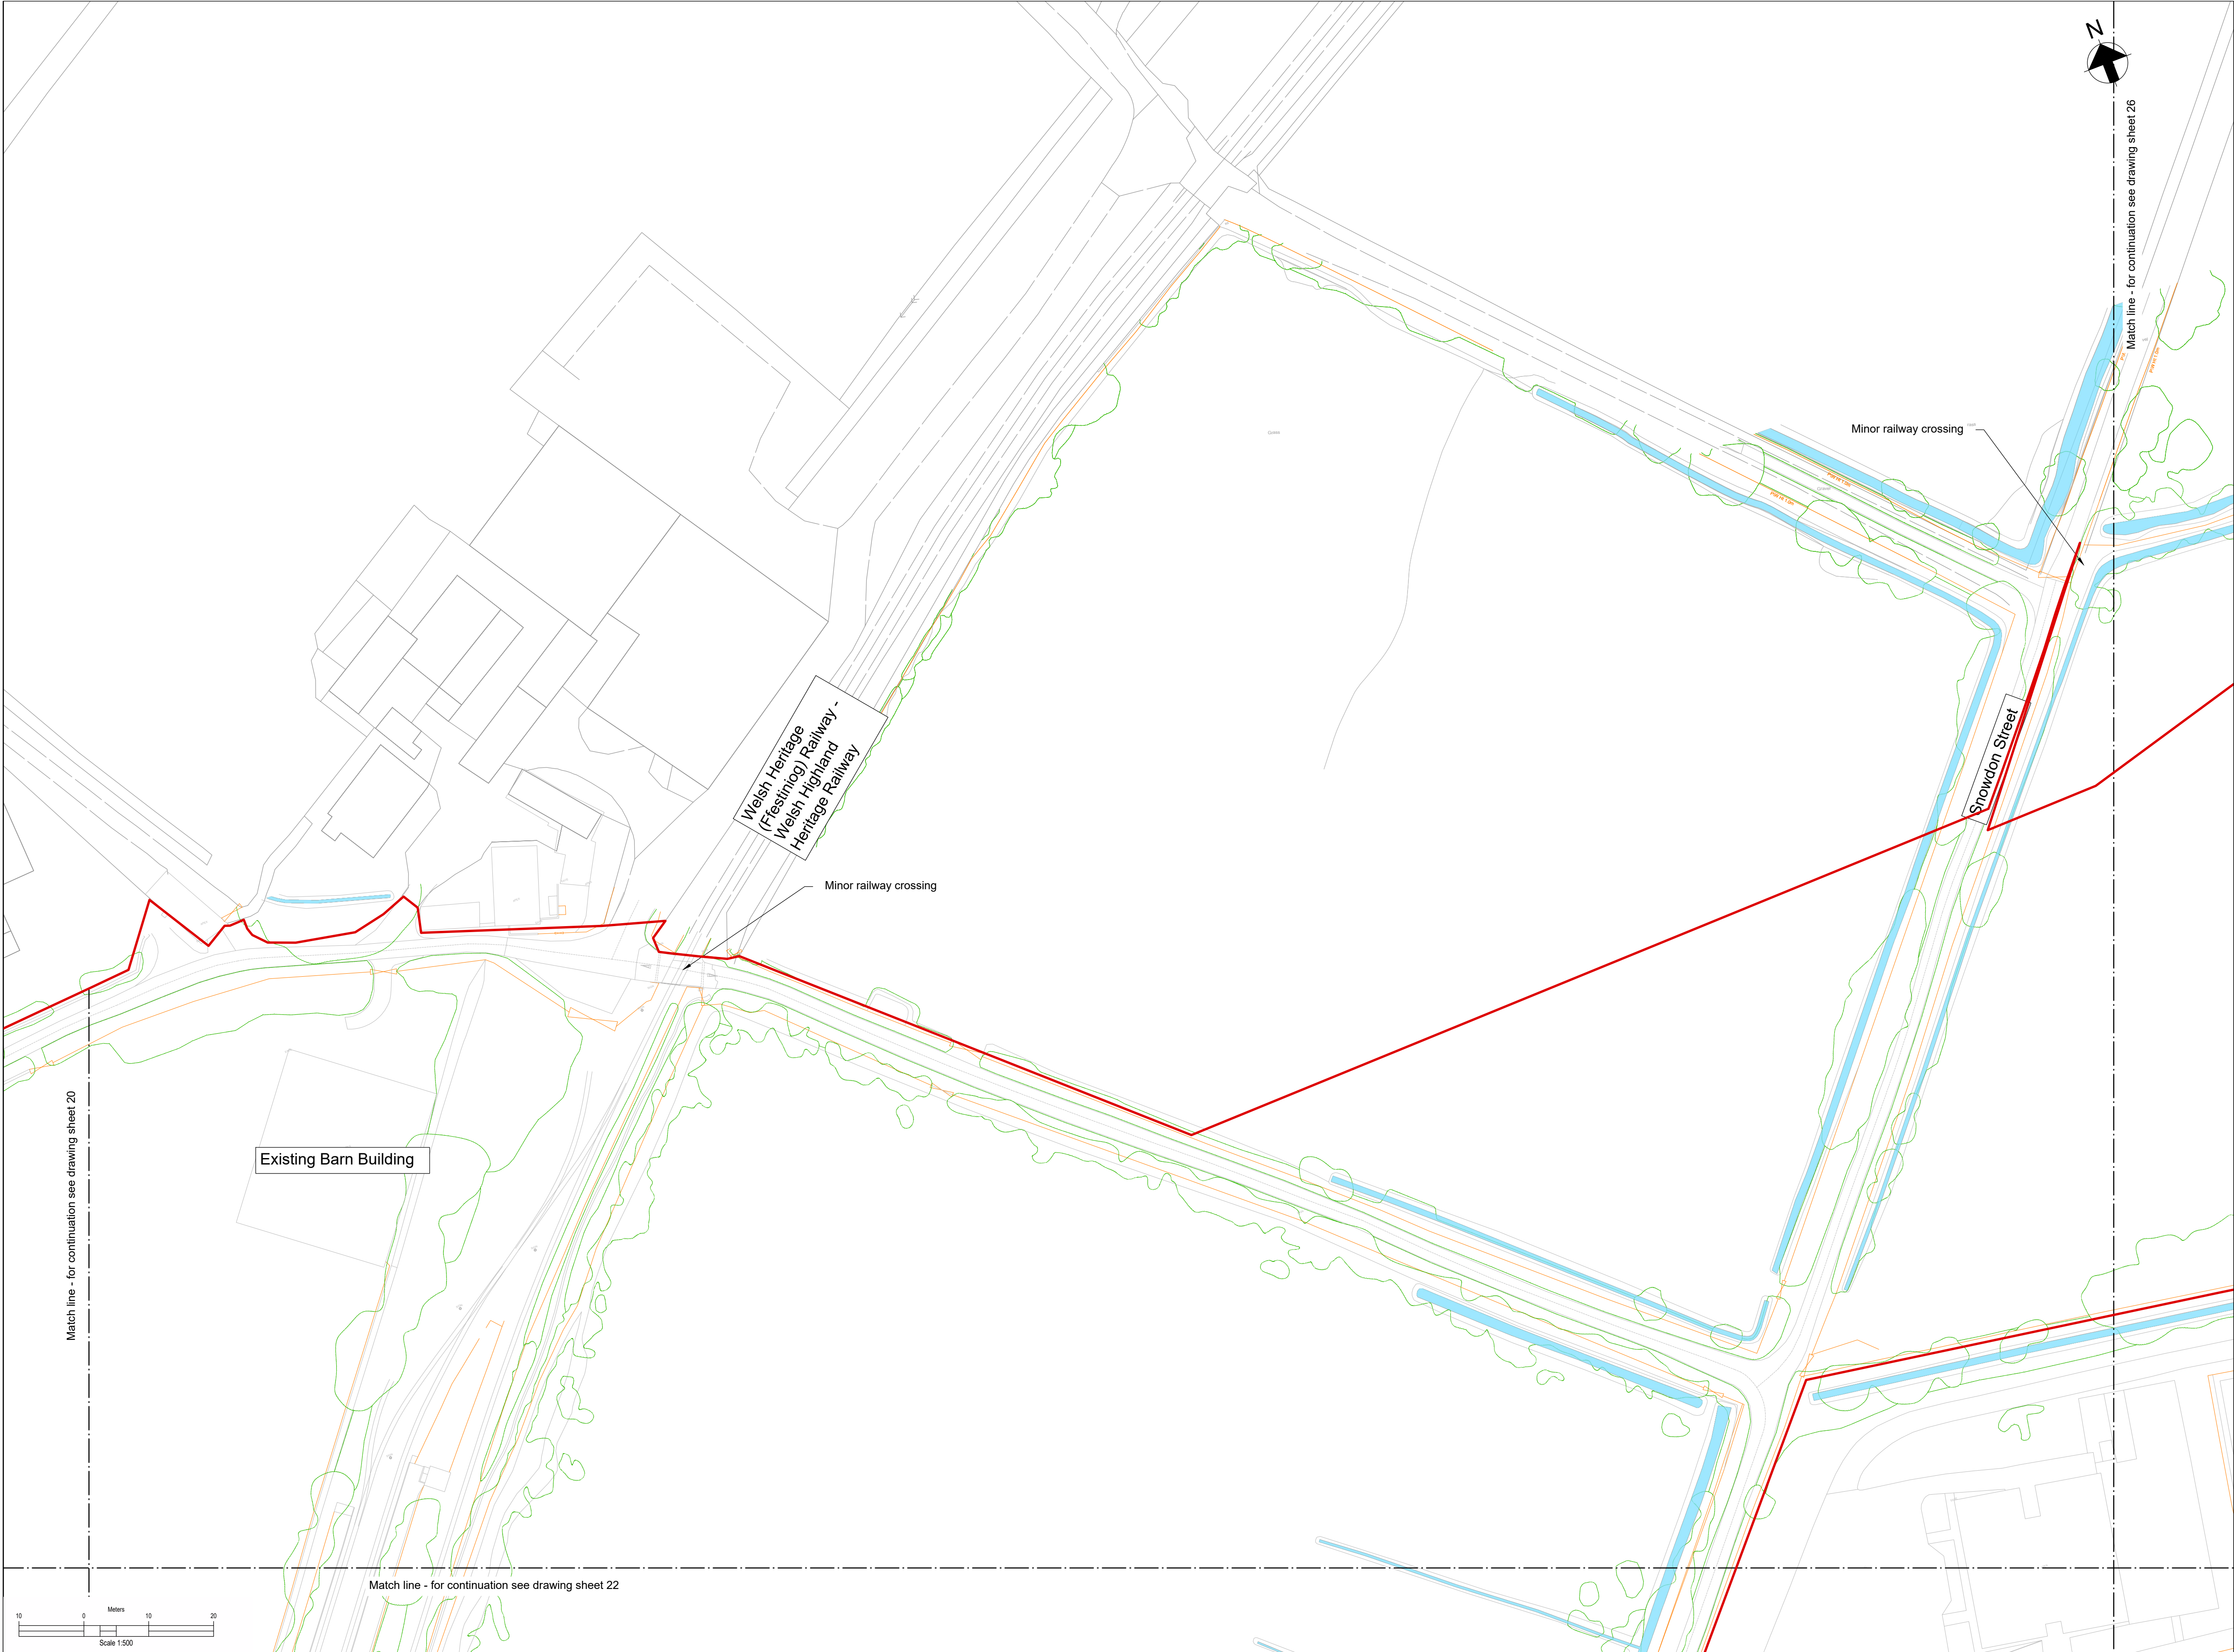
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- Legend:
- Work site boundary
 - Existing Watercourse
 - Existing Fenceline
 - Existing Gate
 - Existing trees and vegetation

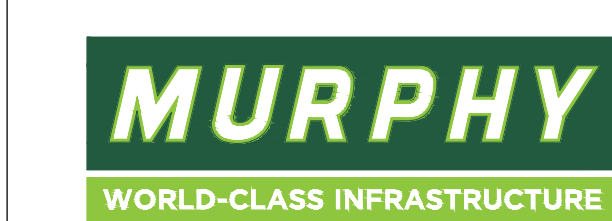

Key Plan

Notes:

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- All levels are in meters Above Ordnance Datum (mAOD)
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Legend:



Work site boundary

Existing Watercourse

Existing Fenceline

Existing Gate


Existing trees and vegetation

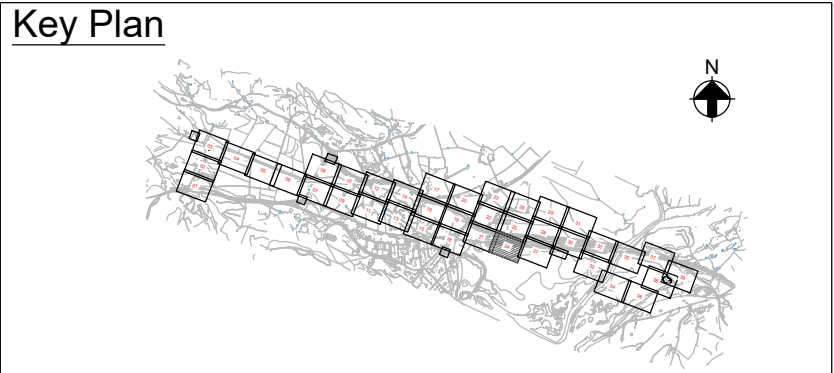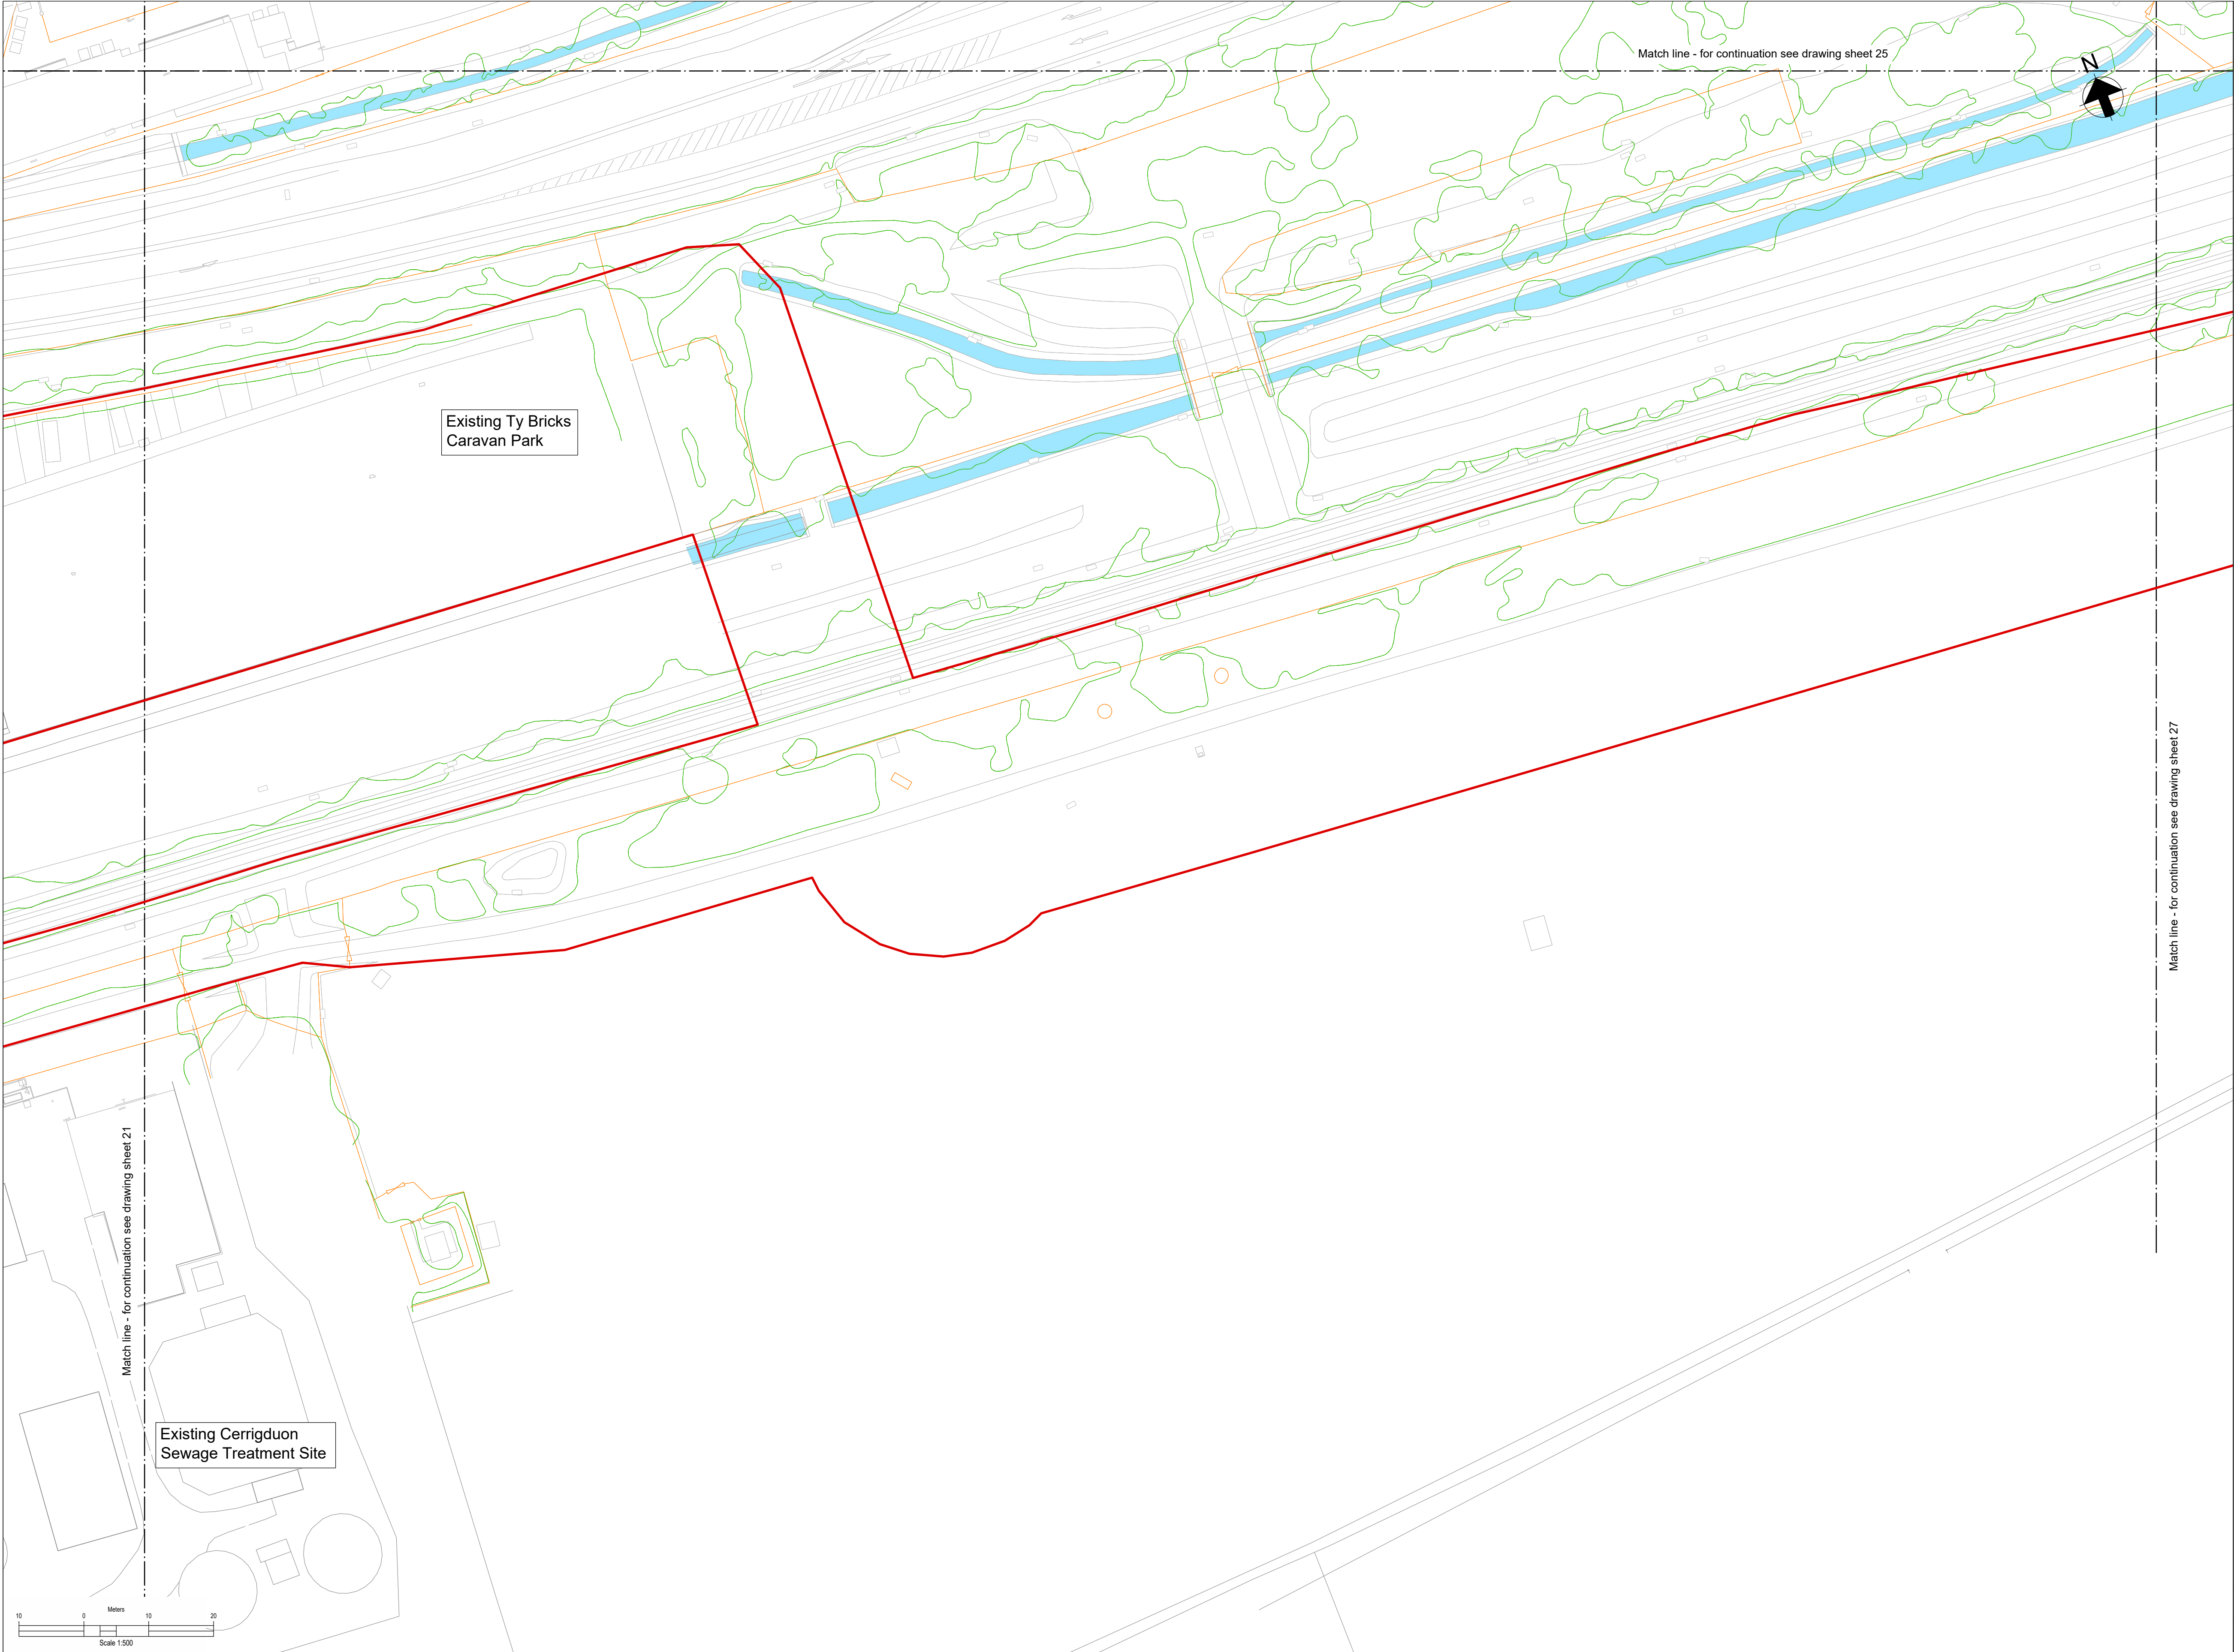


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- Legend:**
- Work site boundary
 - Existing Watercourse
 - Existing Fenceline
 - Existing Gate
 - Existing trees and vegetation


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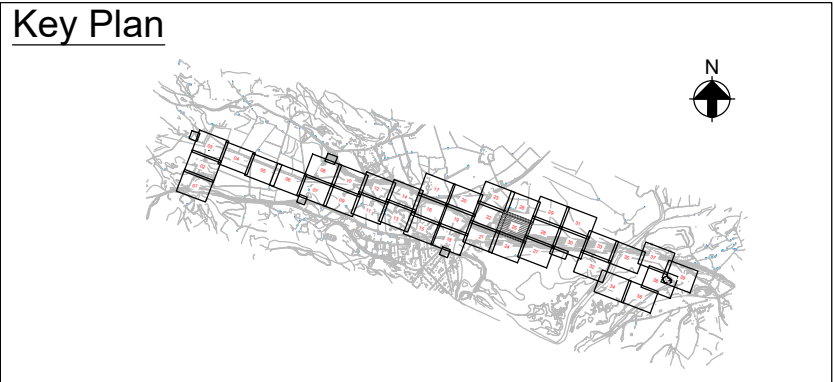
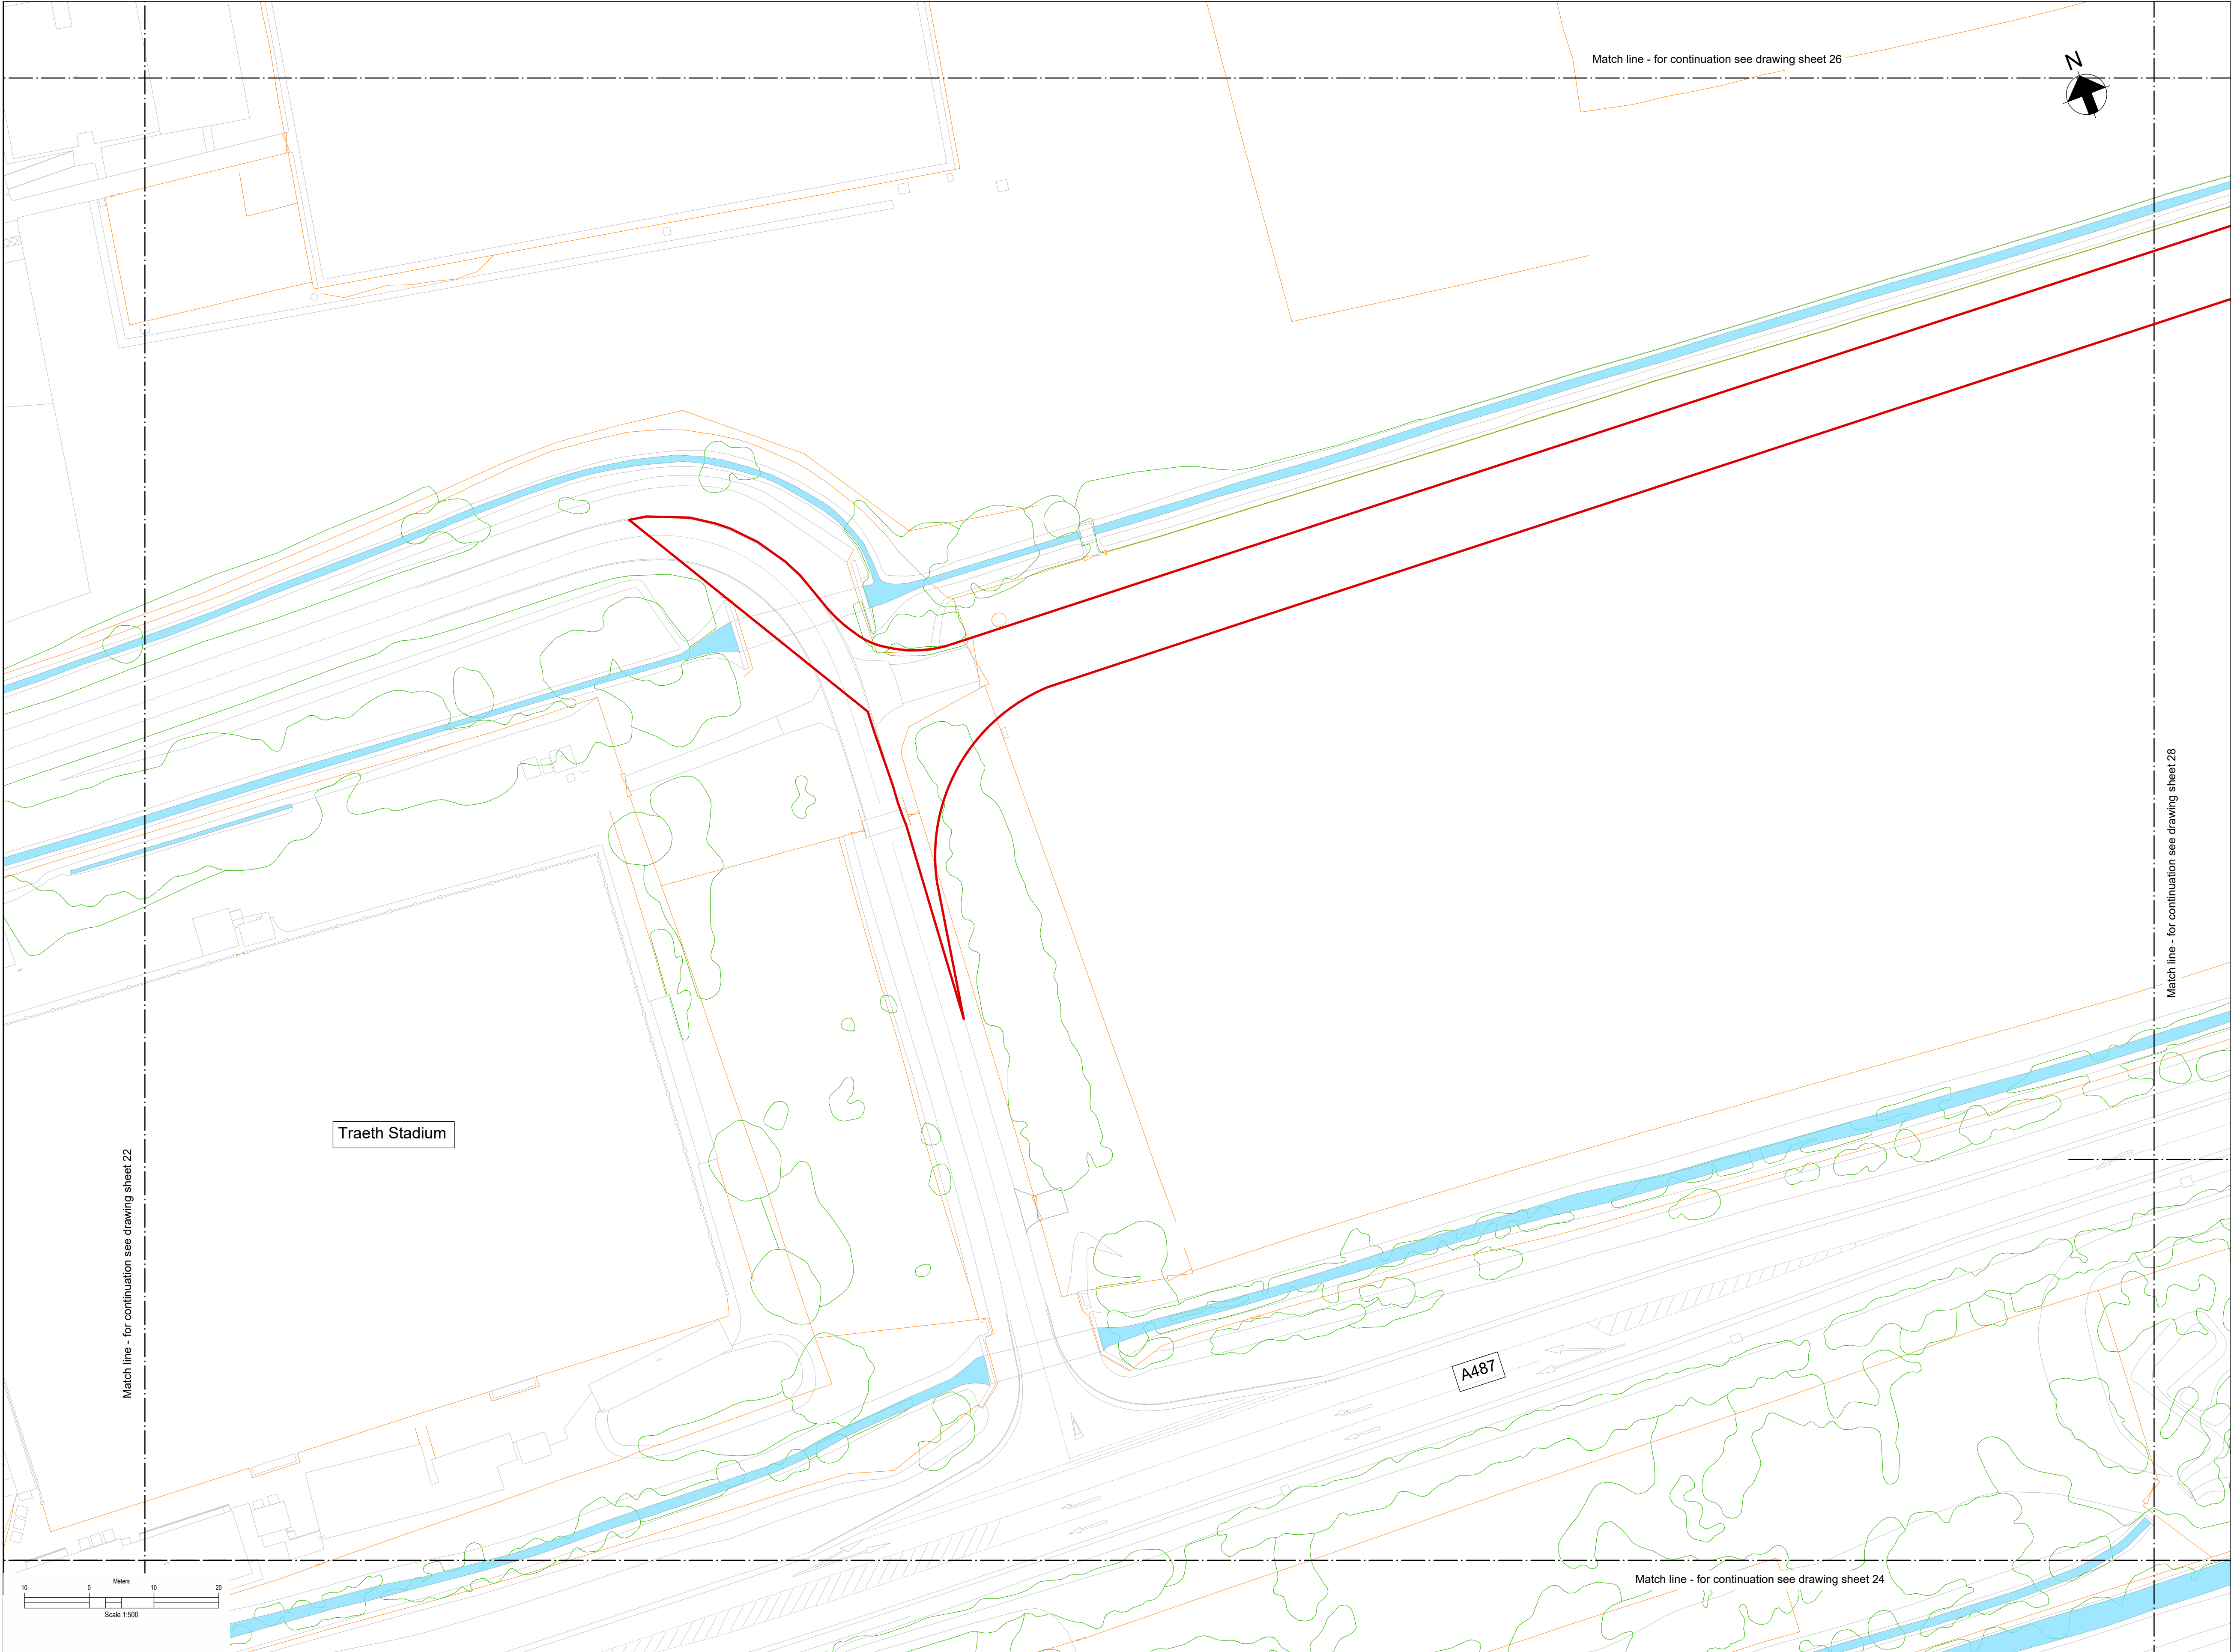
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Dwg Title:
**Planning Drawings
Existing Site Plans
Sheet 24**

Site: Glaslyn Cable Uprating	A1 100%	CAD
Originator Dwg No: GLAS-ARUP-70-XX-DR-X-9024	Originators Proj.Ref: 295280-00	
NG Investment	Sheet No:	Total No. of Sheets
NG Dwg No:	24	39
Scale: 1:500		Issue: C



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Legend:

- Work site boundary
- Existing Watercourse
- Existing Fenceline
- Existing Gate
- Existing trees and vegetation

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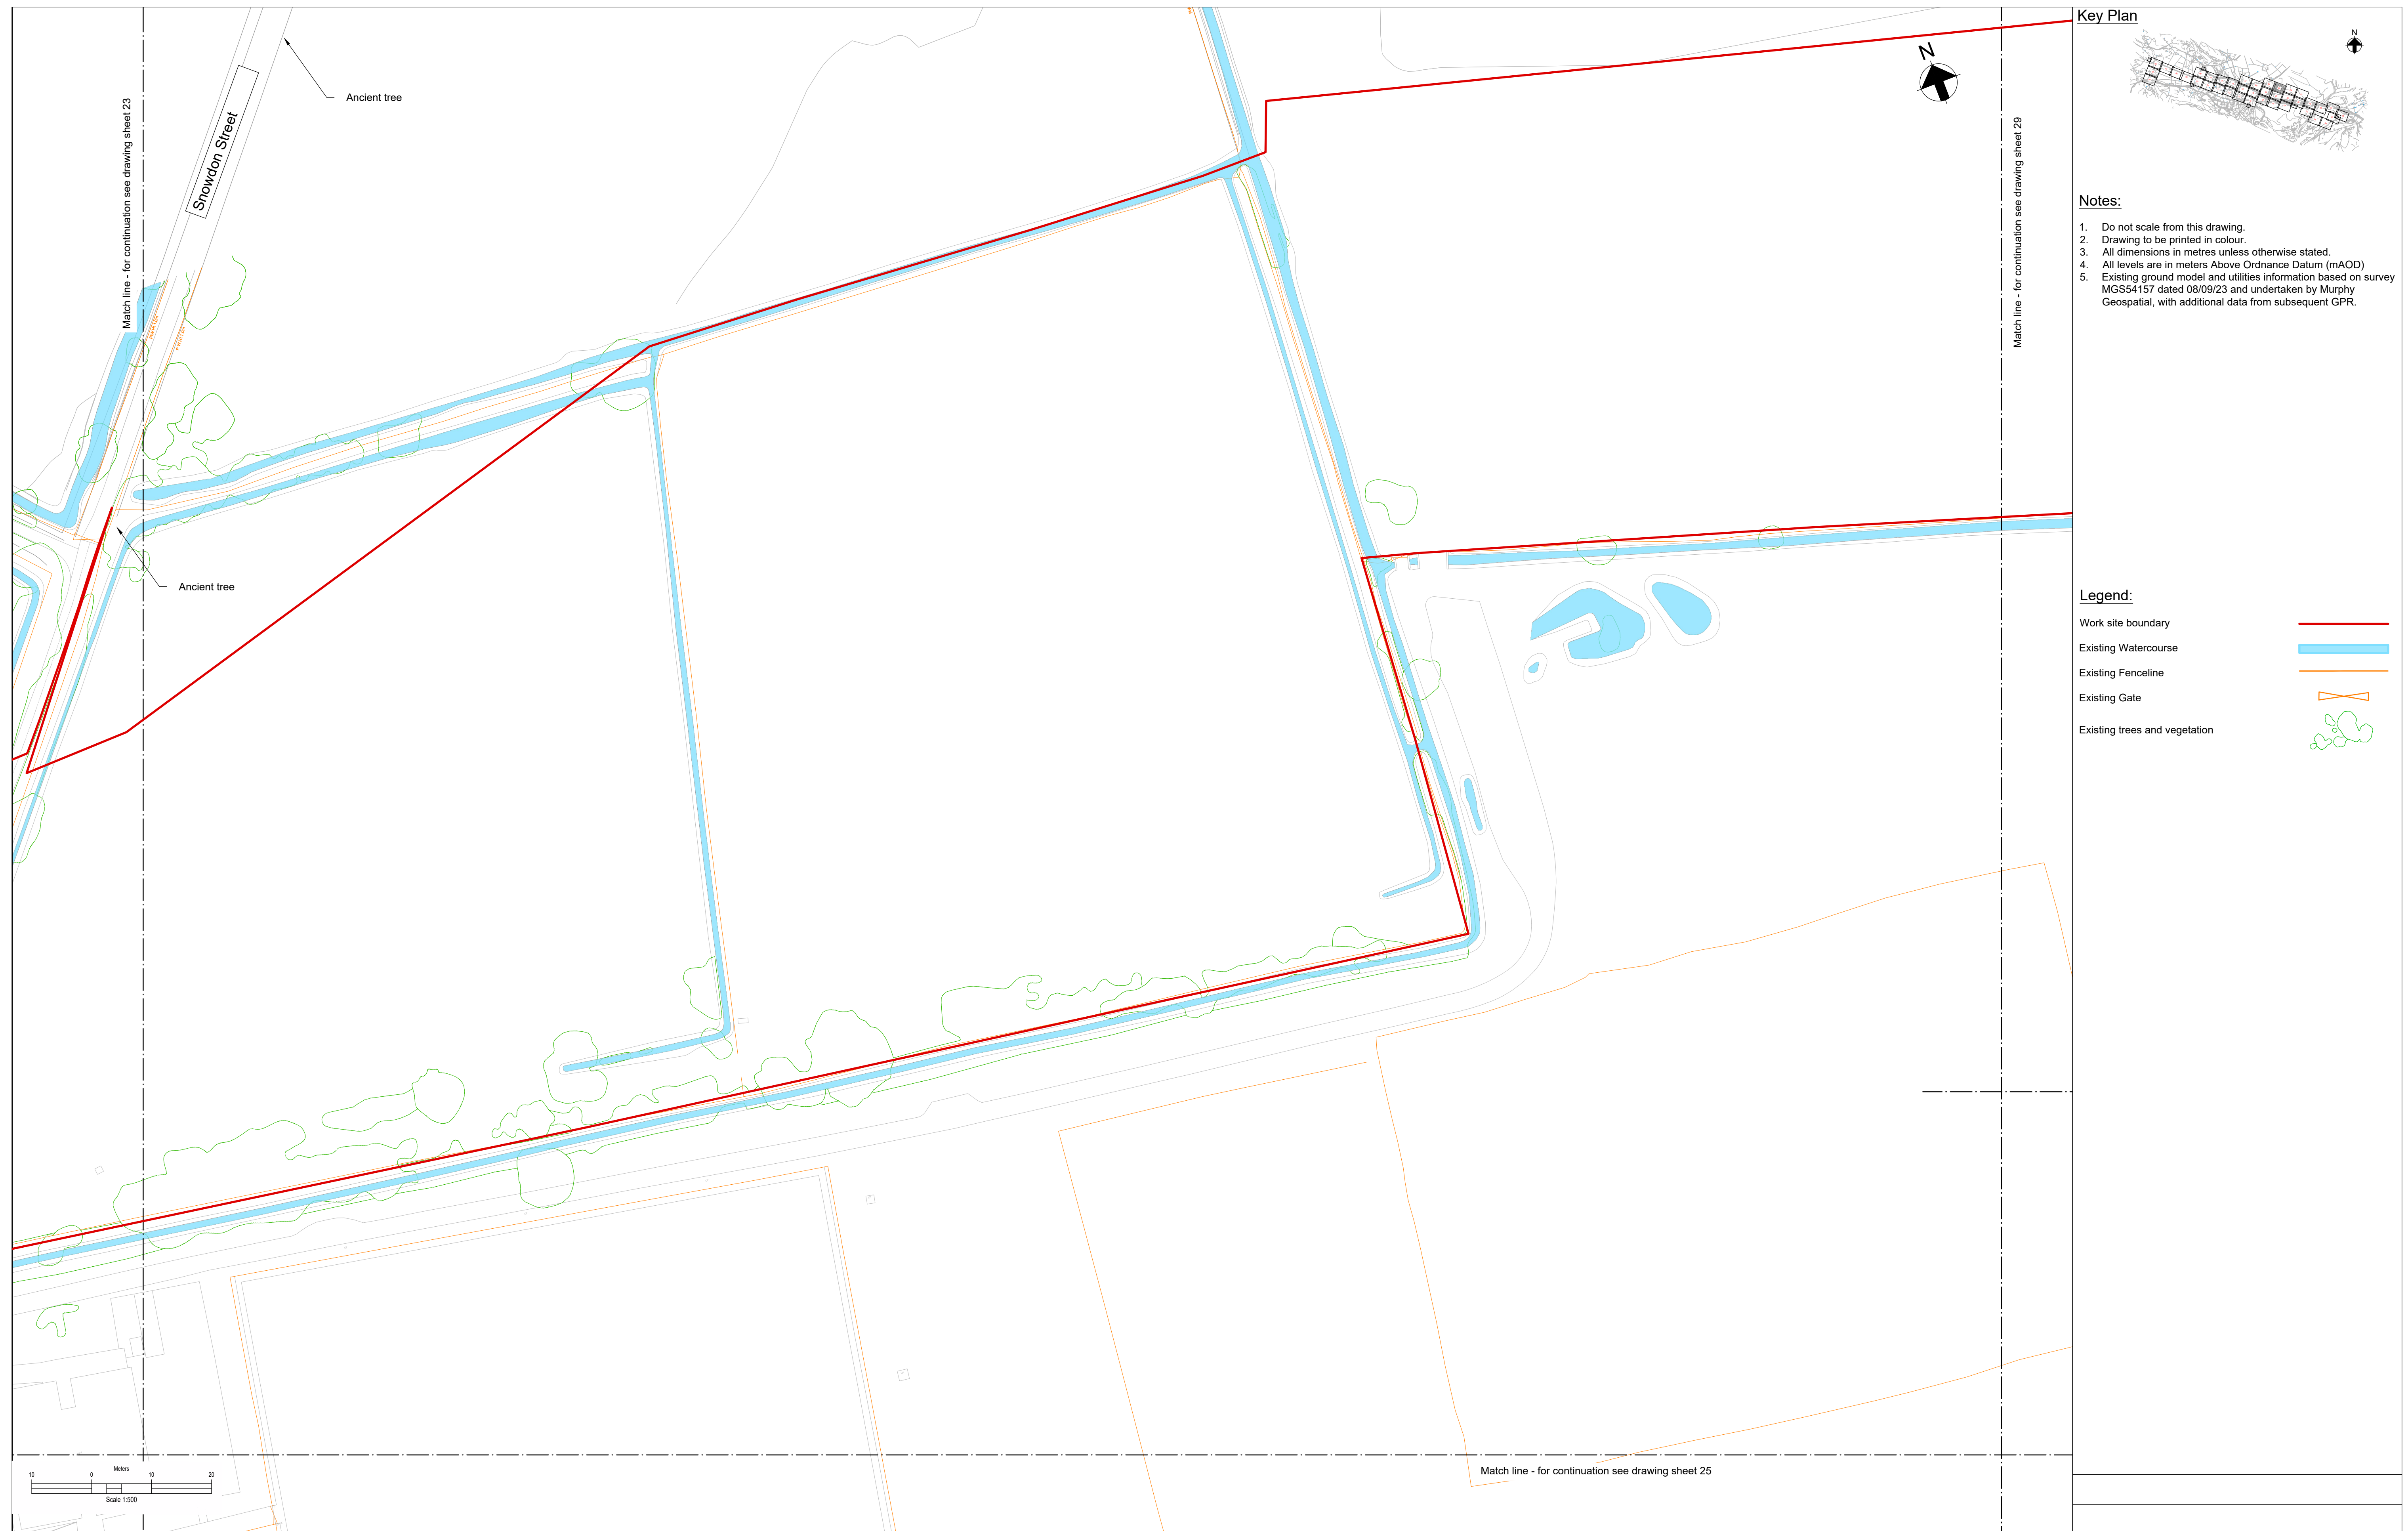
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Dwg Title:
Planning Drawings
Existing Site Plans
Sheet 25

Site: Glaslyn Cable Uprating	A1 100%	CAD
Originator: Dwg No: GLAS-ARUP-70-XX-DR-X-9025	Originators Proj.Ref: 295280-00	
NG Investment No:	Sheet No: 25	Total No. of Sheets: 39
NG Dwg No:		Issue: C
Scale: 1:500		



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Dwg Title:
Planning Drawings
Existing Site Plans
Sheet 26

Site: Glaslyn Cable Upgrading		A1	CAD
Originator Dwg No: GLAS-ARUP-70-XX-DR-X-9026		Originators Proj Ref:	295280-00
NG Investment No:		Sheet No:	Total No. of Sheets
NG Dwg No:			
Scale: 1:500		26	C



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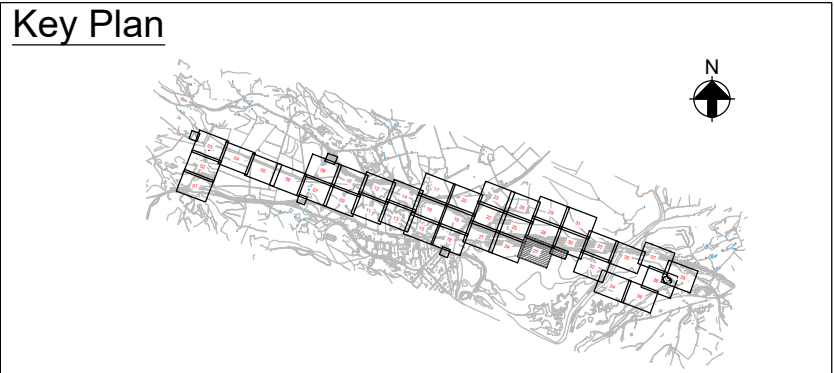
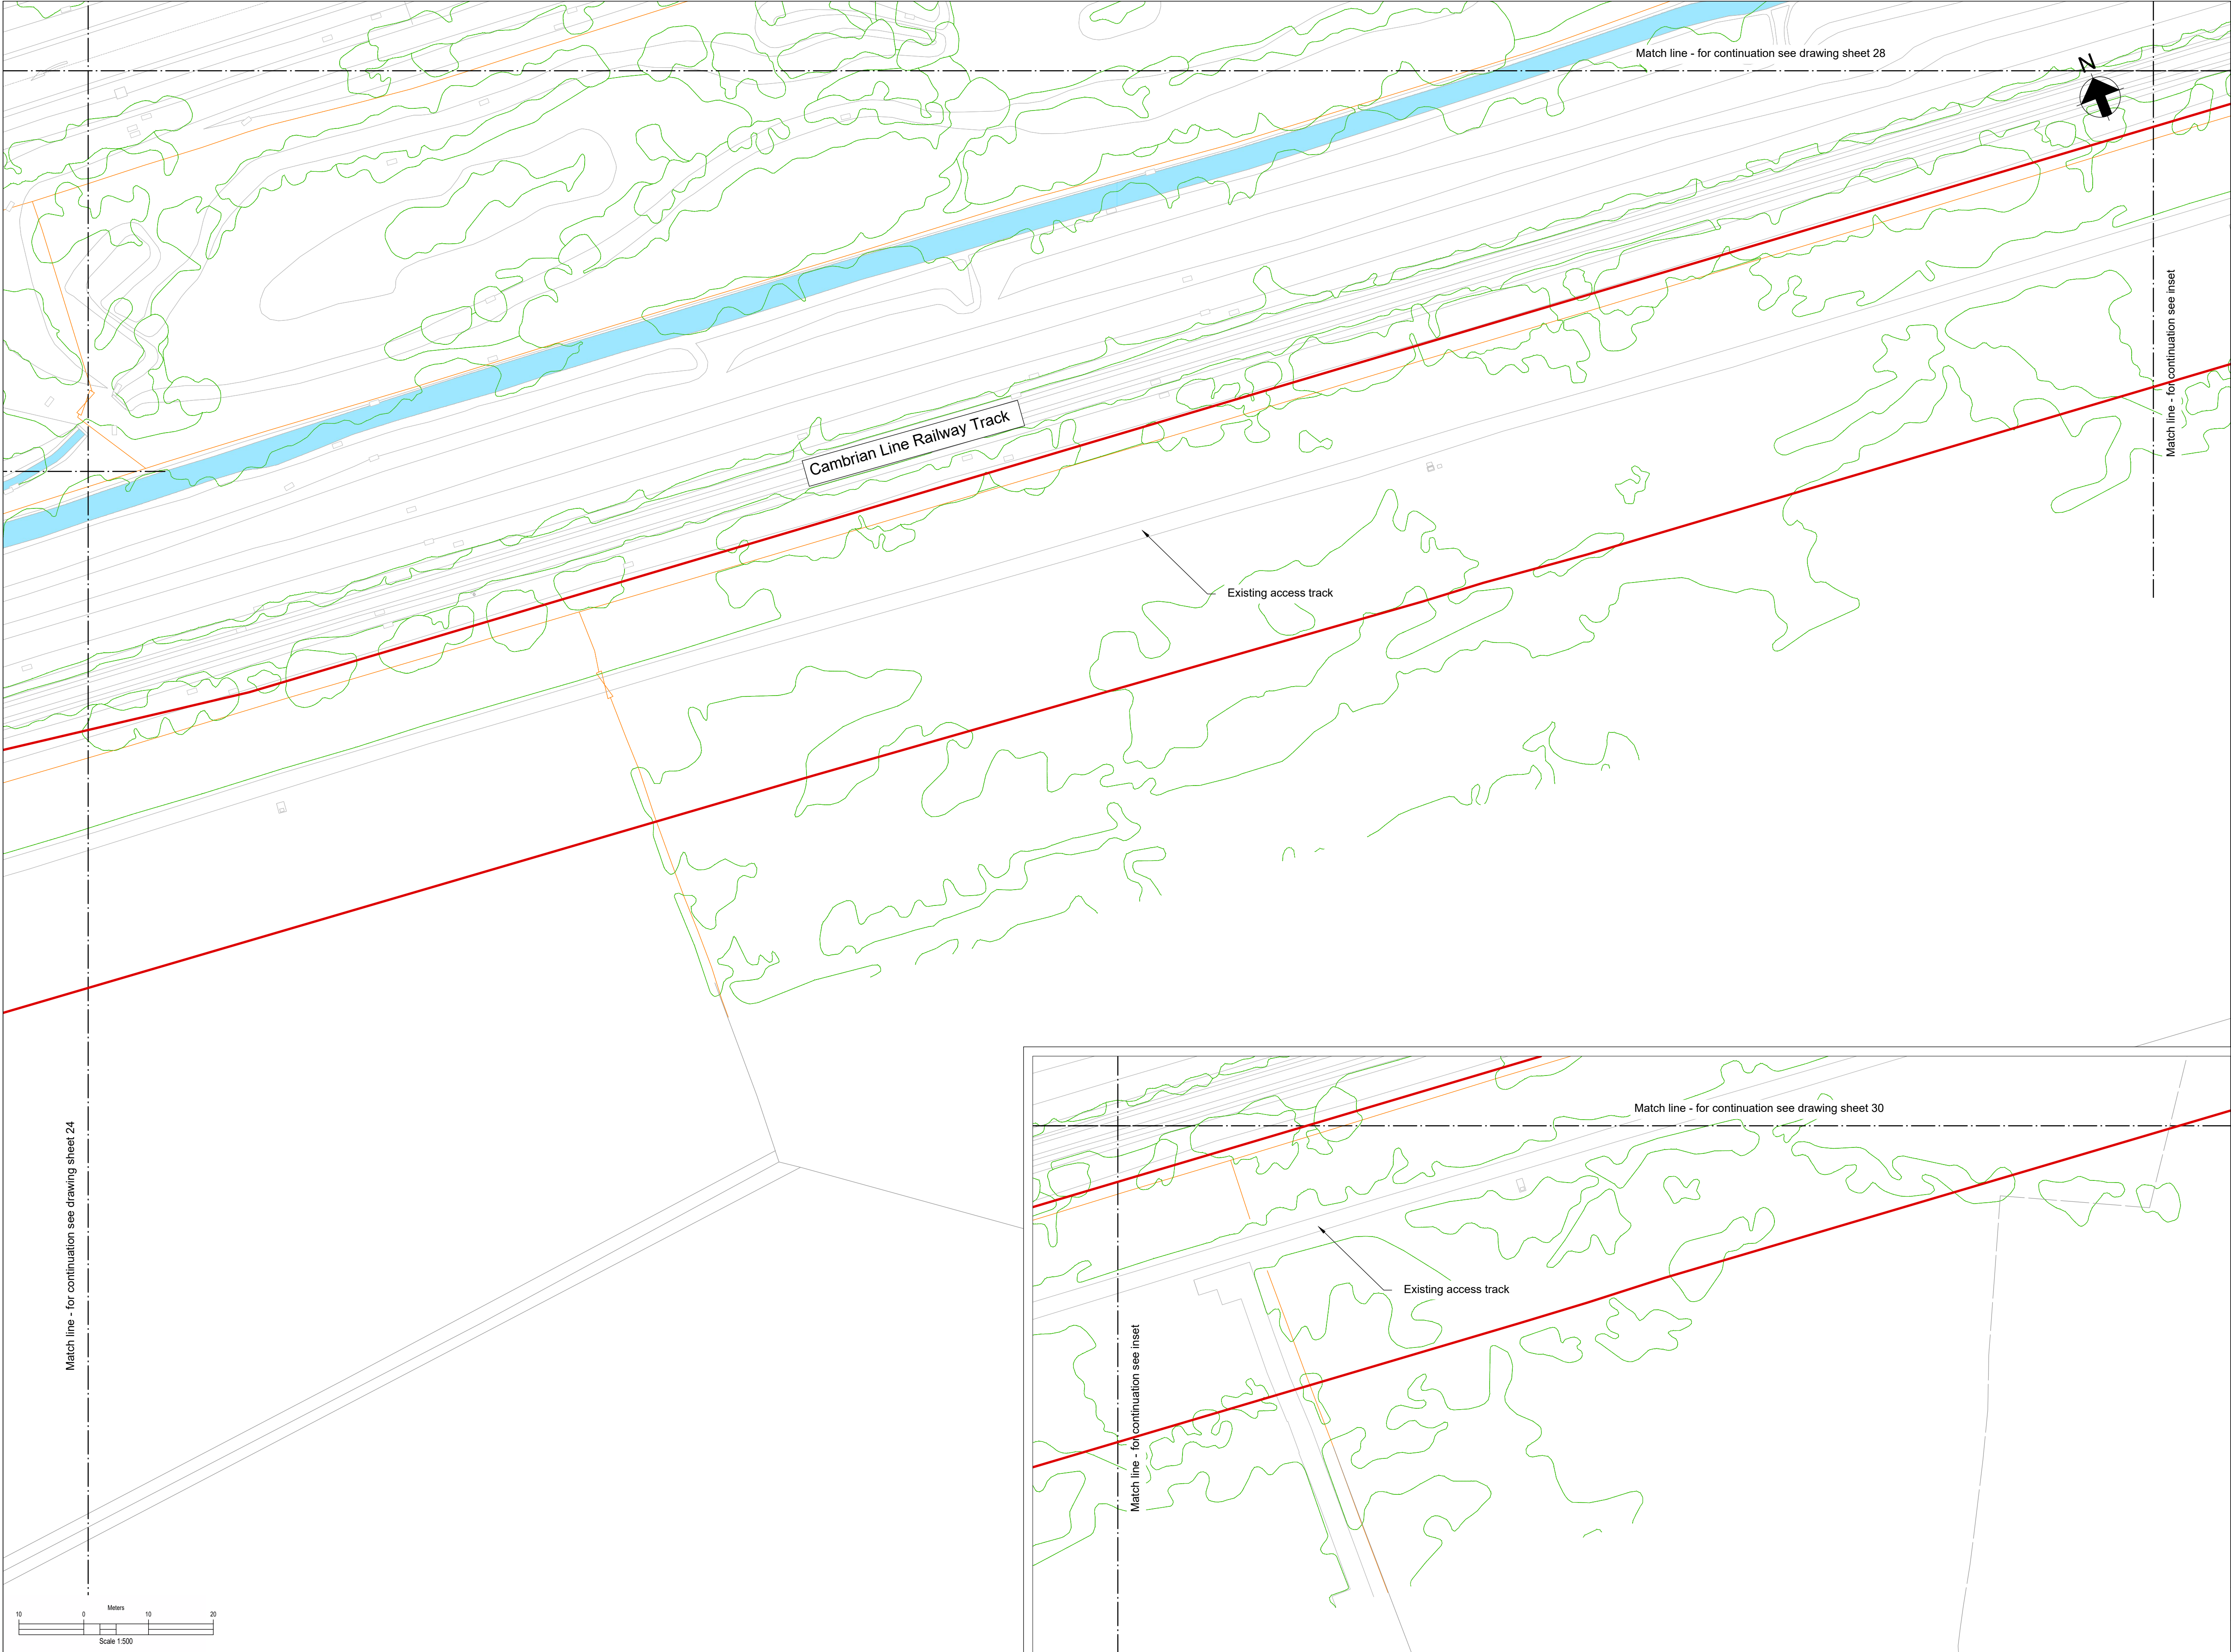
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
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


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
- Legend:**
- Work site boundary
 - Existing Watercourse
 - Existing Fenceline
 - Existing Gate
 - Existing trees and vegetation



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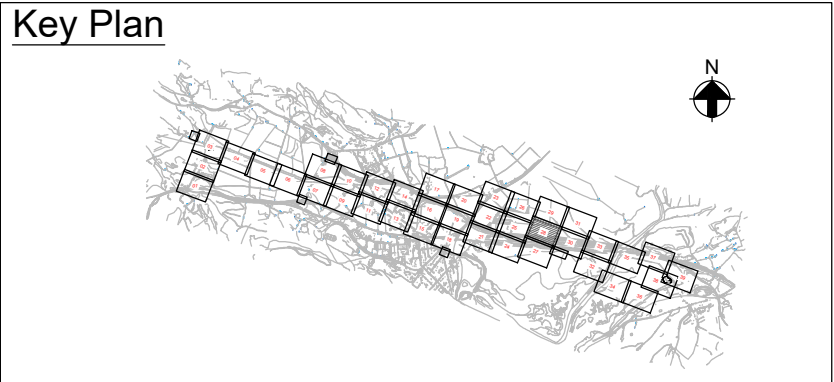
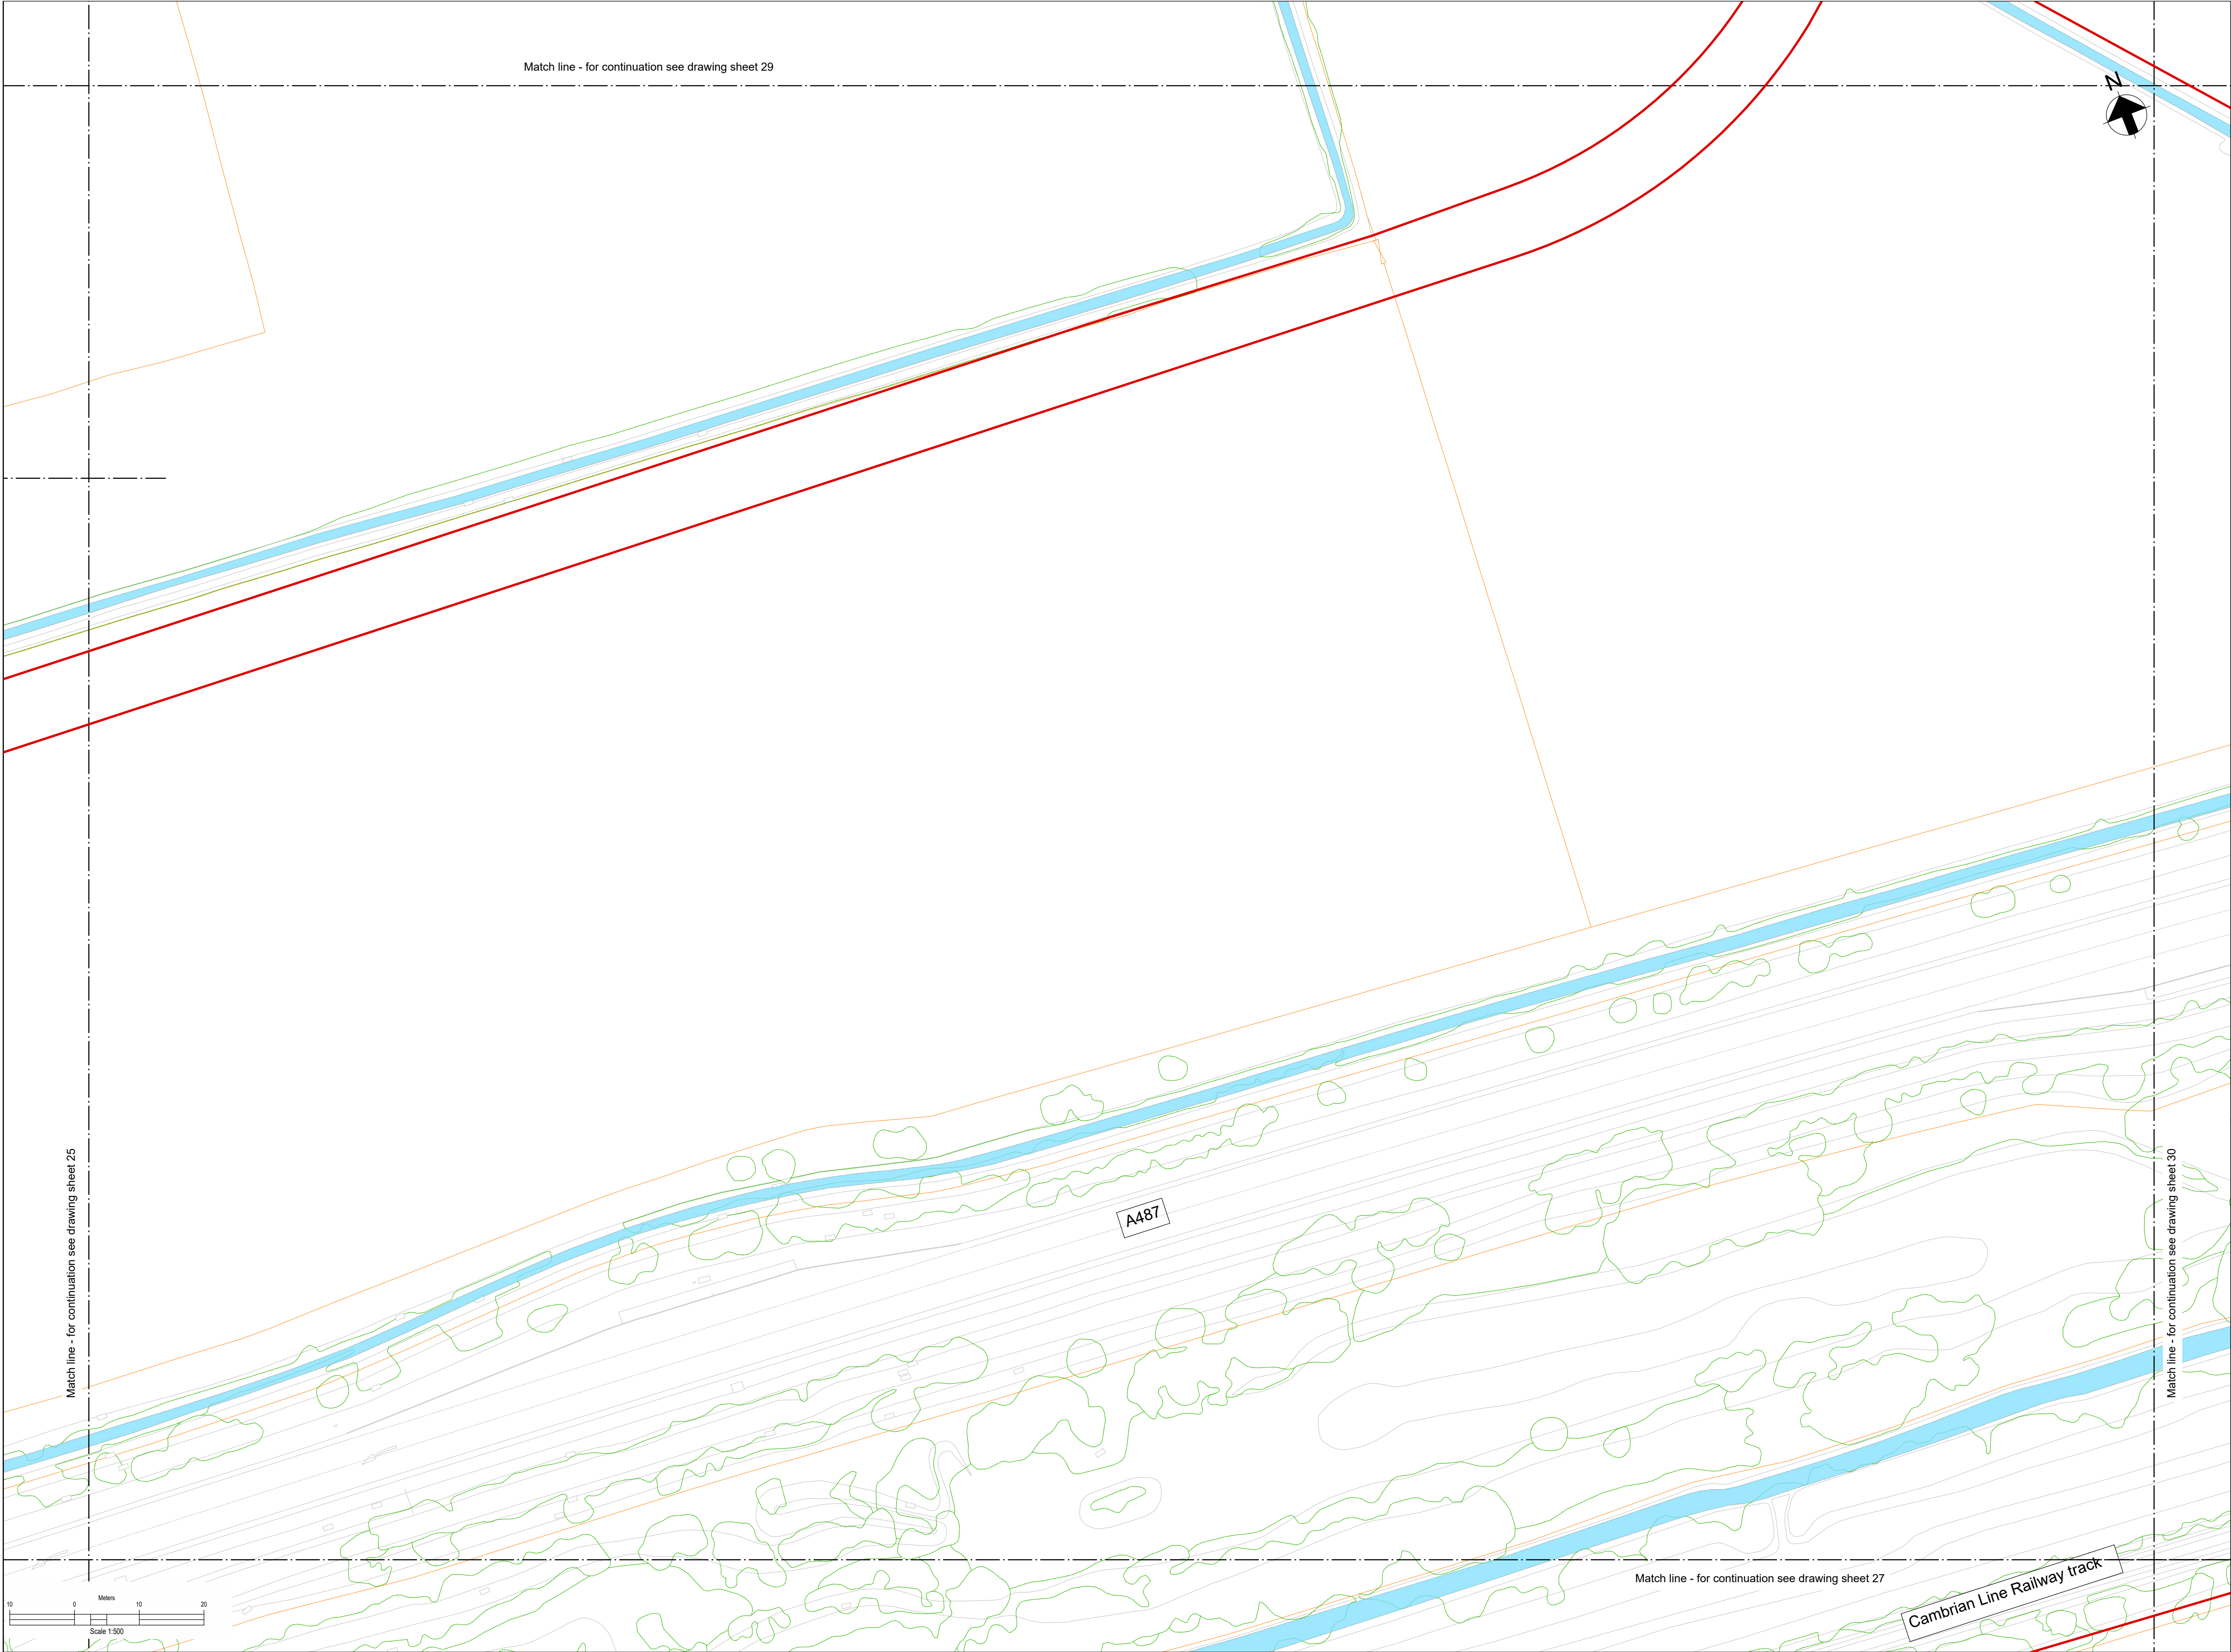
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Dwg Title:
**Planning Drawings
Existing Site Plans
Sheet 27**

Site: Glaslyn Cable Uprating	A1 100%	CAD
Originator Dwg No: GLAS-ARUP-70-XX-DR-X-9027	Originators Proj.Ref: 295280-00	
NG Investment No:	Sheet No:	Total No. of Sheets
NG Dwg No:	27	39
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- Legend:**
- Work site boundary
 - Existing Watercourse
 - Existing Fenceline
 - Existing Gate
 - Existing trees and vegetation

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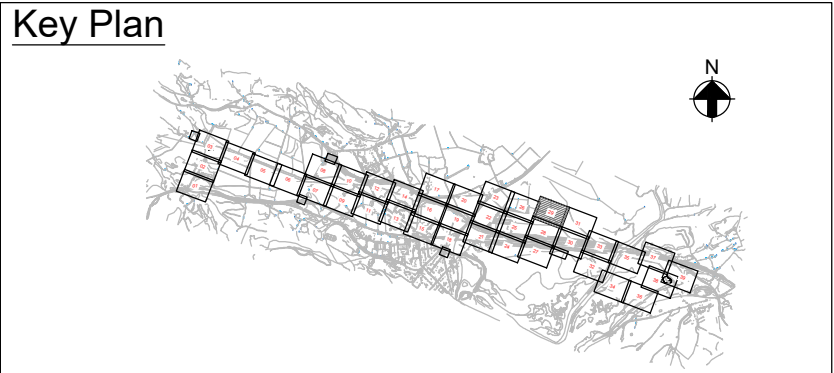
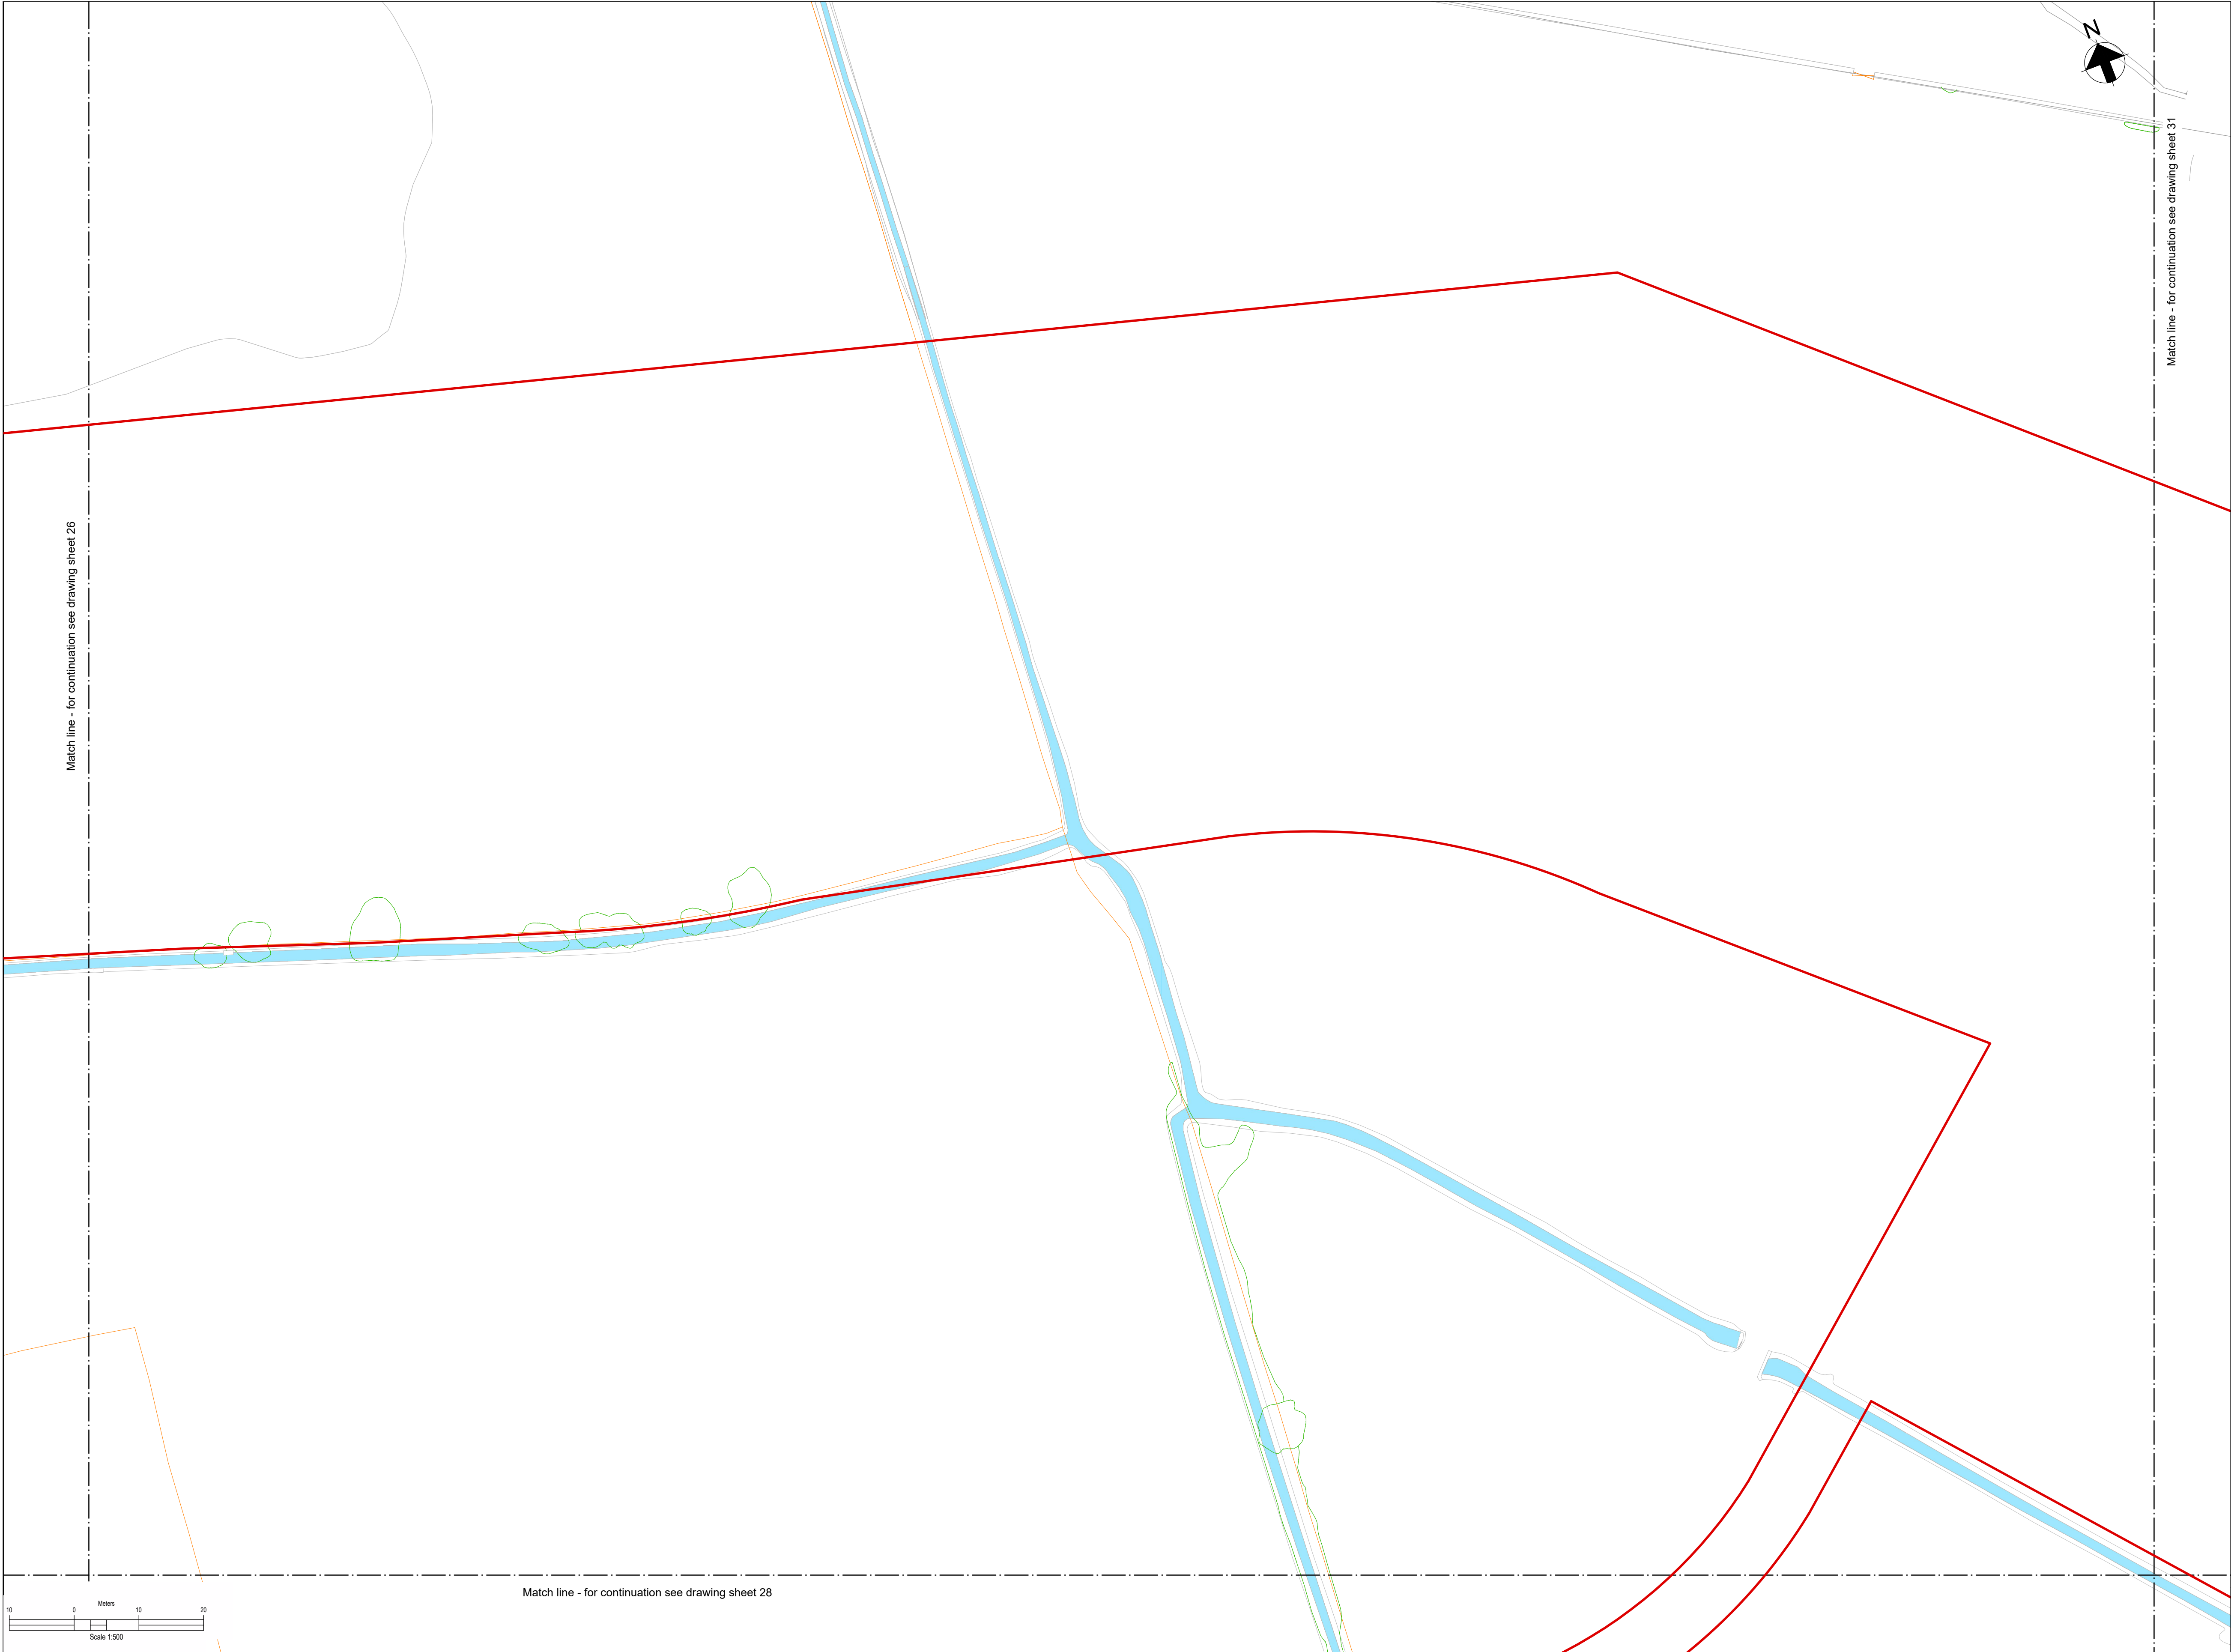
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Dwg Title:
Planning Drawings
Existing Site Plans
Sheet 28

Site: Glaslyn Cable Uprating	A1 100%	CAD
Originator: Dwg No: GLAS-ARUP-70-XX-DR-X-9028	Originators Proj.Ref: 295280-00	
NG Investment No:	Sheet No: 28	Total No. of Sheets: 39
NG Dwg No:		Issue: C
Scale: 1:500		



- Notes:
1. Do not scale from this drawing.
 2. Drawing to be printed in colour.
 3. All dimensions in metres unless otherwise stated.
 4. All levels are in meters Above Ordnance Datum (mAOD)
 5. Existing ground model and utilities information based on survey MGS54157 dated 08/09/23 and undertaken by Murphy Geospatial, with additional data from subsequent GPR.

Legend:


Work site boundary

Existing Watercourse

Existing Fenceline

Existing Gate

Existing trees and vegetation

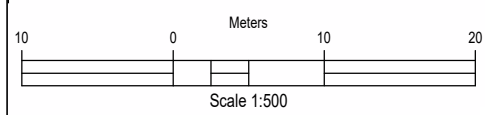

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Dwg Title:
Planning Drawings
Existing Site Plans
Sheet 29

Site: Glaslyn Cable Uprating

Originator
Dwg No: GLAS-ARUP-70-XX-DR-X-9029

NG Investment
No:

NG
Dwg No:

Scale: 1:500

Originators
Proj.Ref: 295280-00



Sheet No:
29

Total No.
of Sheets
39

Issue:
C

A1
100%

CAD

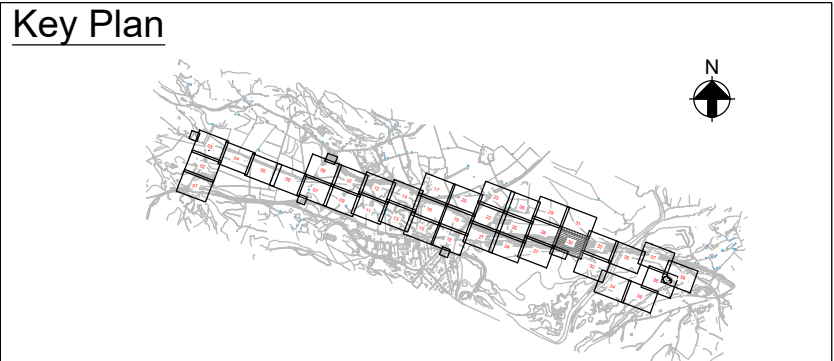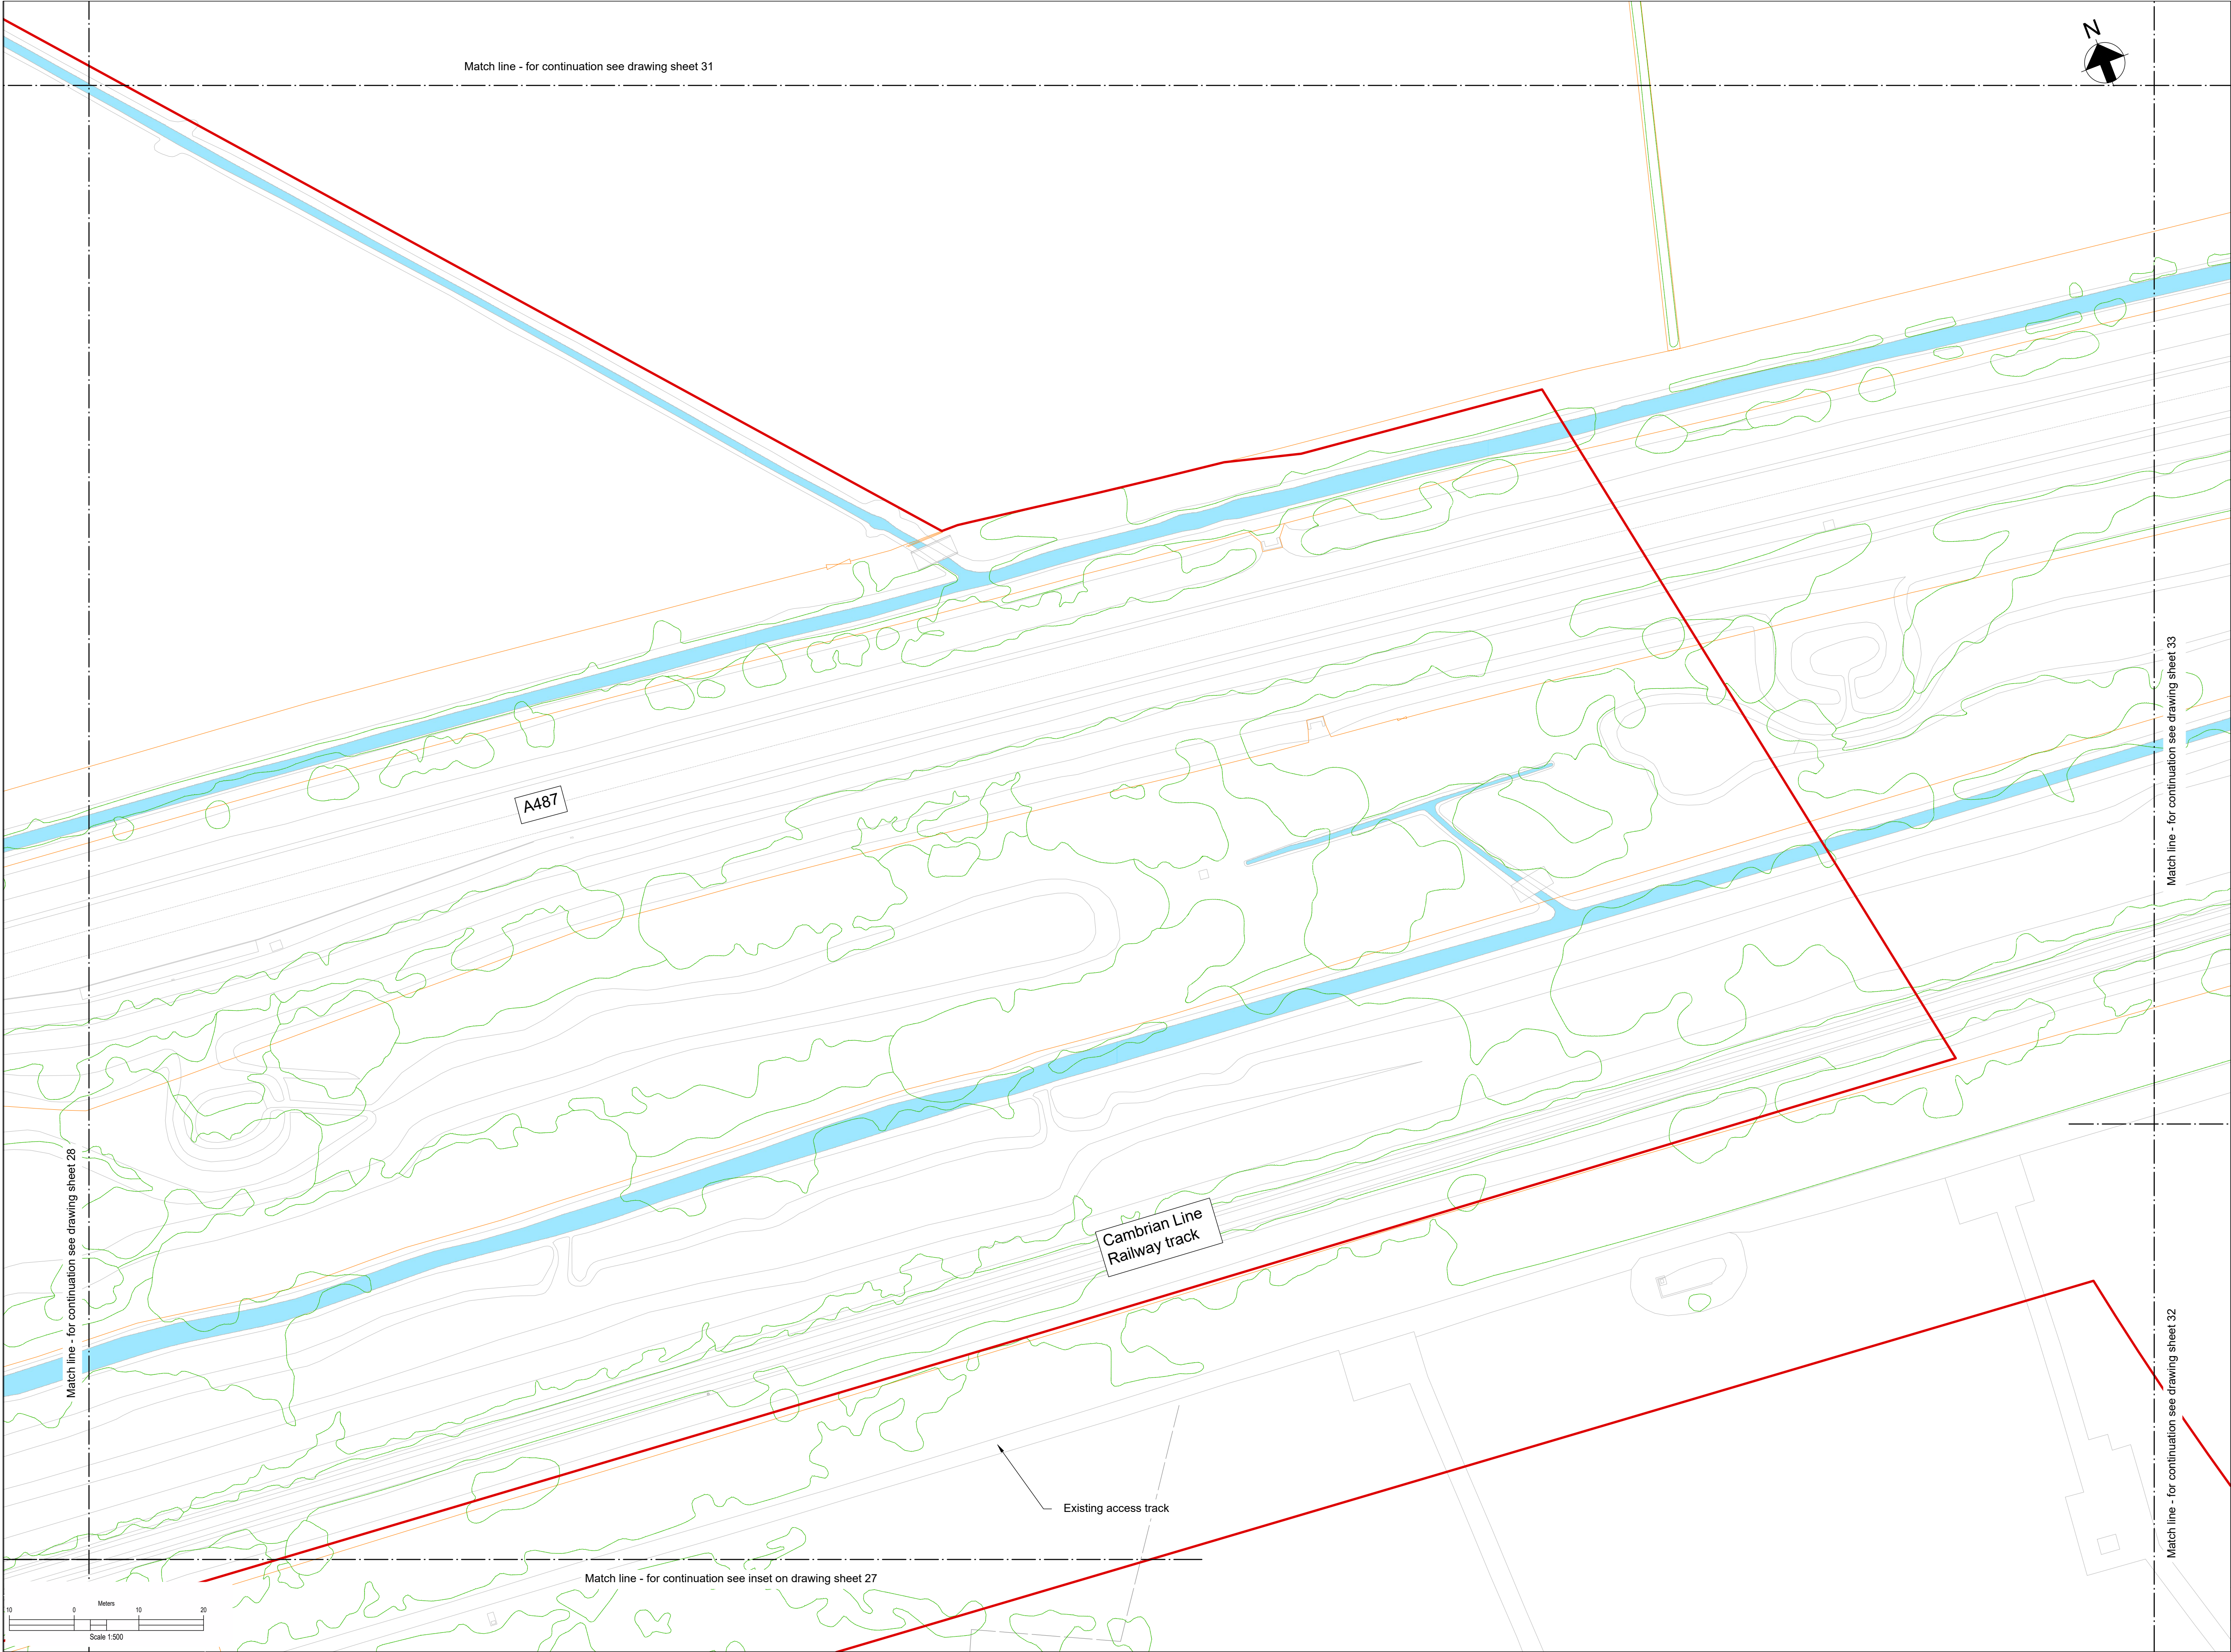

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 2. Drawing to be printed in colour.
 3. All dimensions in metres unless otherwise stated.
 4. All levels are in meters Above Ordnance Datum (mAOD)
 5. Existing ground model and utilities information based on survey MGS54157 dated 08/09/23 and undertaken by Murphy Geospatial, with additional data from subsequent GPR.

- Legend:**
- Work site boundary
 - Existing Watercourse
 - Existing Fenceline
 - Existing Gate
 - Existing trees and vegetation

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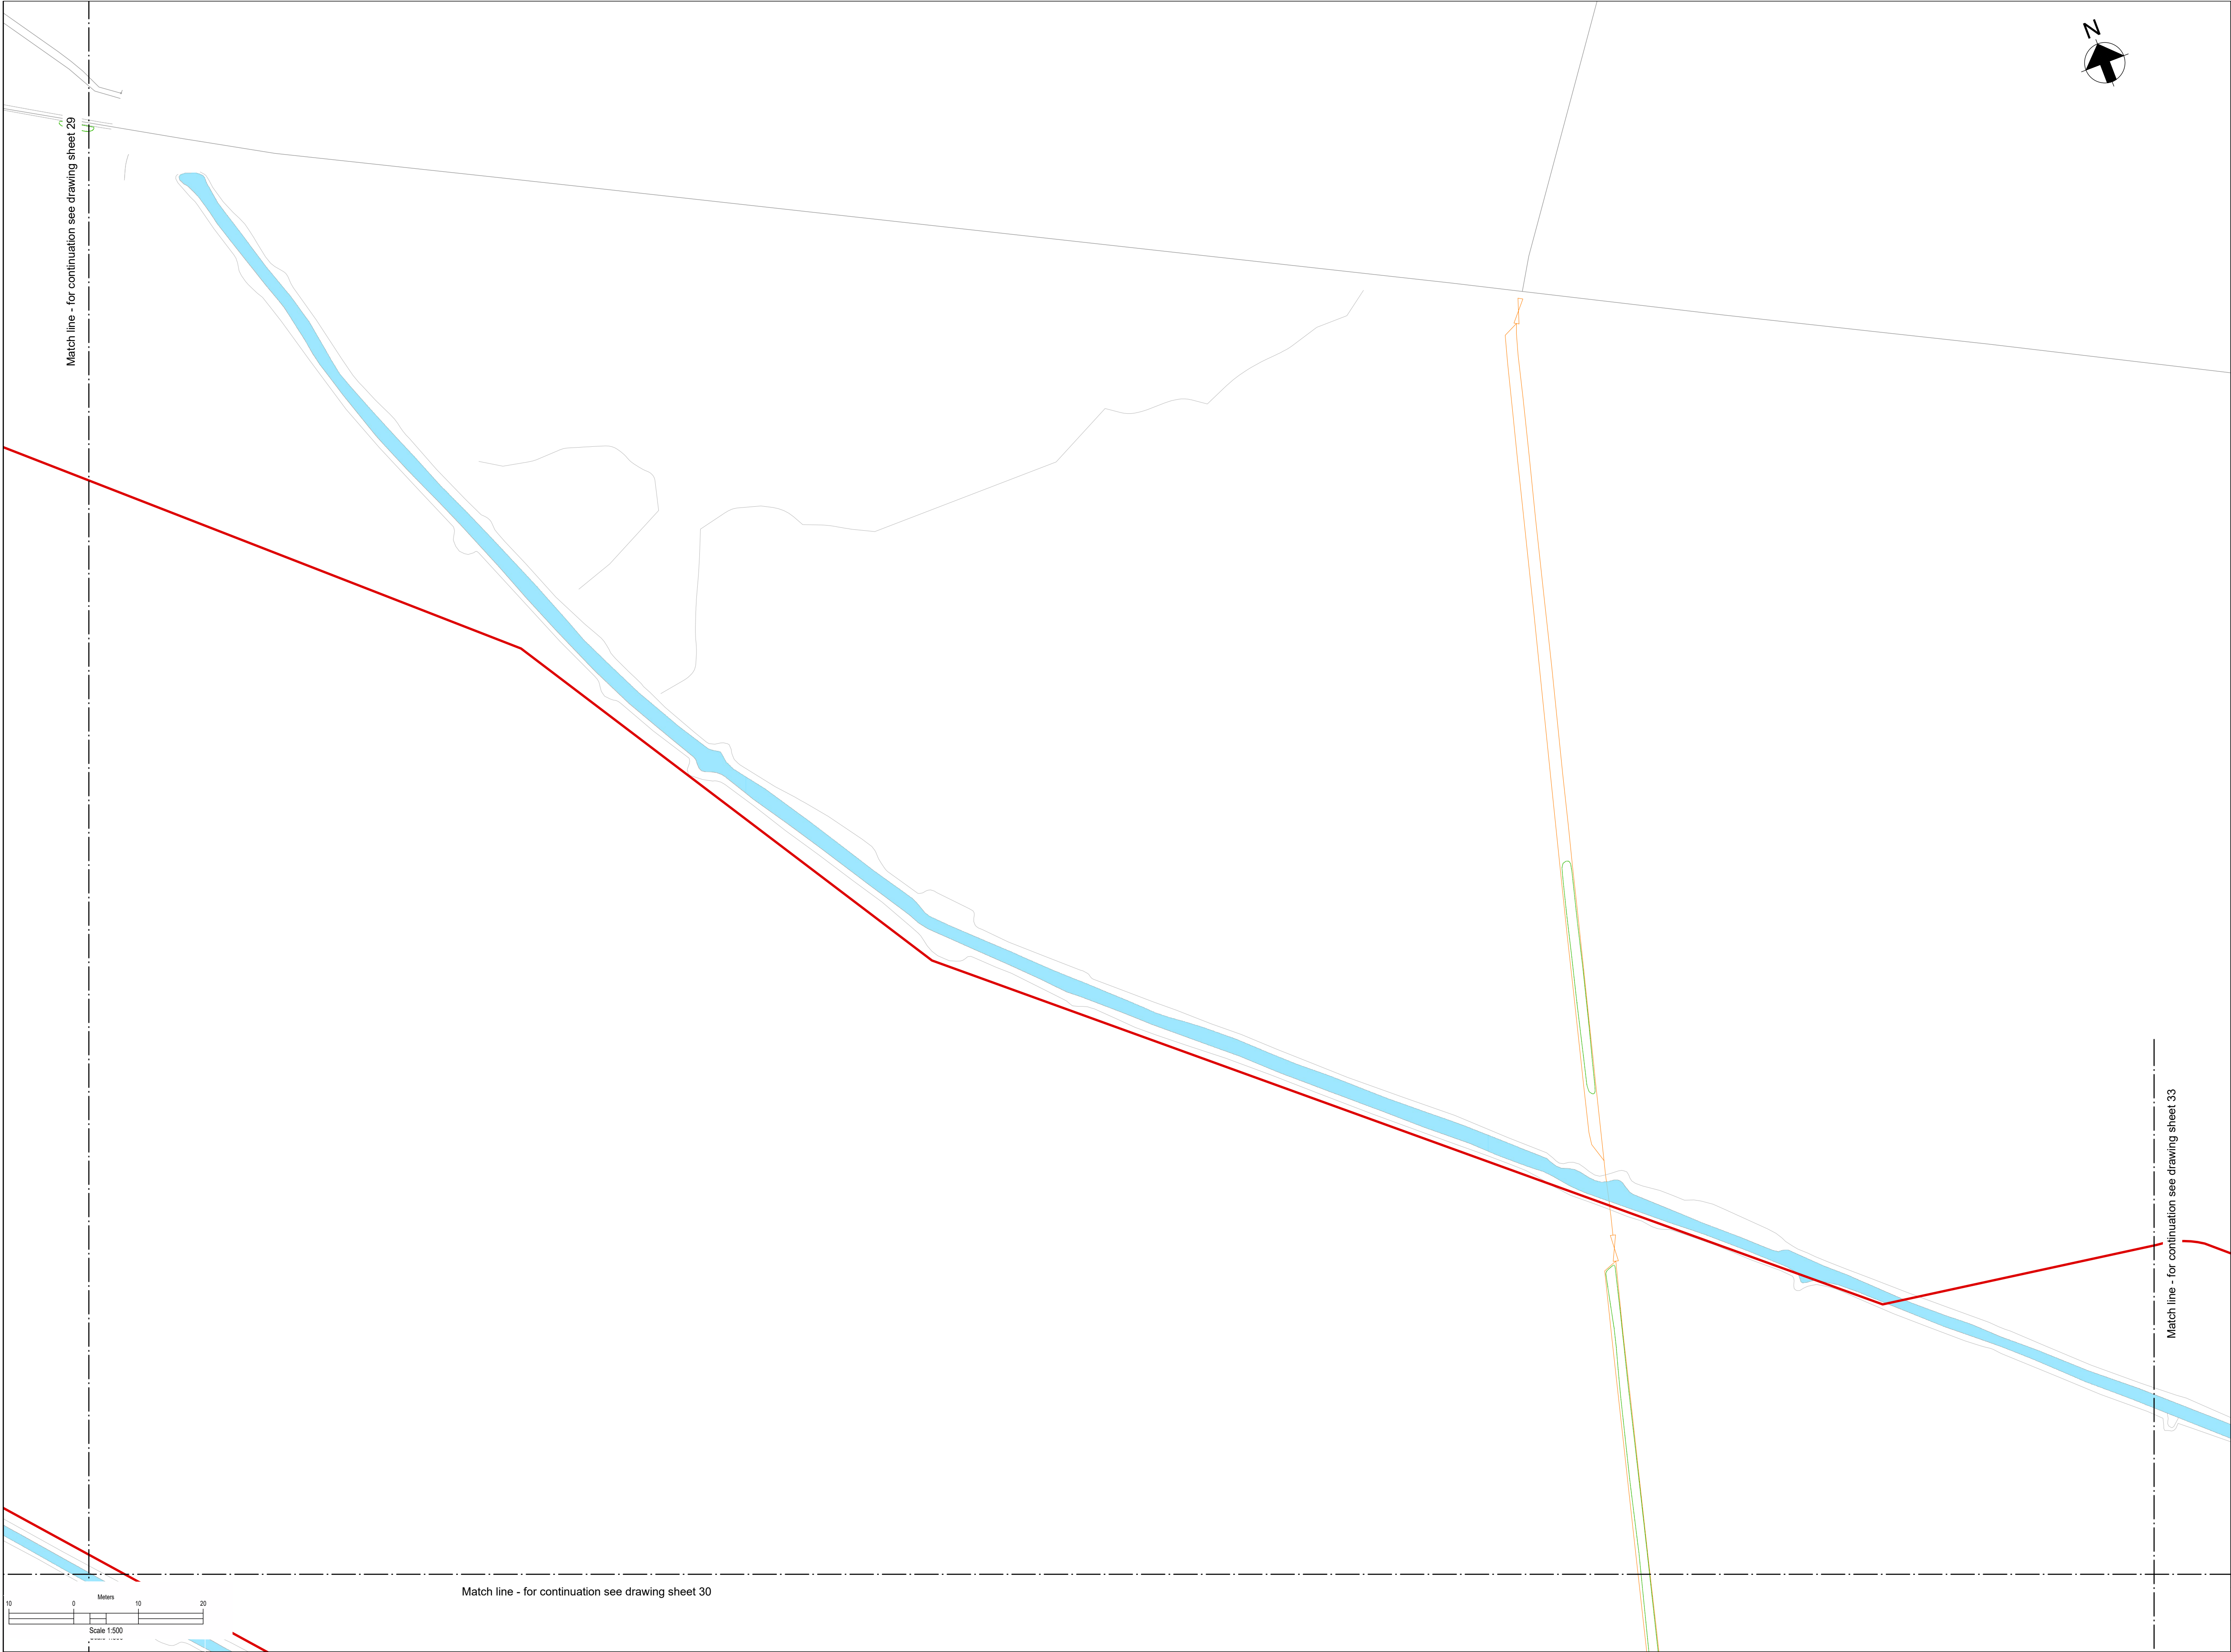
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Dwg Title:
Planning Drawings
Existing Site Plans
Sheet 30

Site: Glaslyn Cable Uprating	A1 100%	CAD
Originator: Dwg No: GLAS-ARUP-70-XX-DR-X-9030	Originators Proj.Ref: 295280-00	
NG Investment	Sheet No:	Total No. of Sheets
NG Dwg No:	30	39
Scale: 1:500		Issue: C



Key Plan

Notes:

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- All dimensions in metres unless otherwise stated.
- All levels are in meters Above Ordnance Datum (mAOD)
- Existing ground model and utilities information based on survey MGS54157 dated 08/09/23 and undertaken by Murphy Geospatial, with additional data from subsequent GPR.

Legend:


Work site boundary

Existing Watercourse

Existing Fenceline

Existing Gate


Existing trees and vegetation

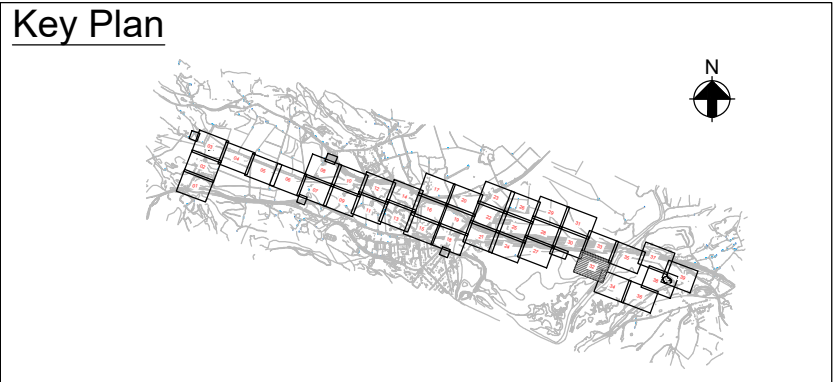

- Notes:**
1. Do not scale from this drawing.
 2. Drawing to be printed in colour.
 3. All dimensions in metres unless otherwise stated.
 4. All levels are in meters Above Ordnance Datum (mAOD)
 5. Existing ground model and utilities information based on survey MGS54157 dated 08/09/23 and undertaken by Murphy Geospatial, with additional data from subsequent GPR.

Legend:

- Work site boundary
- Existing Watercourse
- Existing Fenceline
- Existing Gate
- Existing trees and vegetation

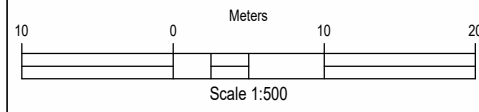

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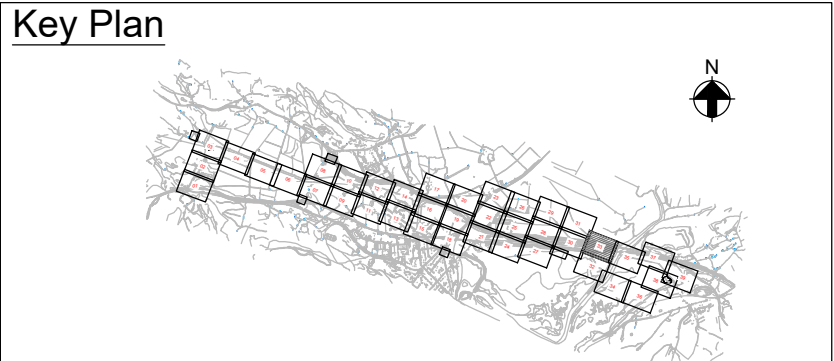
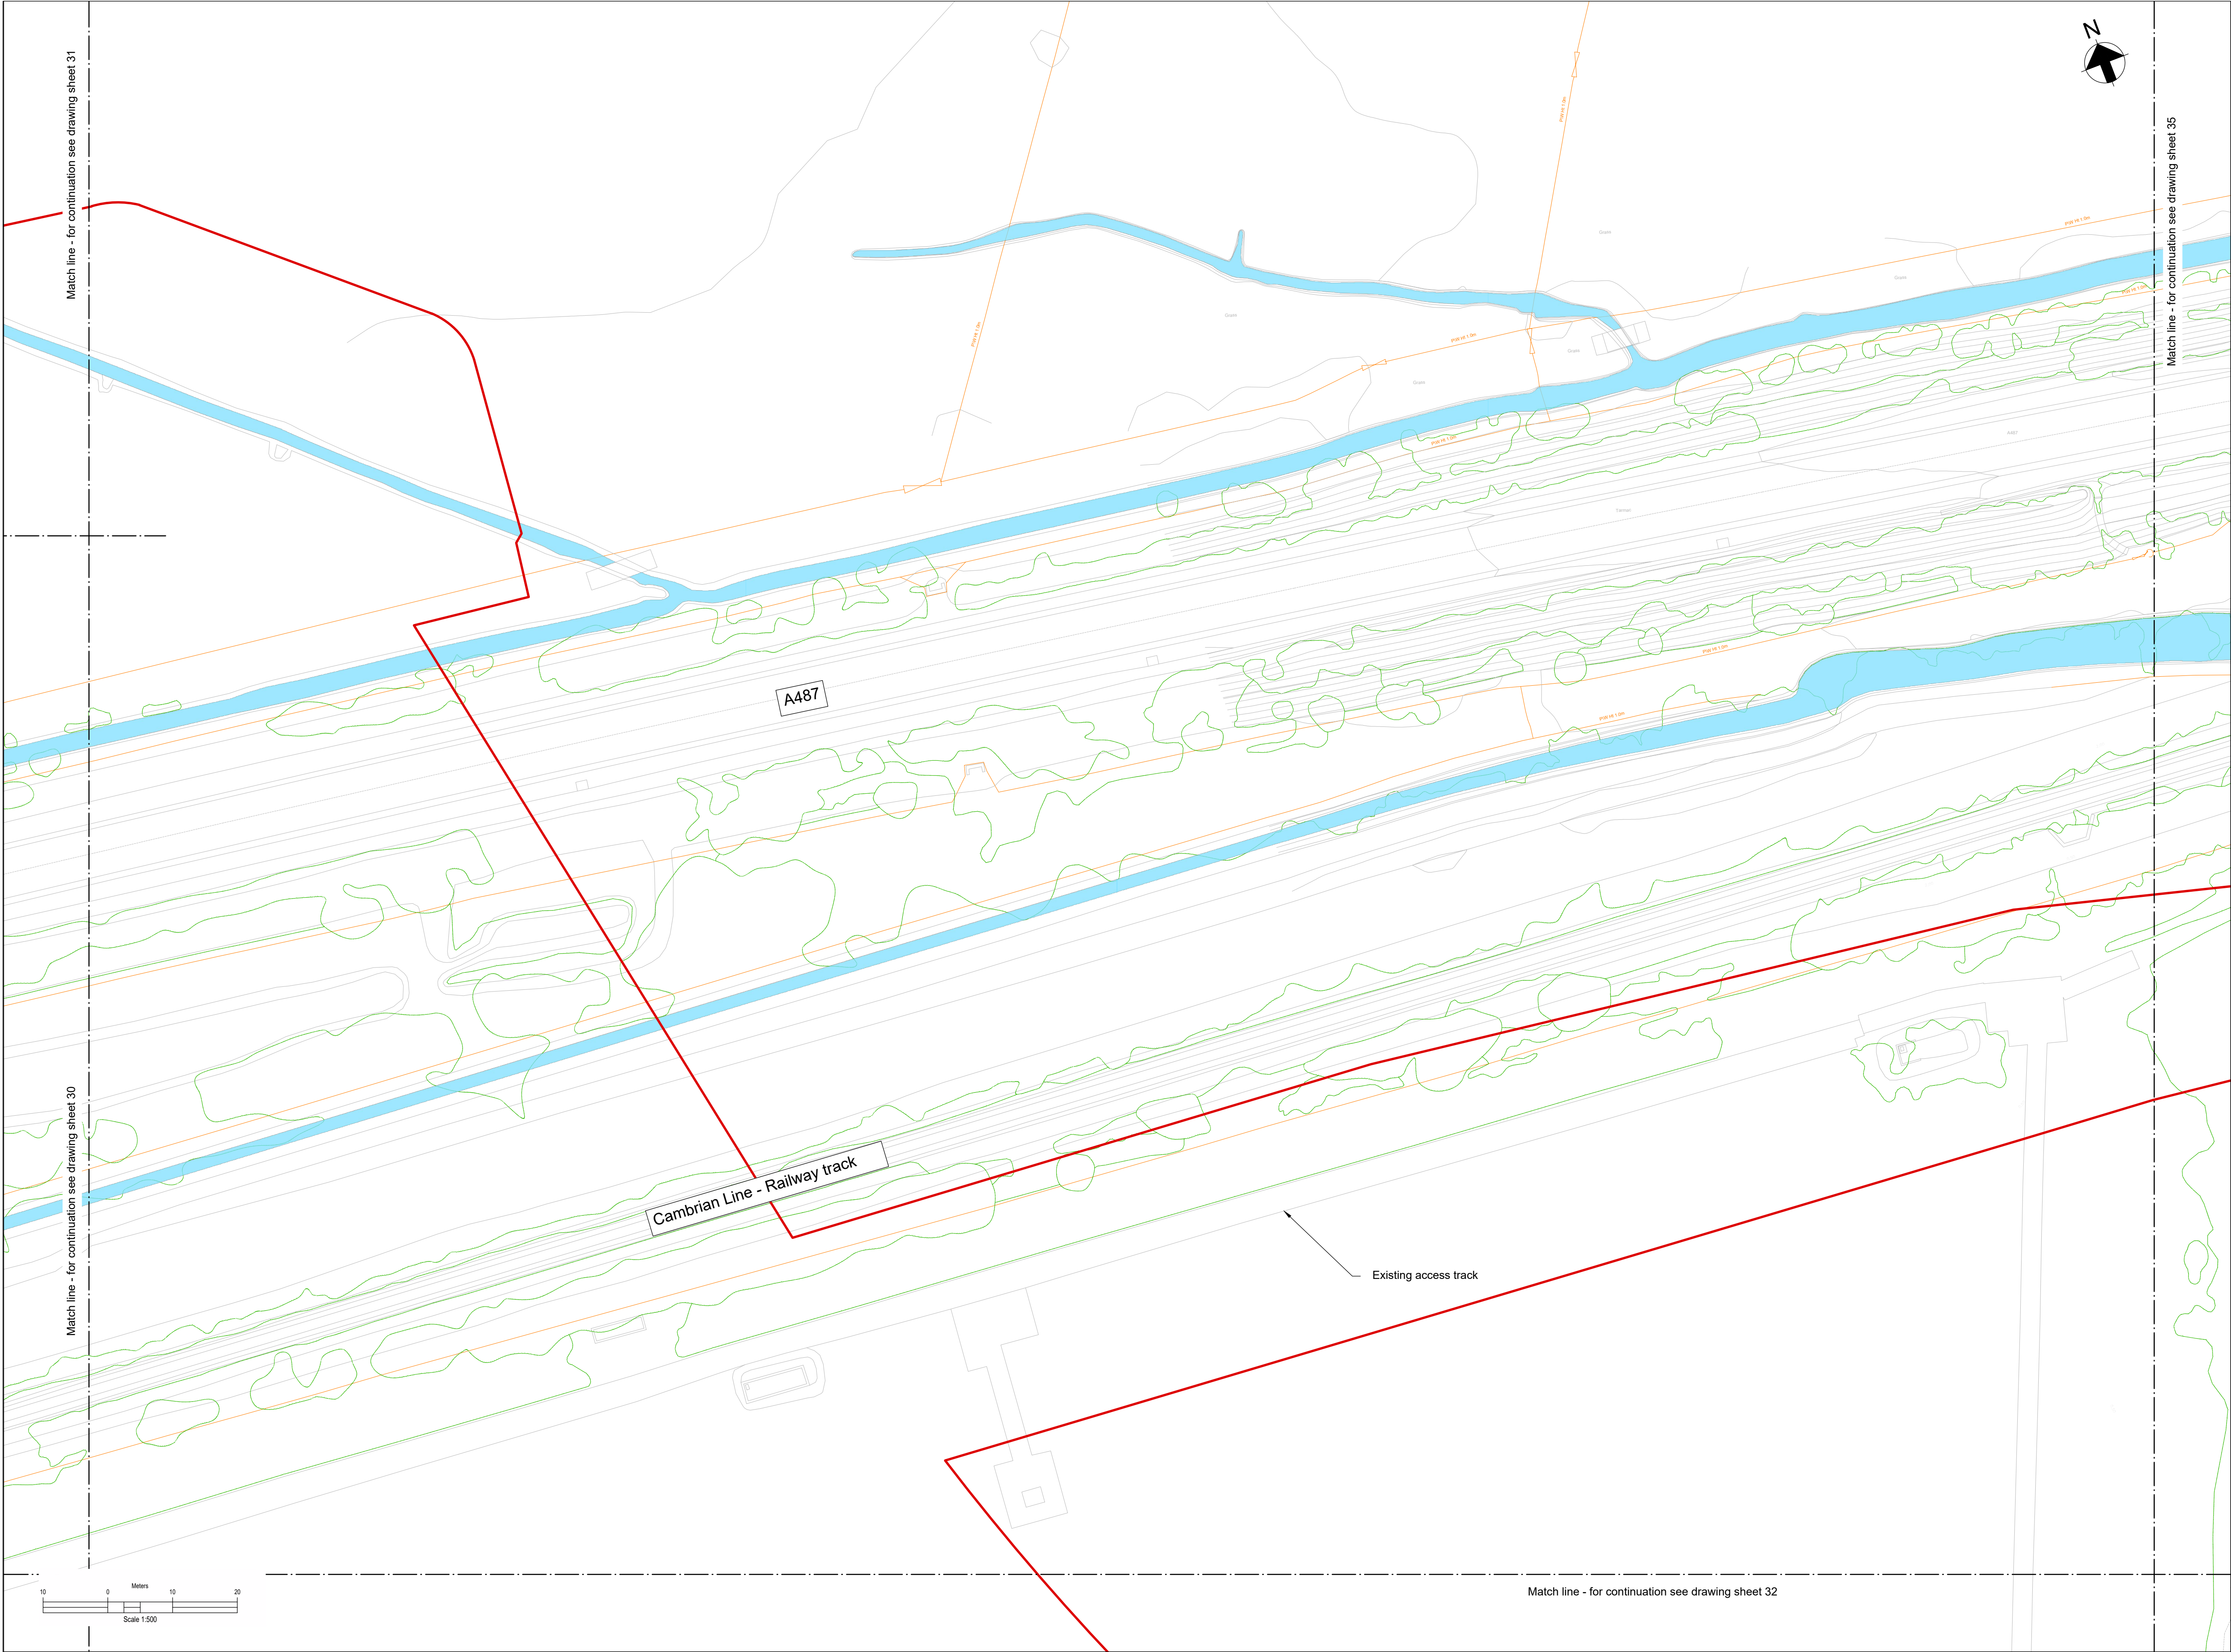
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Dwg Title:
**Planning Drawings
Existing Site Plans
Sheet 32**

Site: Glaslyn Cable Uprating	A1 100%	CAD
Originator Dwg No: GLAS-ARUP-70-XX-DR-X-9032	Originators Proj.Ref: 295280-00	
NG Investment No:	Sheet No:	Total No. of Sheets
NG Dwg No:	32	39
Scale: 1:500		Issue: C



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 3. All dimensions in metres unless otherwise stated.
 4. All levels are in meters Above Ordnance Datum (mAOD)
 5. Existing ground model and utilities information based on survey MGS54157 dated 08/09/23 and undertaken by Murphy Geospatial, with additional data from subsequent GPR.

- Legend:**
- Work site boundary
 - Existing Watercourse
 - Existing Fenceline
 - Existing Gate
 - Existing trees and vegetation

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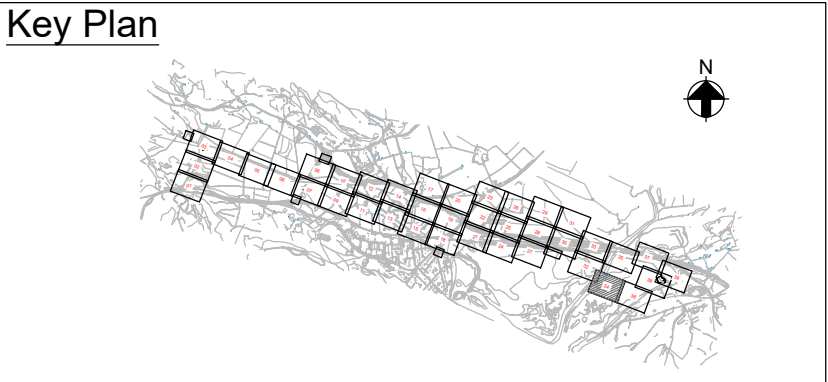
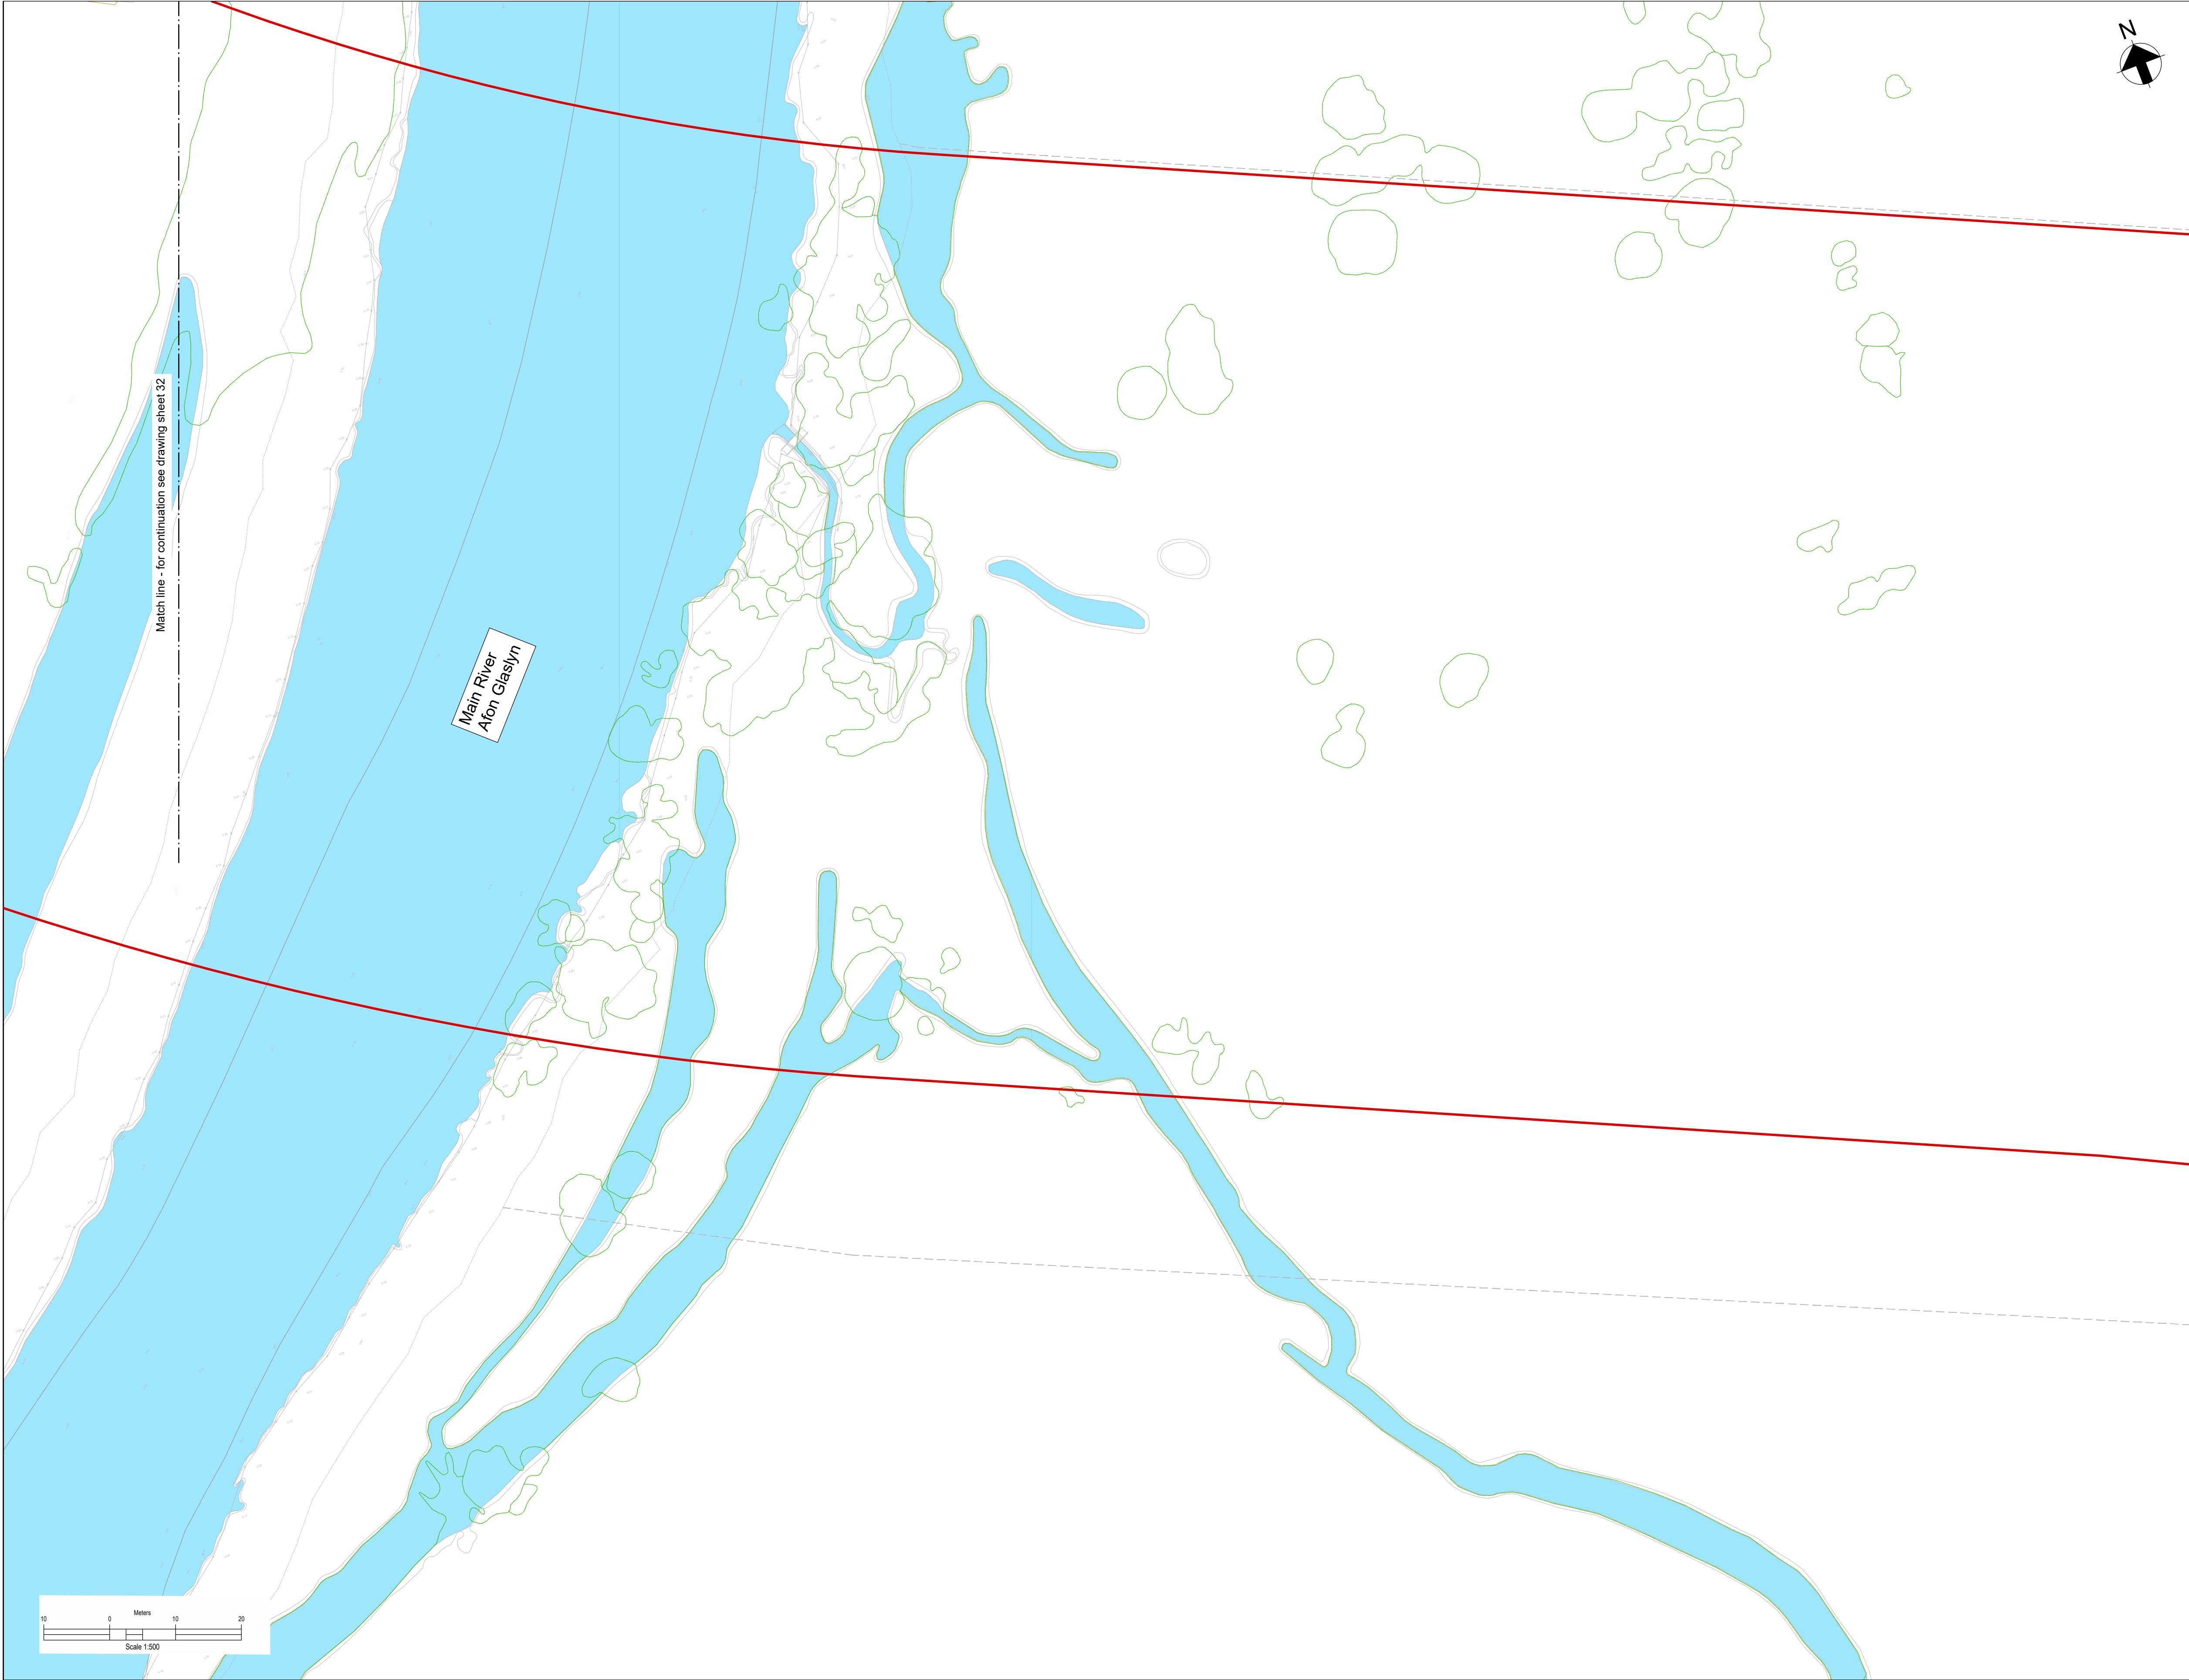
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Dwg Title:
**Planning Drawings
Existing Site Plans
Sheet 33**

Site: Glaslyn Cable Uprating	A1 100%	CAD
Originator: Dwg No: GLAS-ARUP-70-XX-DR-X-9033	Originators Proj.Ref: 295280-00	
NG Investment No:	Sheet No: 33	Total No. of Sheets 39
NG Dwg No:		Issue: C
Scale: 1:500		



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 3. All dimensions in metres unless otherwise stated.
 4. All levels are in meters Above Ordnance Datum (mAOD)
 5. Existing ground model and utilities information based on survey MGS54157 dated 08/09/23 and undertaken by Murphy Geospatial, with additional data from subsequent GPR.

Legend:

Work site boundary

Existing Watercourse

Existing Fenceline

Existing Gate

Existing trees and vegetation

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Dwg Title:
Planning Drawings
Existing Site Plans
Sheet 34

Site: Glaslyn Cable Uprating		A1 100%	CAD	
Originator: Dwg No: GLAS-ARUP-70-XX-DR-X-9034	Originators Proj.Ref: 295280-00			
NG Investment		Sheet No: 34	Total No. of Sheets 39	Issue: C
NG Dwg No:				
Scale: 1:500				

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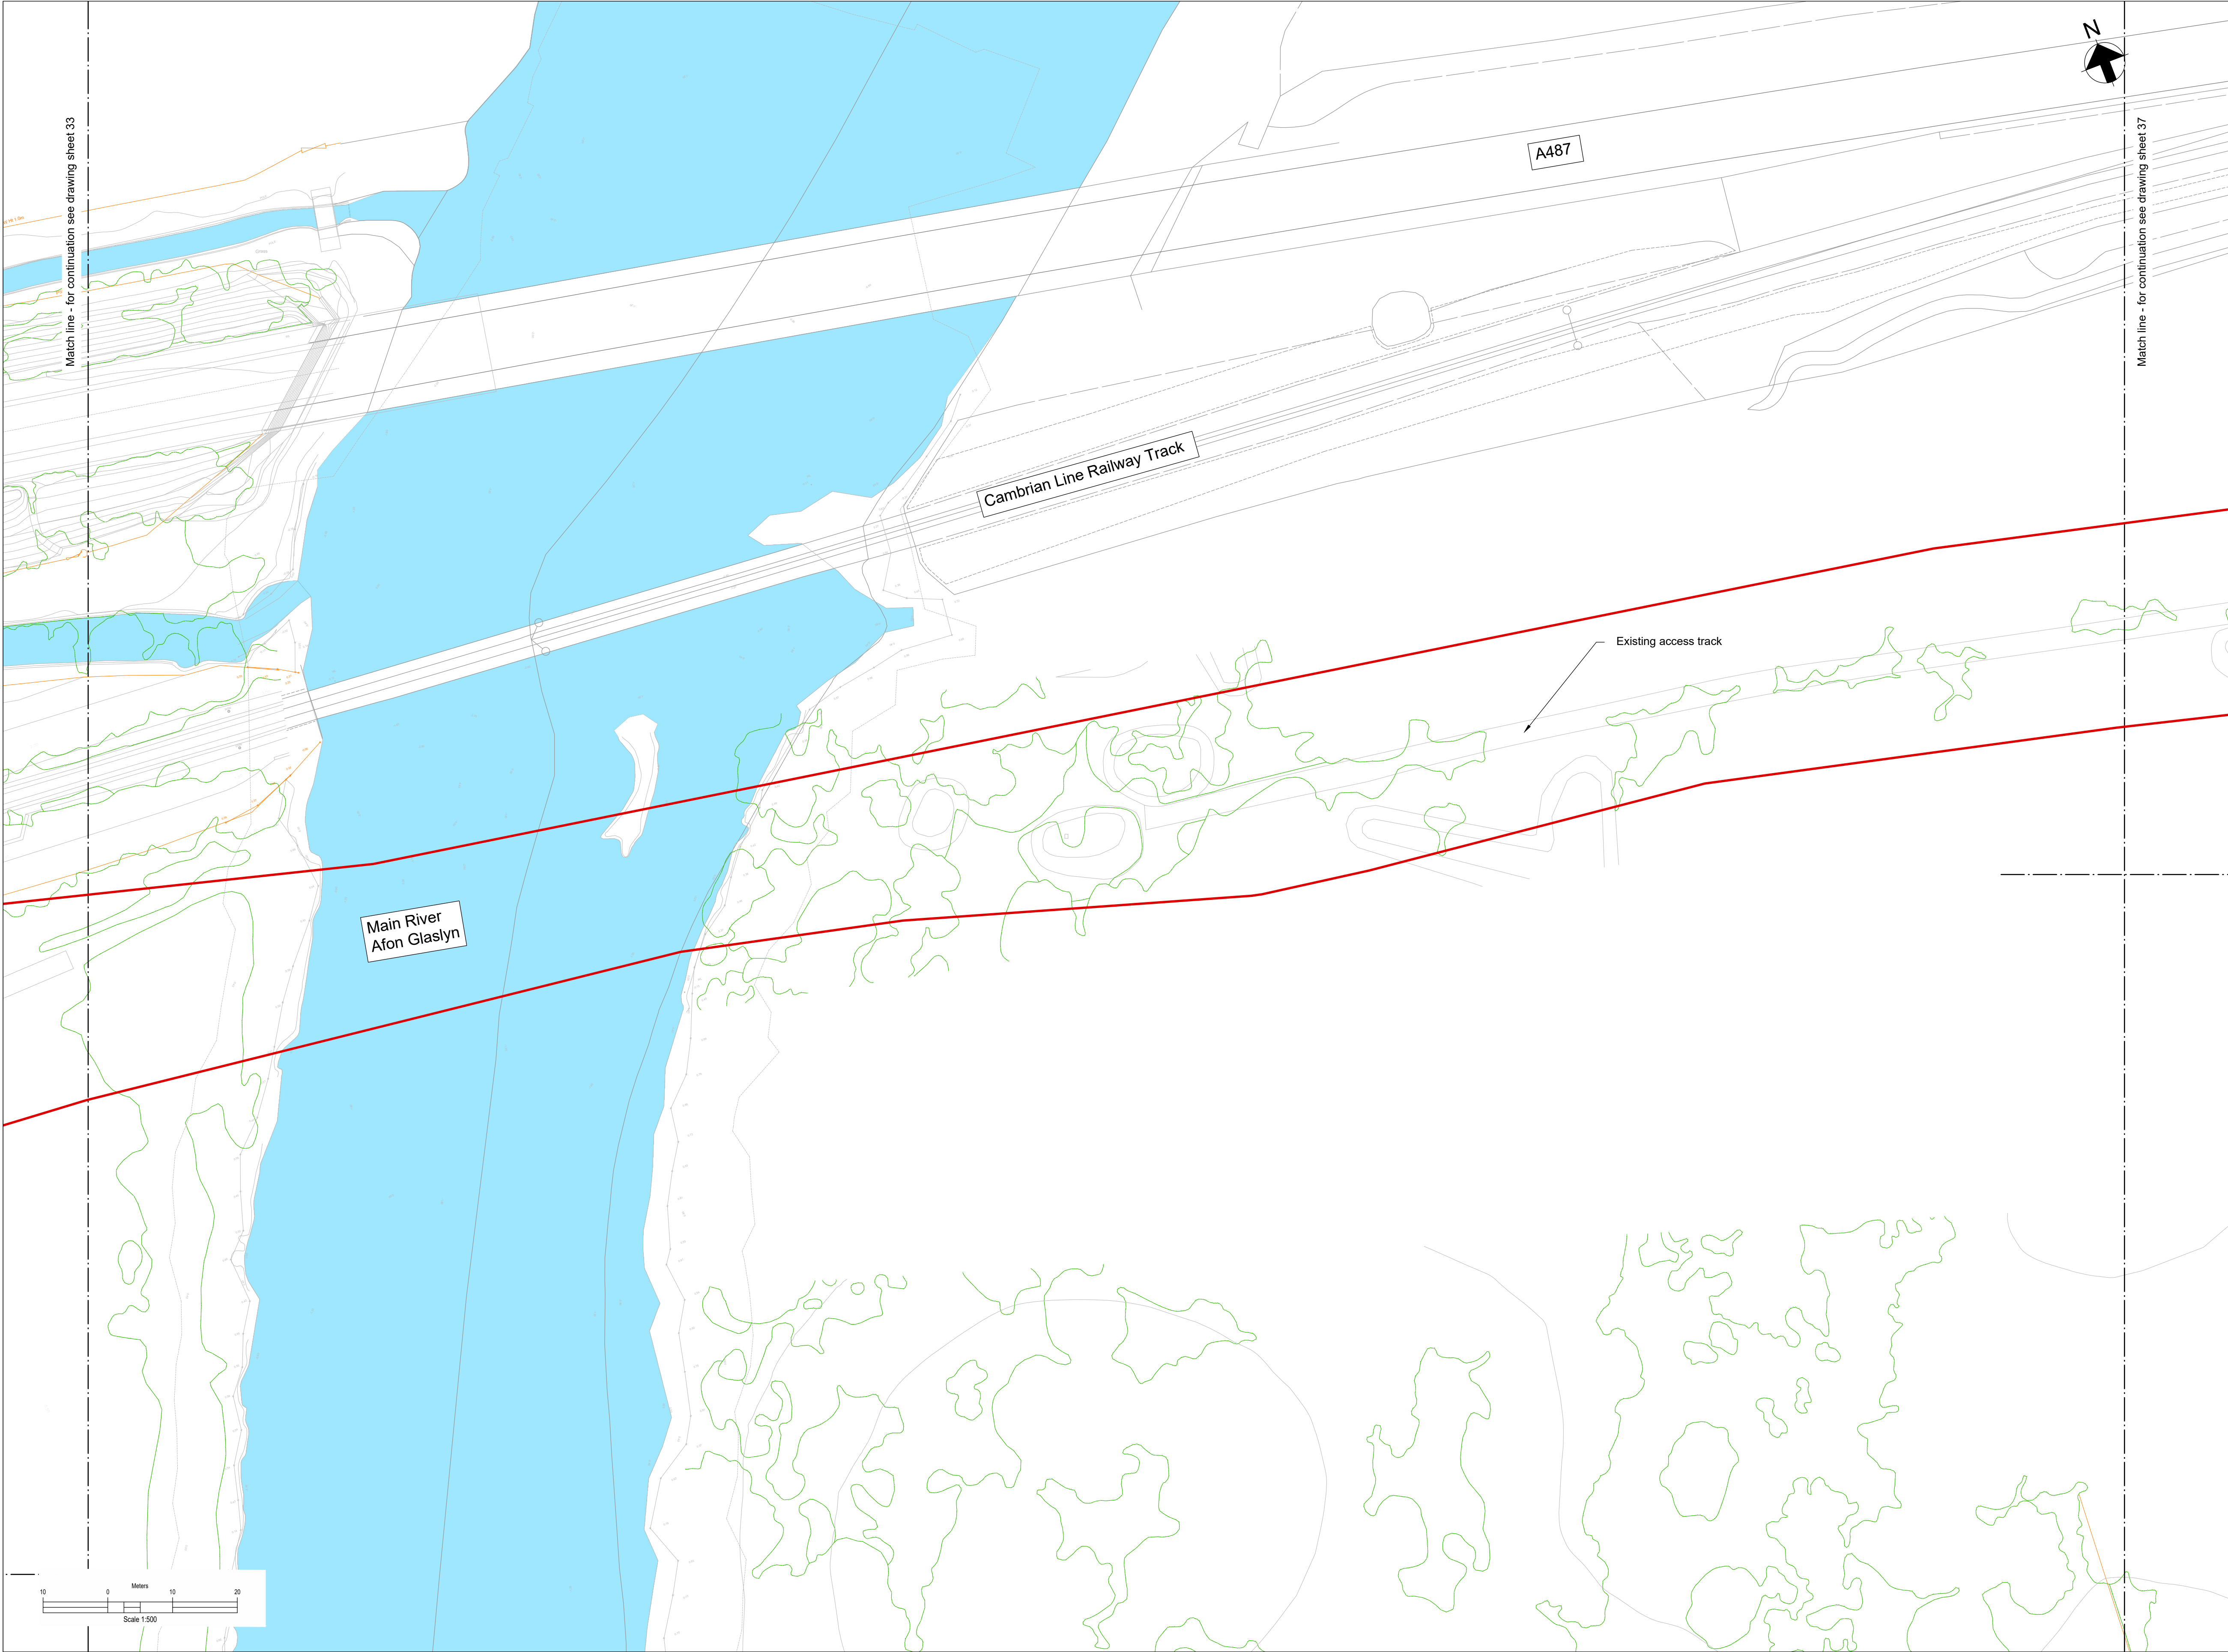
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Notes:

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Legend:

Work site boundary

Existing Watercourse

Existing Fenceline



Existing Gate

Existing trees and vegetation

Scale


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Scale 1:500

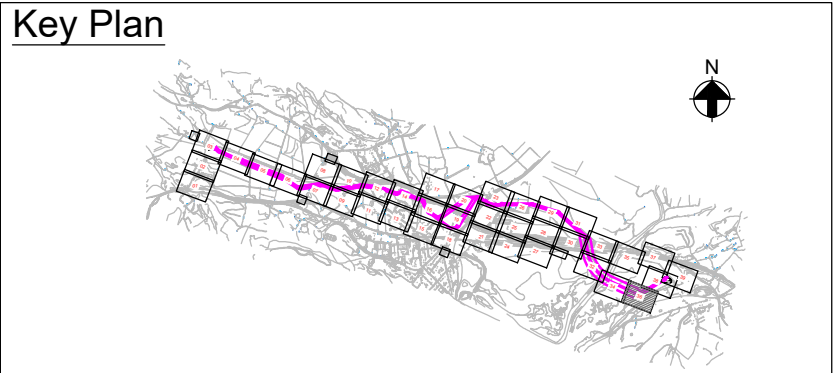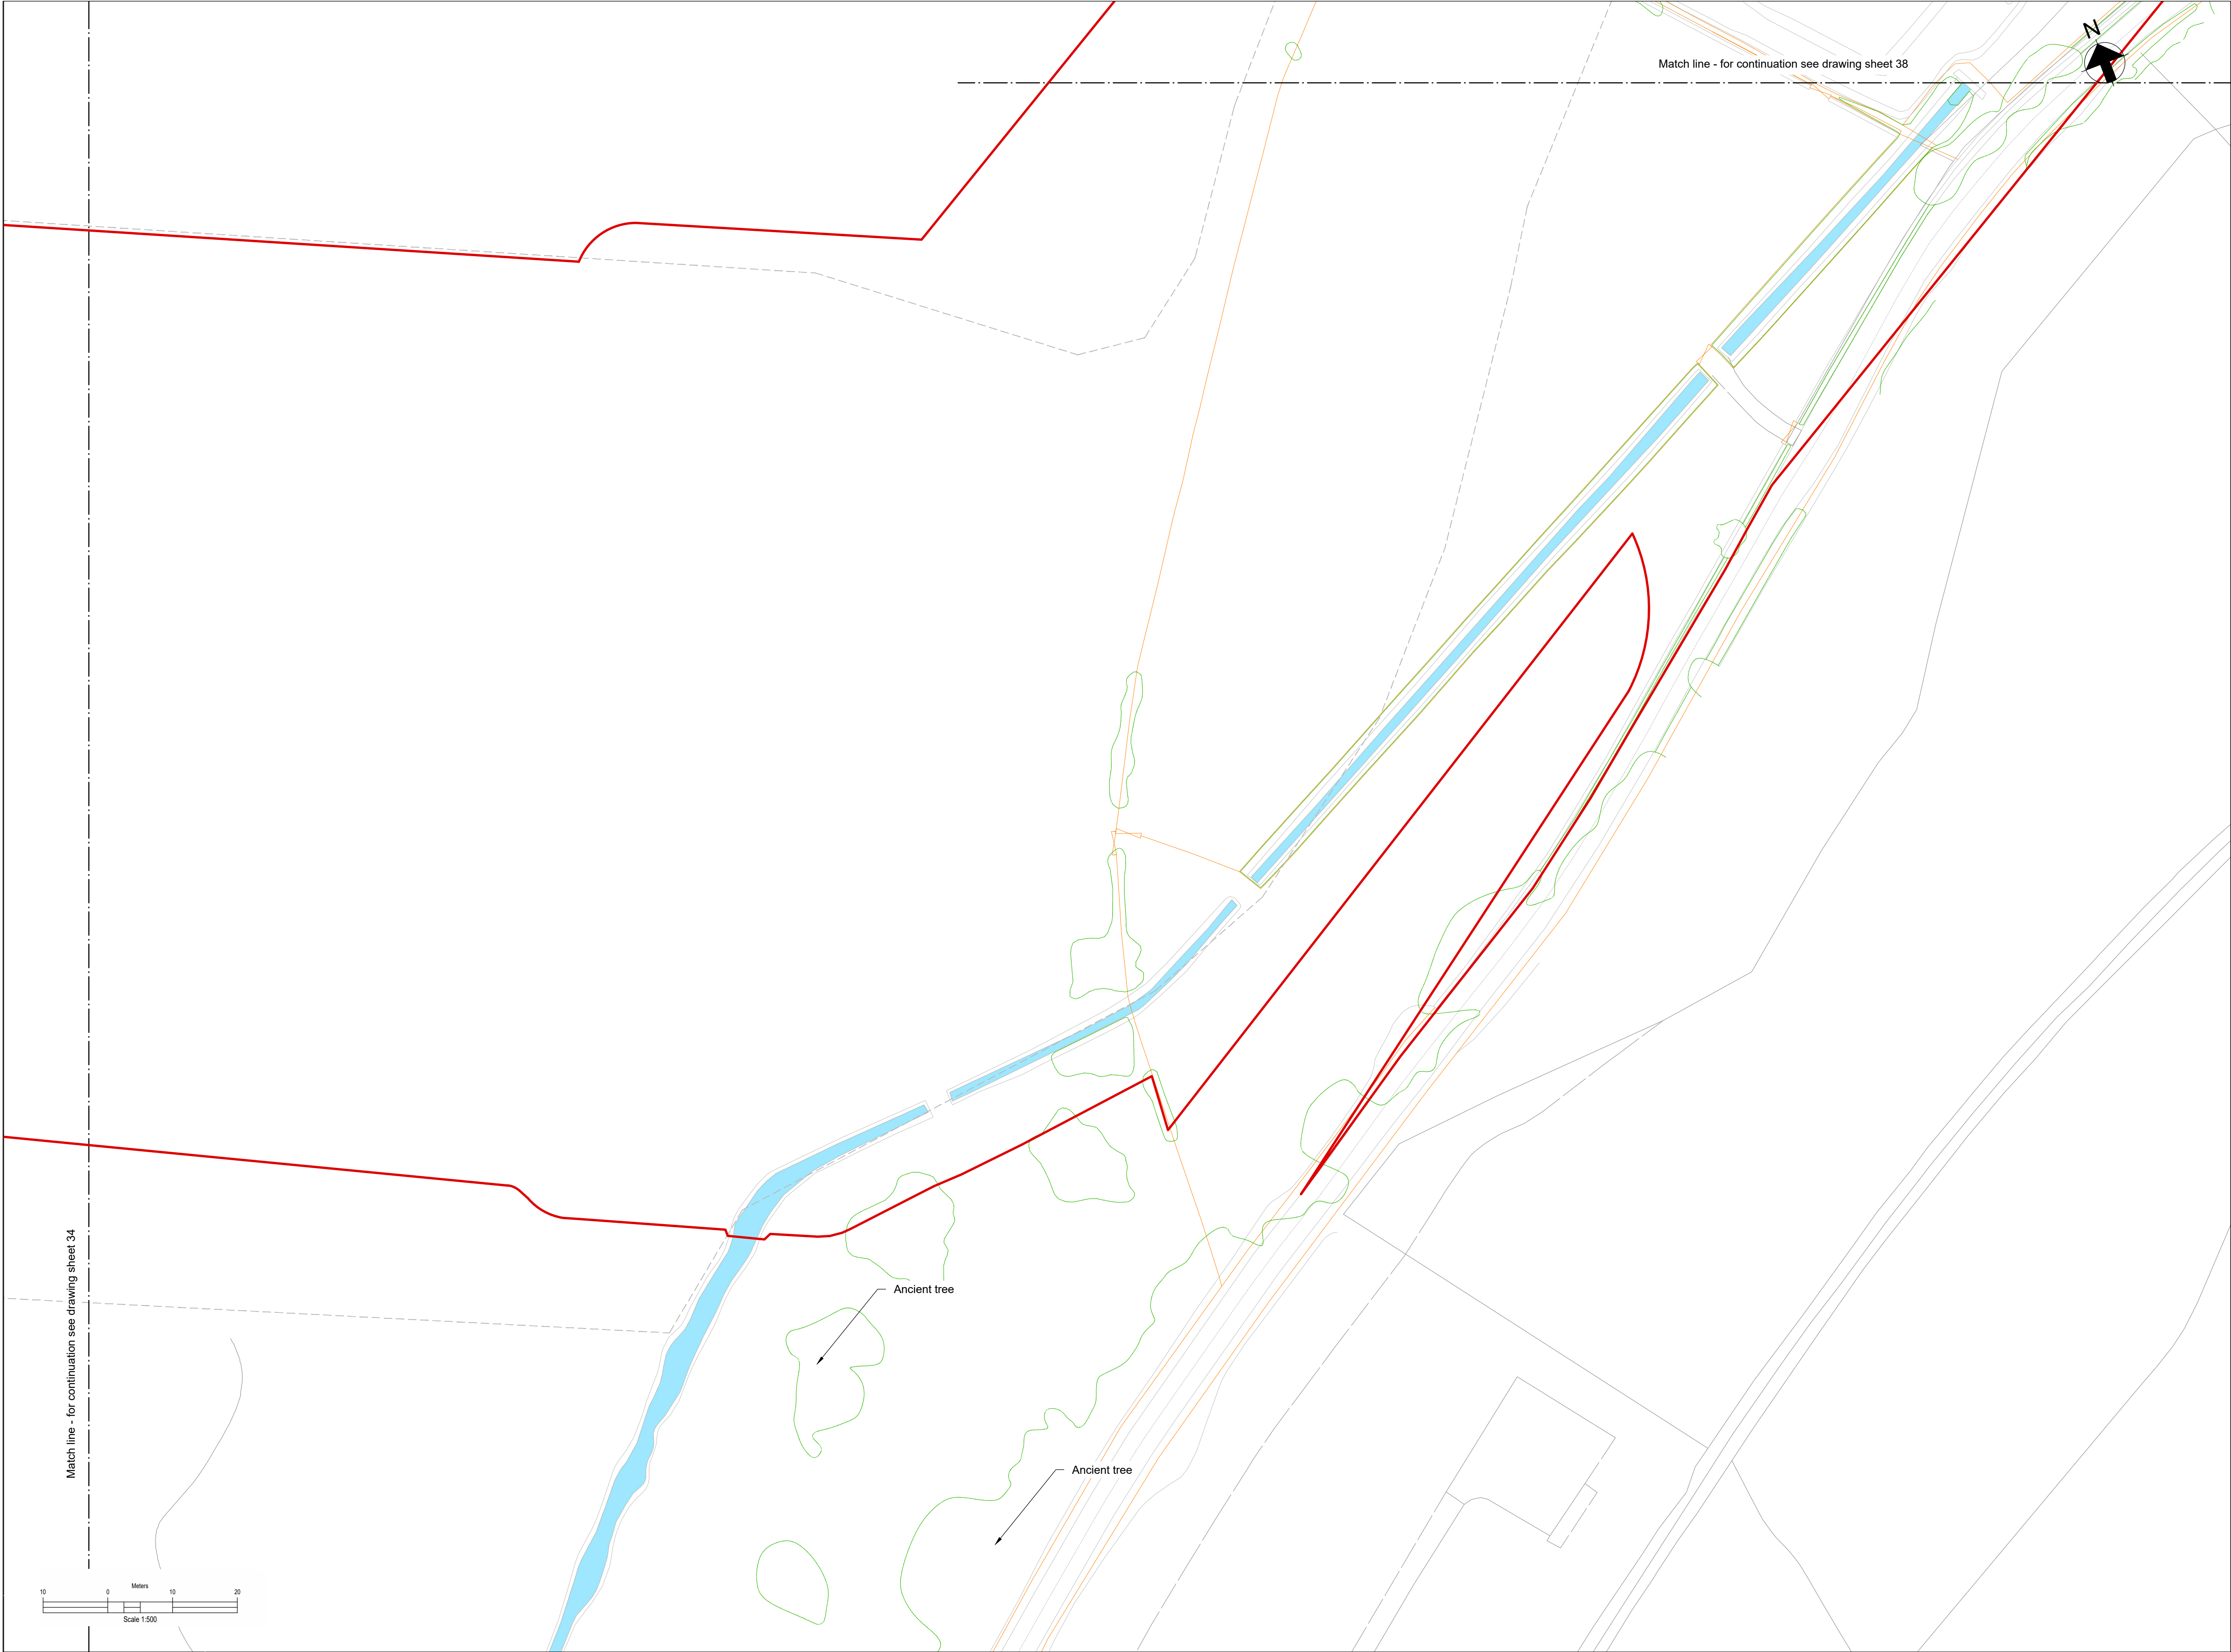


- Notes:**
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
- Legend:**
- Work site boundary
 - Existing Watercourse
 - Existing Fenceline
 - Existing Gate
 - Existing trees and vegetation



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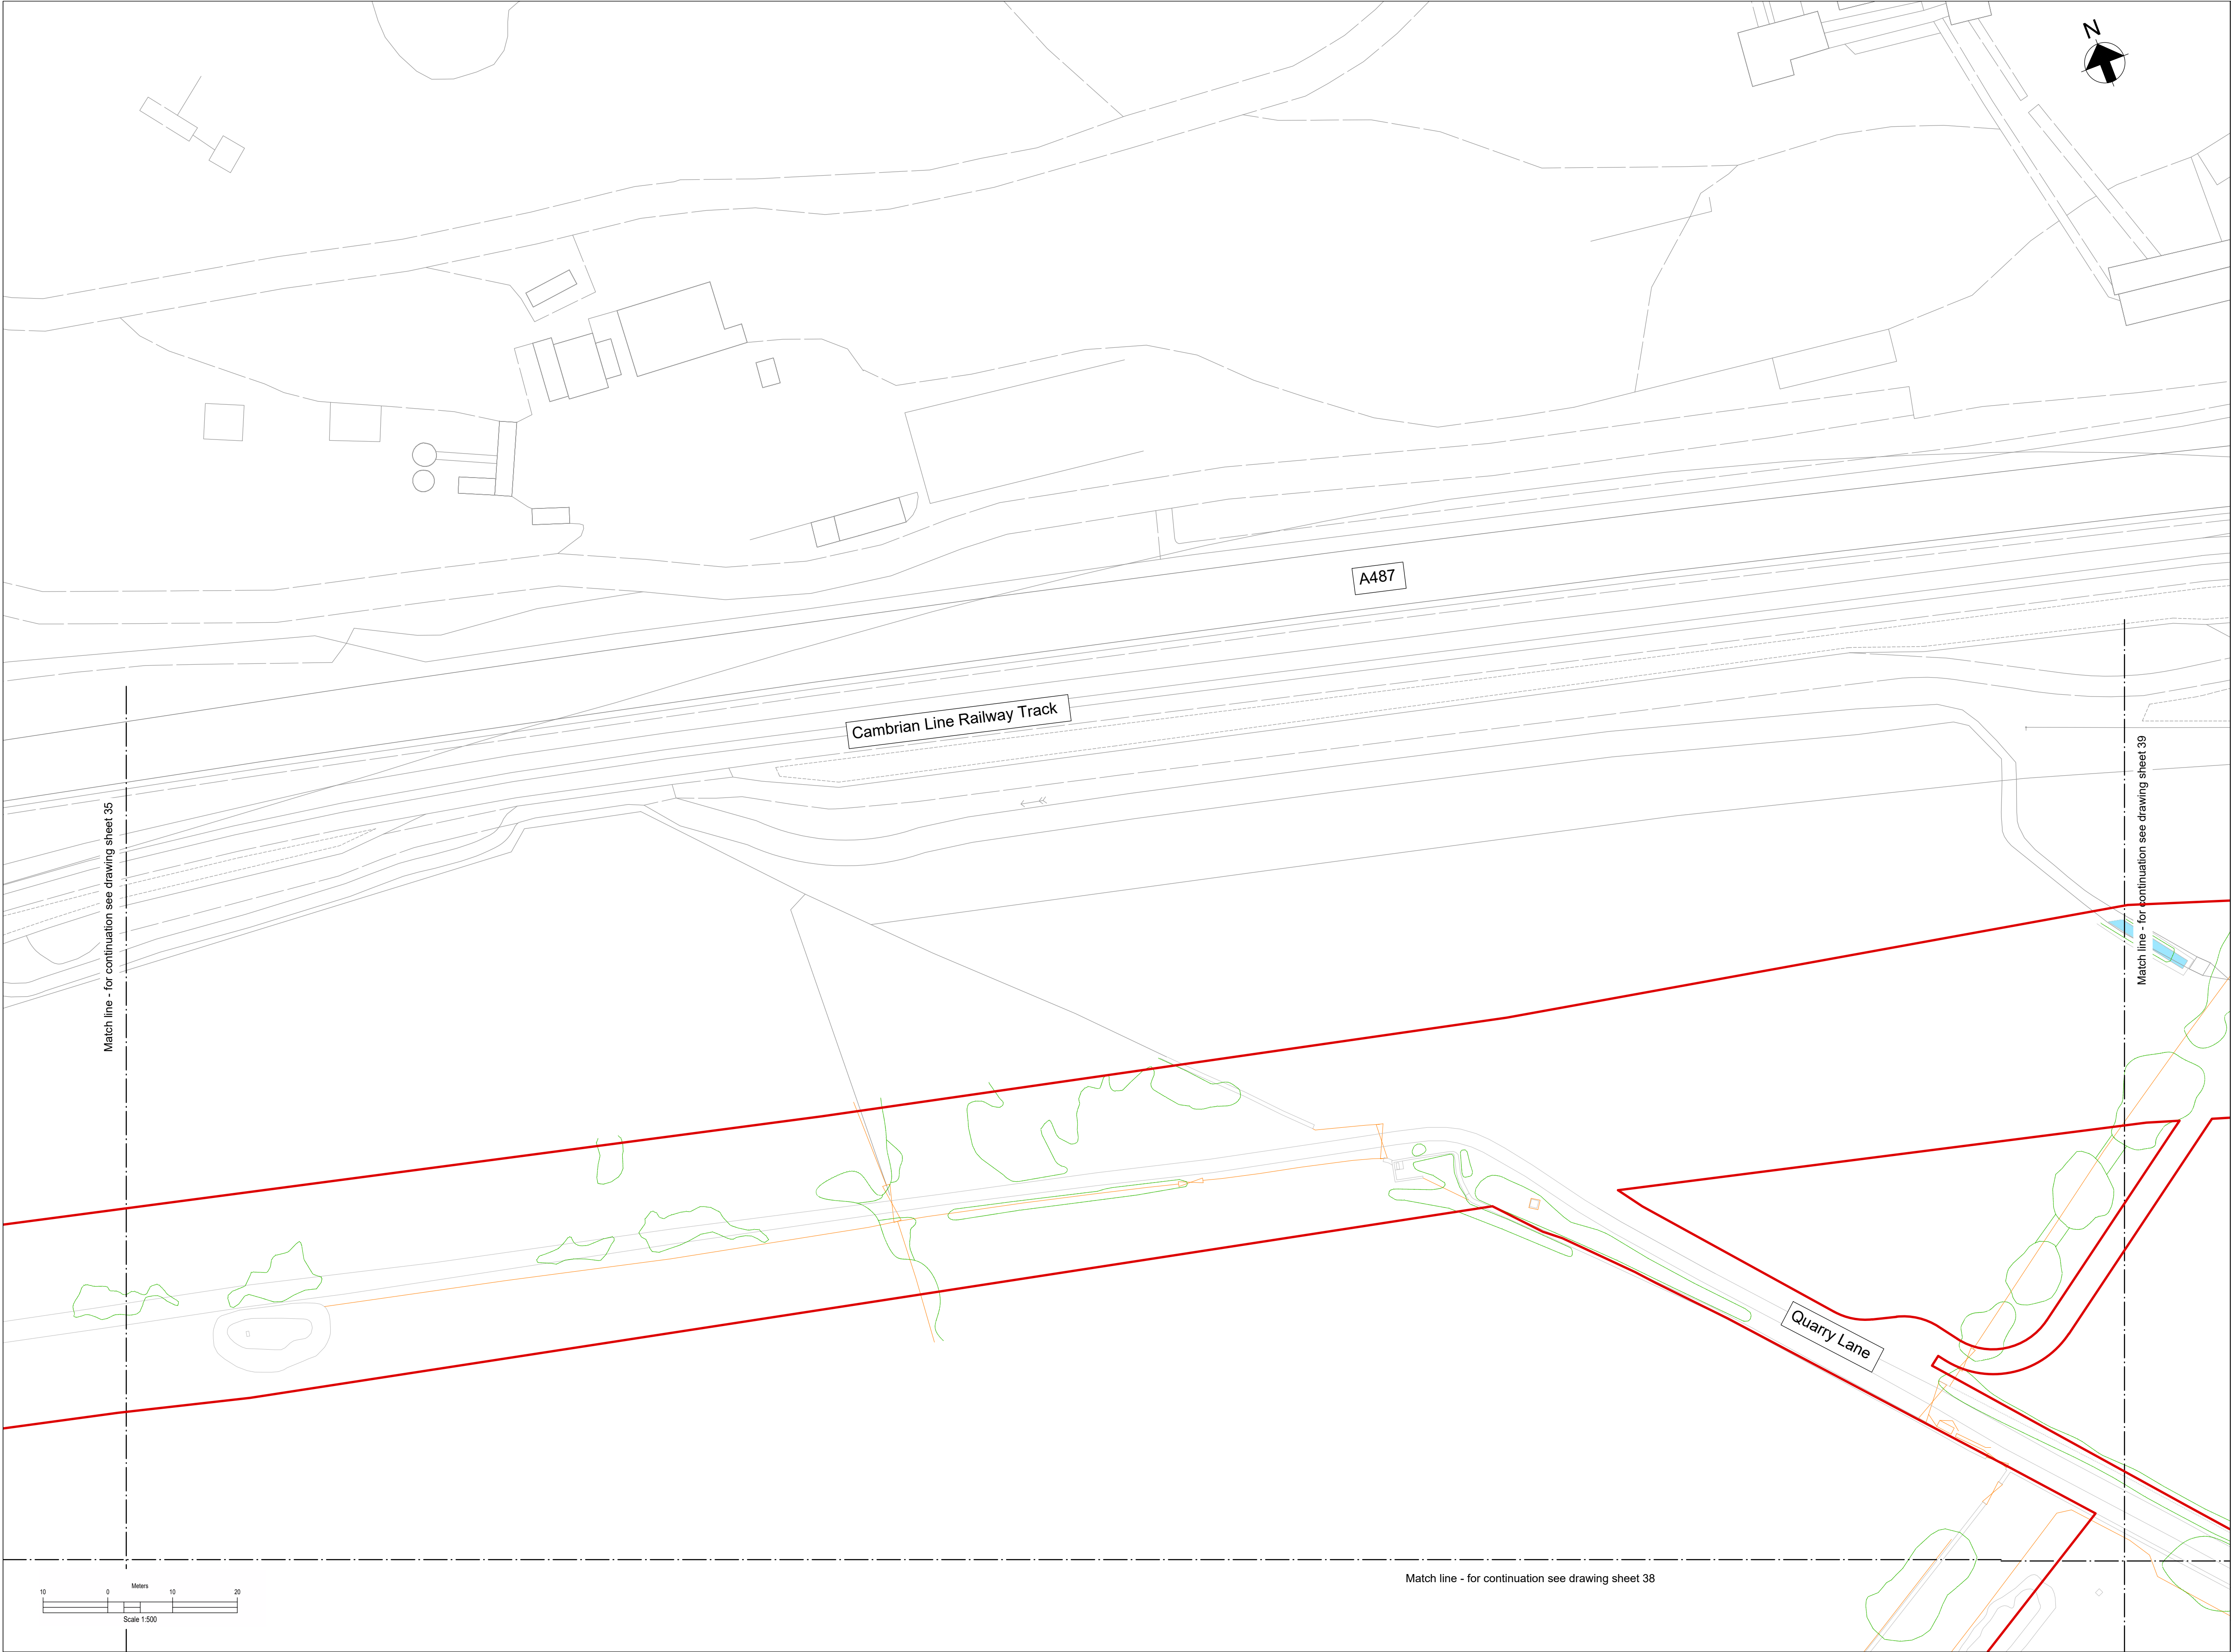
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Dwg Title:
**Planning Drawings
Existing Site Plans
Sheet 36**

Site: Glaslyn Cable Uprating	A1 100%	CAD
Originator: Dwg No: GLAS-ARUP-70-XX-DR-X-9036	Originators Proj.Ref: 295280-00	
NG Investment No:	Sheet No:	Total No. of Sheets
NG Dwg No:	36	39
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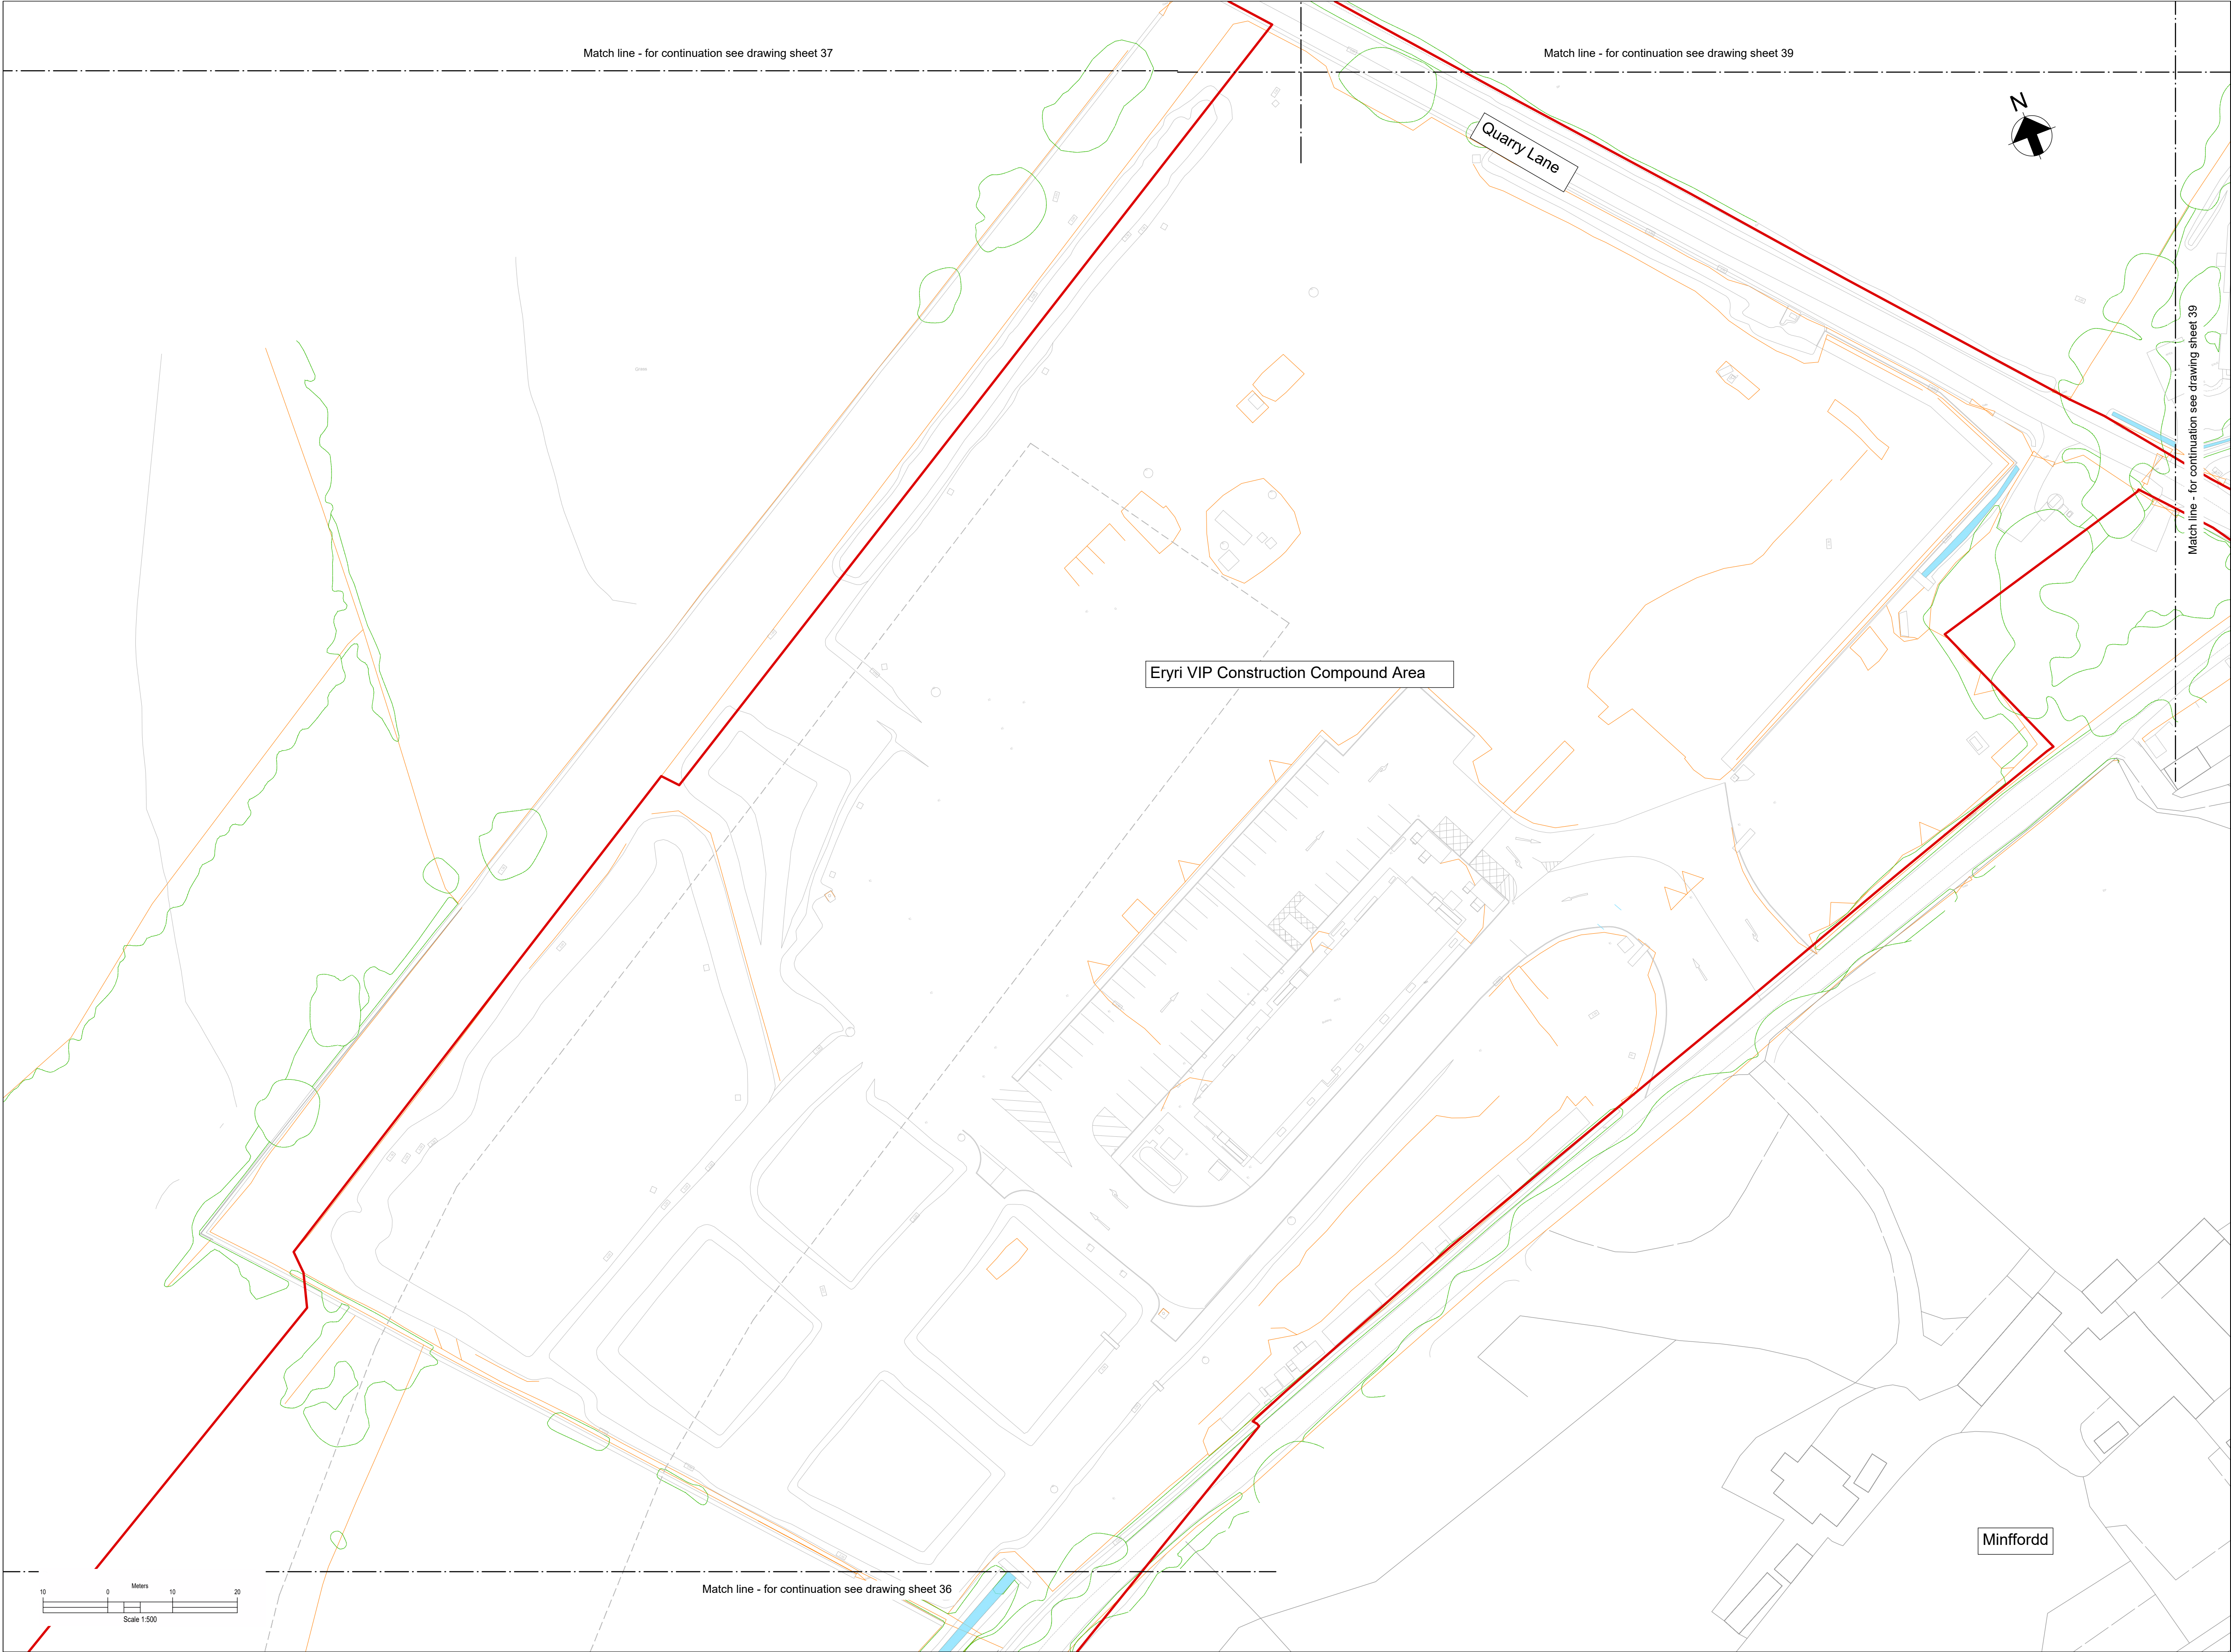
Key Plan

Notes:

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- Drawing to be printed in colour.
- All dimensions in metres unless otherwise stated.
- All levels are in meters Above Ordnance Datum (mAOD)
- Existing ground model and utilities information based on survey MGS54157 dated 08/09/23 and undertaken by Murphy Geospatial, with additional data from subsequent GPR.

Legend:

- Work site boundary
- Existing Watercourse
- Existing Fenceline
- Existing Gate
- Existing trees and vegetation



Key Plan

Notes:

- Do not scale from this drawing.
- Drawing to be printed in colour.
- All dimensions in metres unless otherwise stated.
- All levels are in meters Above Ordnance Datum (mAOD).
- Existing ground model and utilities information based on survey MGS54157 dated 08/09/23 and undertaken by Murphy Geospatial, with additional data from subsequent GPR.

Legend:


Work site boundary

Existing Watercourse

Existing Fenceline

Existing Gate

Existing trees and vegetation

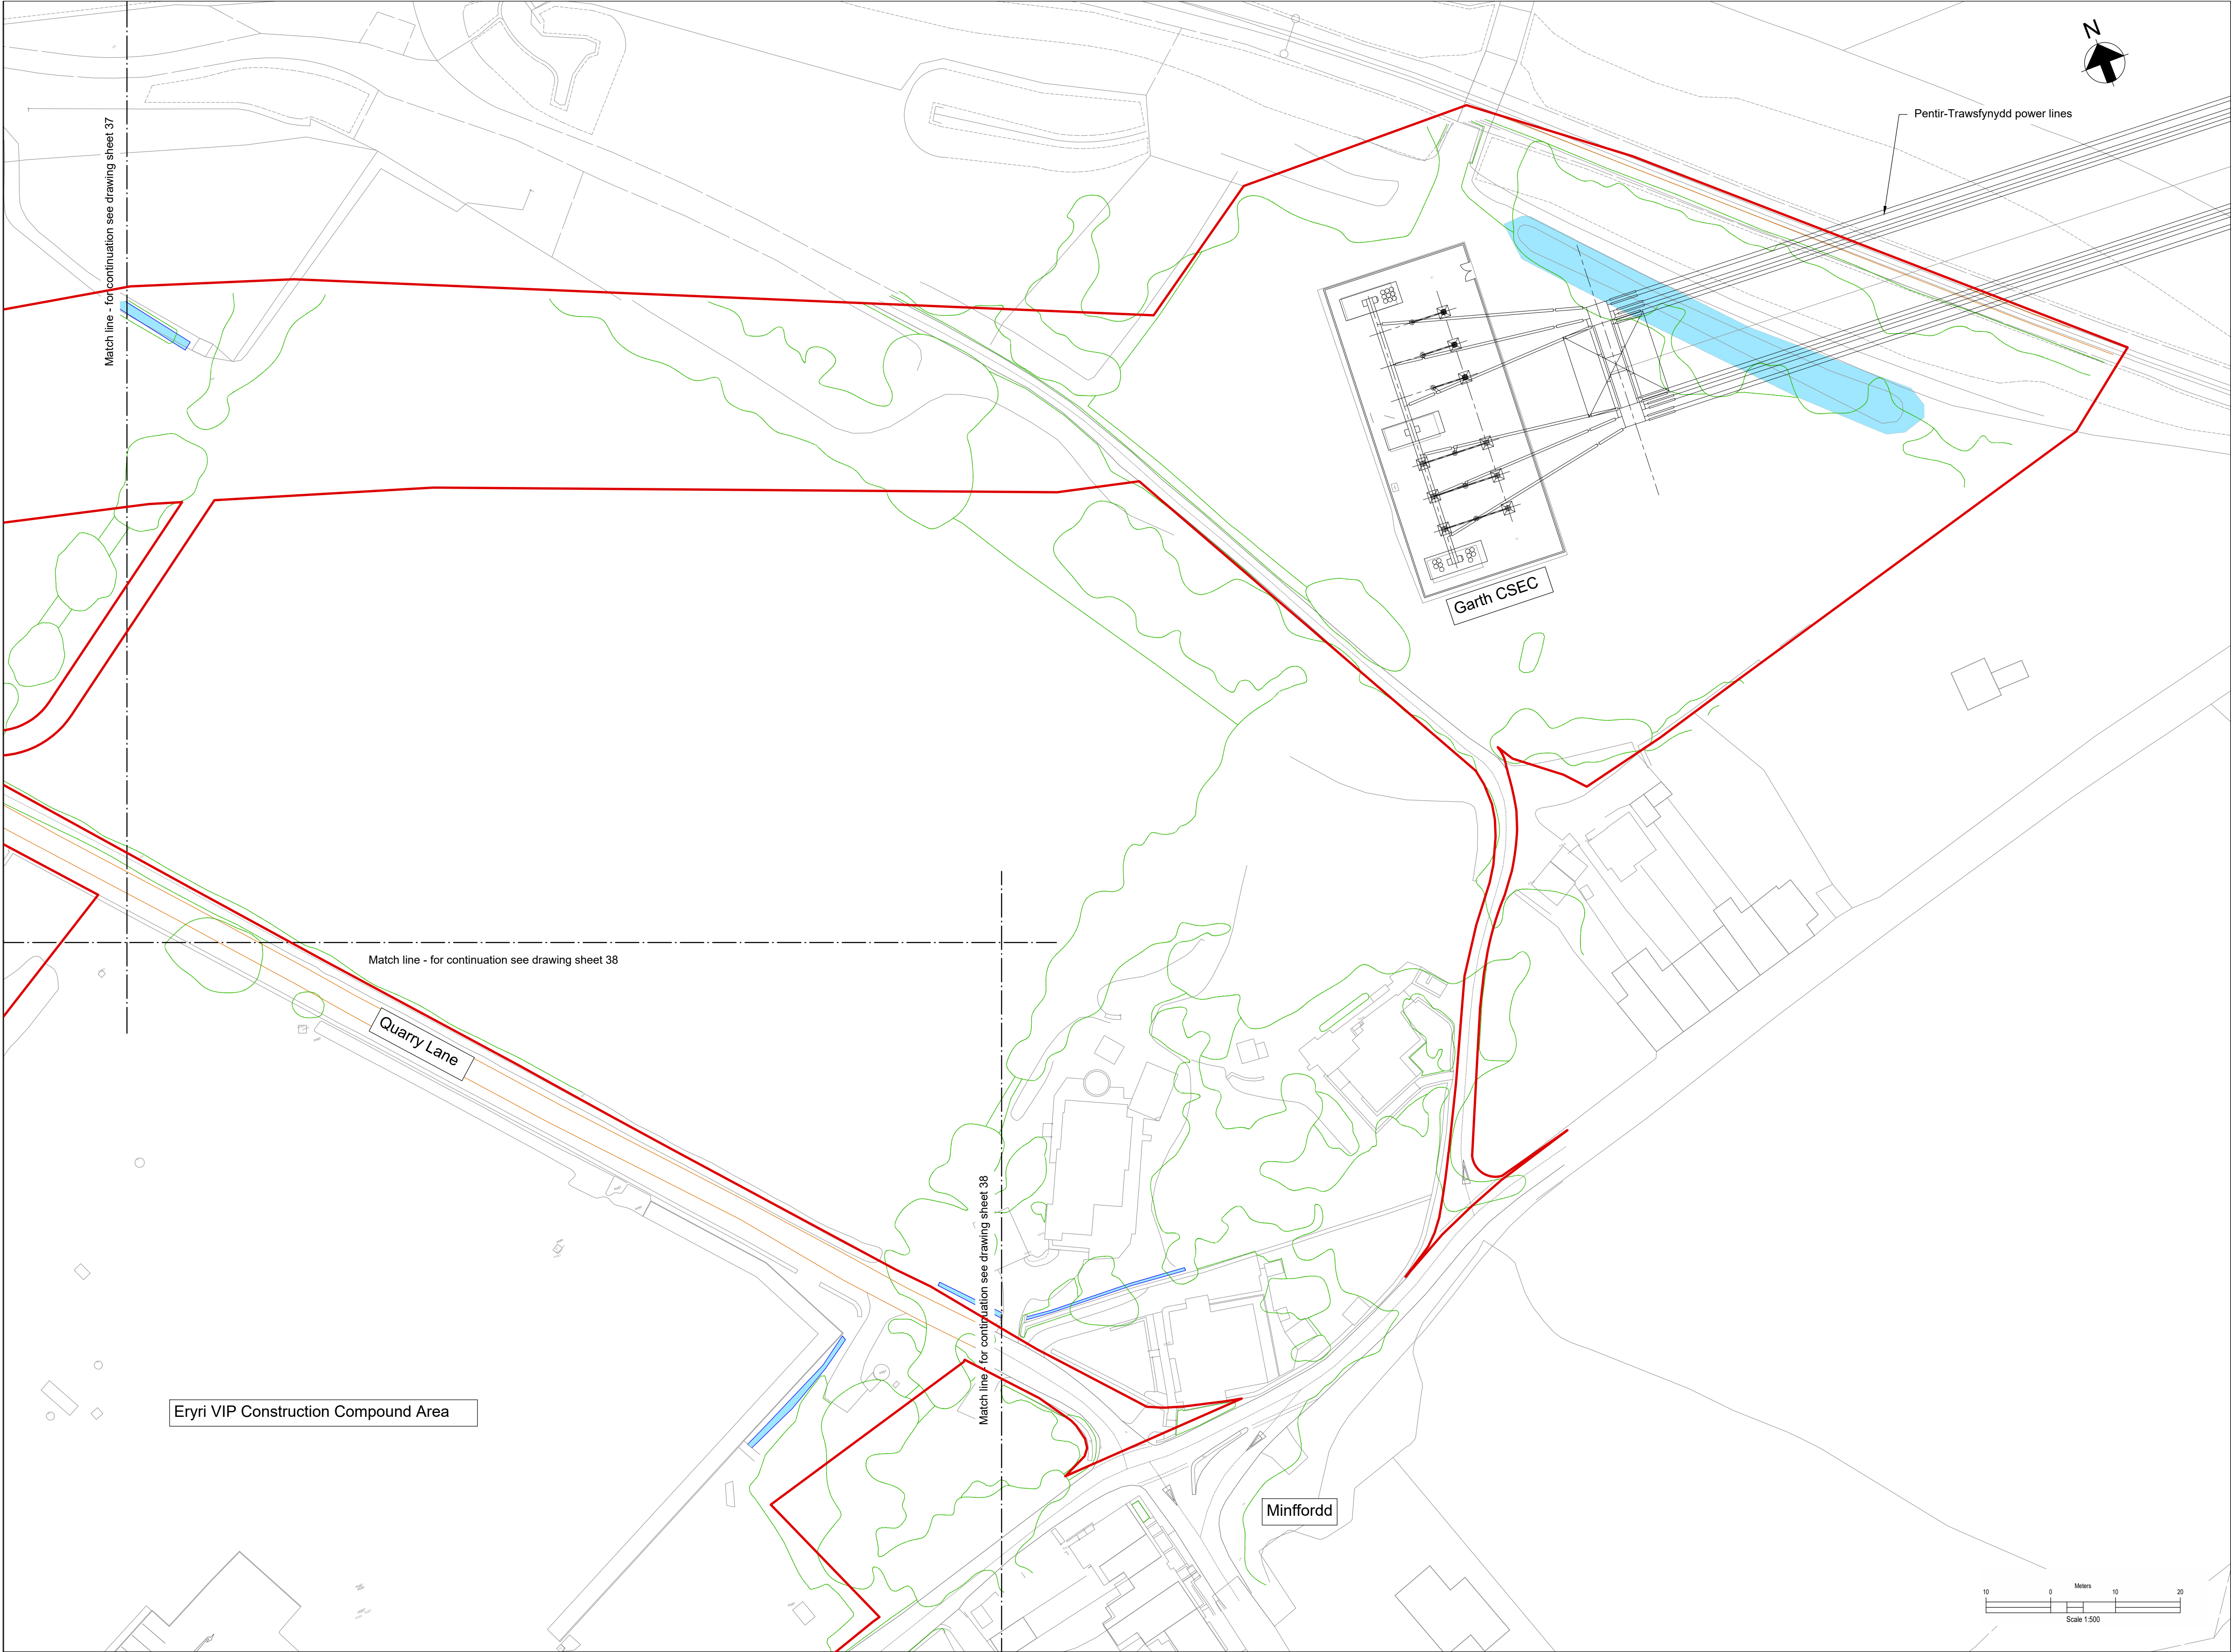

Key Plan

Notes:

- Do not scale from this drawing.
- Drawing to be printed in colour.
- All dimensions in metres unless otherwise stated.
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- Existing ground model and utilities information based on survey MGS54157 dated 08/09/23 and undertaken by Murphy Geospatial, with additional data from subsequent GPR.

Legend:

Work site boundary

Existing Watercourse

Existing Fenceline

Existing Gate

Existing trees and vegetation